

AREA TO BE DEMOLISHED

LIMIT OF WORK



MONUMENT SIGNAGE (VARIES)



EXISTING TREE TO REMAIN



TREE TO BE REMOVED

DEMOLITION NOTES

- A. REFERENCE THE PLANS FOR THE AREAS WHERE DEMOLITION IS TO BE PERFORMED. B. CONTRACTOR TO PERFORM SITE WALK PRIOR TO DEMOLITION TO VERIFY AREAS OF WORK AND ADVISE OWNER/LANDSCAPE ARCHITECT IF ADDITIONAL AREAS BEYOND THOSE SHOWN ON THE
- PLANS WILL BE IMPACTED BY THE PROJECT. C. IF ANY ADDITIONAL AREAS WITH BE IMPACTED BY THE PROJECT, COORDINATE PROTECTION AND RESTORATION OF THESE AREAS WITH OWNER PRIOR TO START OF DEMOLITION.

- A. COORDINATE WITH OWNER/LANDSCAPE ARCHITECT DURING PRE-DEMOLITION SITE WALK ON ITEMS AND MATERIALS TO BE SALVAGED. B. COORDINATE LOCATION AND MANNER OF STOCKPILING OR STORAGE PRIOR TO STARTING
- A. CONTRACTOR TO VERIFY LOCATION OF ALL IMPACTED TREES WITHIN THE LIMIT OF WORK B. IF TREE PROTECTION IS REQUIRED AS PART OF THE PERMIT, REFERENCE THE PROVIDED TREE
- C. IF TREE PROTECTION NOT REQUIRED BY PERMIT, COORDINATE TREE PROTECTION WITH
- OWNER/LANDSCAPE ARCHITECT DURING THE PRE-DEMOLITION SITE WALK. D. ASSUME NO IMPACTS WITHIN THE DRIPLINE OF TREES TO REMAIN.
- TEMPORARY SEDIMENTATION AND EROSION CONTROL
- A. IF REQUIRED AS PART OF THE PERMIT, REFERENCE THE PROVIDED SEC PLAN. B. IF NOT REQUIRED BY PERMIT, CONTRACTOR TO BE FAMILIAR WITH THE REQUIREMENTS OF THE SEC PLAN AND UTILIZE APPROPRIATE MEASURES TO MEET THE INTENT OF THE SEC PLAN.

PROTECT THESE ELEMENTS.

- A. ONCE EXTENTS OF WORK ARE DETERMINED, INSTALL HIGH VISIBILITY FENCING OR OTHER MEASURES TO DELINEATE THE BOUNDARY. B. FOR SITE ELEMENTS TO REMAIN WITHIN THE WORK AREA, USE APPROPRIATE MEASURES TO
- <u>UTILITIES</u> 1. CAP ALL UTILITIES AS NECESSARY, BUT DO NOT DISRUPT ANY SERVICES TO ADJACENT USES, TEMPORARY ROUTING OF SANITARY/STORM SEWER LINES, ELECTRICAL, WATER, TELEPHONE, GAS,
- ETC. TO BE IN PLACE BEFORE DEMO OF UTILITIES OCCUR. 2. ANY OTHER UTILITIES OR SERVICES THE CONTRACTOR MAY ENCOUNTER DURING THE PERFORMANCE OF THE WORK, NOTIFY THE OWNER IMMEDIATELY AND STOP WORK THAT MAY IMPACT THESE
- DEMOLITION
 A. DEMOLISH AND REMOVE ALL ELEMENTS SHOWN ON PLANS AND AS DETERMINED IN PRE-
- B. DISPOSE OF RESULTING DEBRIS AND DEMOLISHED MATERIALS OFF SITE IN A LEGALLY ACCEPTABLE LOCATION AND MANNER.

CITY OF PUYALLUP Planning Division
Approved Landscape Plan (253) 864-4165

Staff: NComstock Date: 12/15/2022

THIS APPROVAL IS VOID AFTER 180 DAYS FROM APPROVAL DATE. THE CITY IS NOT RESPONSIBLE FOR ERRORS OR OMISSIONS ON THESE PLANS. FIELD CONDITIONS MAY DICTATE CHANGES TO THESE PLANS AS DETERMINED BY THE PLANNING DIRECTOR, DESIGNEE, OR PROJECT PLANNER.

NOTE: If street trees are required, Call Planning
Division for final inspection: (253) 864-4165 (Option 3)
Root barriers are required around street trees in accordance with city standard detail. Top soil shall be installed in accordance with city standards - field verification required. Failure to install top soil and root barriers in accordance with the city standards may result in rejection of installation.

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CITY OF PUYALLUP STAMP AREA

TRAIL WEST

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REVISION DATE

DESCRIPTION

ISSUANCES

DATE DESCRIPTION

4/22/2022 CONSTRUCTION DOCUMENTS 8/26/2022 CIVIL PERMIT DOCUMENTS


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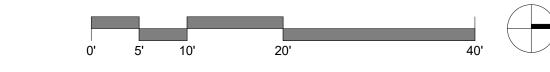
BOARD & VELLUM PROJECT #: 2021089.00 PUYALLUP PROJECT #:

PLOT DATE:

DEMO PLAN - E. MAIN AVE -CENTRAL

04.19.2022



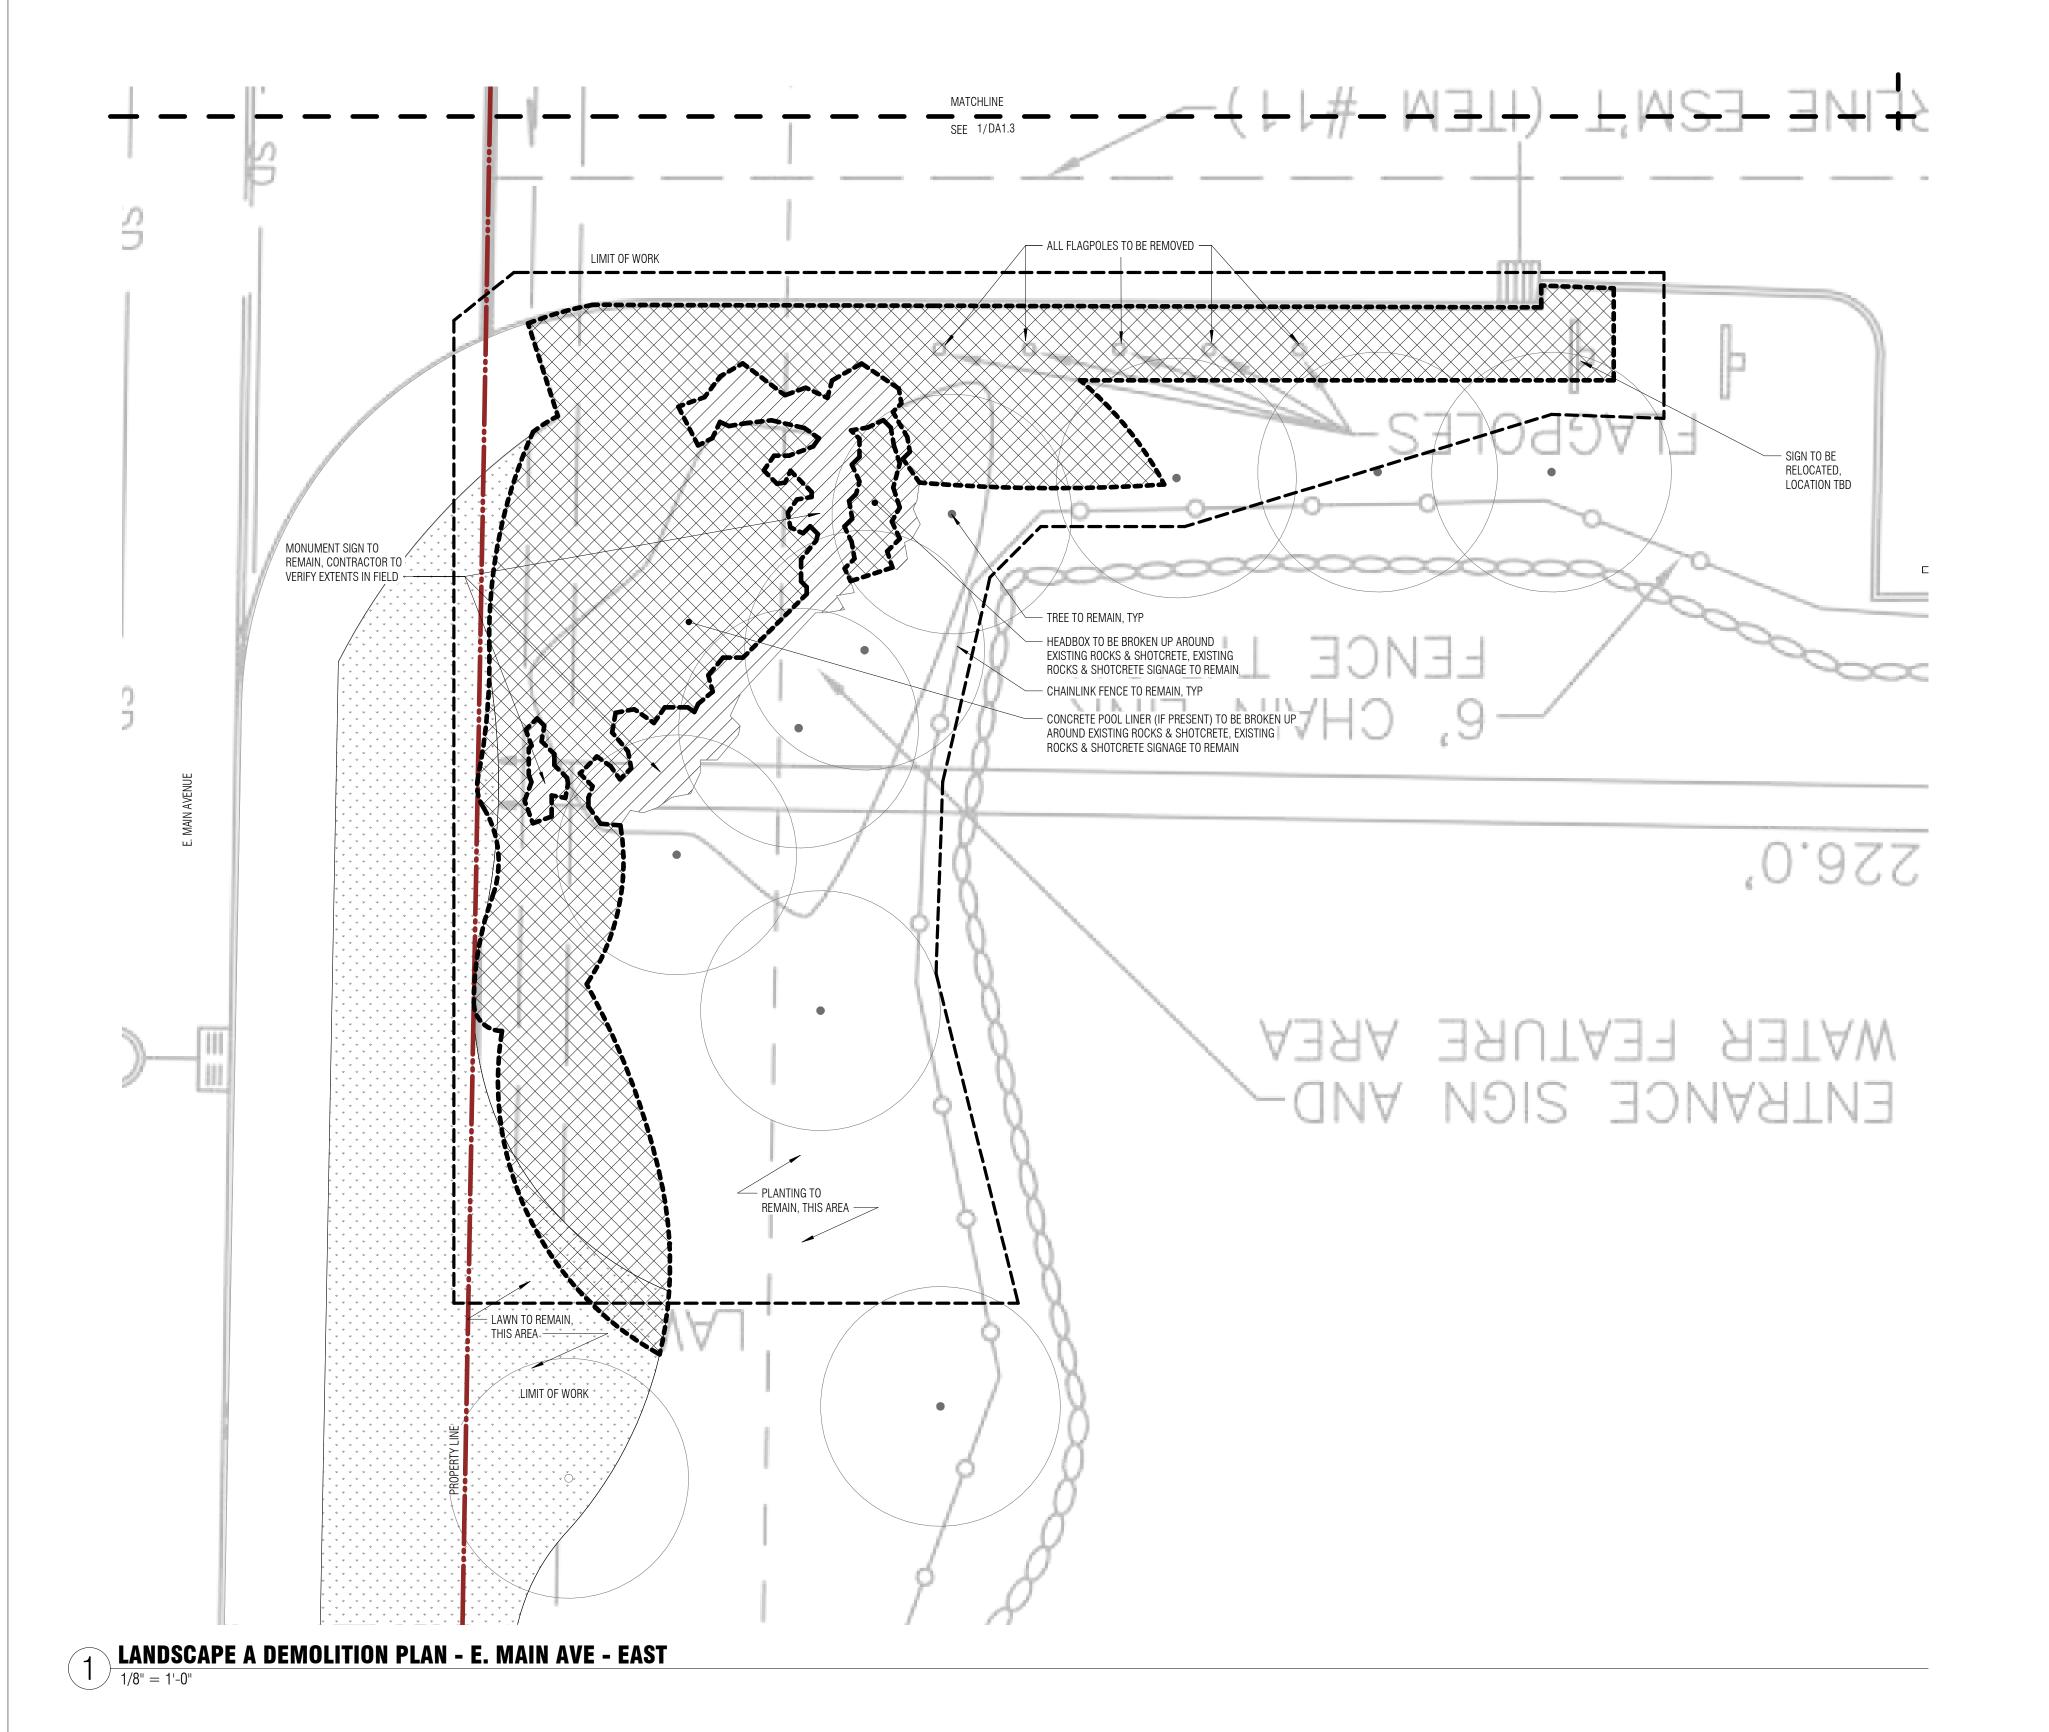

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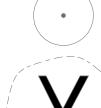
DEMOLITION LEGEND

AREA TO BE DEMOLISHED

LIMIT OF WORK

MONUMENT SIGNAGE (VARIES)

EXISTING TREE TO REMAIN





TREE TO BE REMOVED



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- B. COORDINATE LOCATION AND MANNER OF STOCKPILING OR STORAGE PRIOR TO STARTING
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- B. FOR SITE ELEMENTS TO REMAIN WITHIN THE WORK AREA, USE APPROPRIATE MEASURES TO PROTECT THESE ELEMENTS.
- 1. CAP ALL UTILITIES AS NECESSARY, BUT DO NOT DISRUPT ANY SERVICES TO ADJACENT USES, TEMPORARY ROUTING OF SANITARY/STORM SEWER LINES, ELECTRICAL, WATER, TELEPHONE, GAS,
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- B. DISPOSE OF RESULTING DEBRIS AND DEMOLISHED MATERIALS OFF SITE IN A LEGALLY ACCEPTABLE LOCATION AND MANNER.

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CITY OF PUYALLUP STAMP AREA

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REVISION DATE

4/22/2022 CONSTRUCTION DOCUMENTS 8/26/2022 CIVIL PERMIT DOCUMENTS

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BOARD & VELLUM PROJECT #: 2021089.00 PUYALLUP PROJECT #:

PLOT DATE: 04.19.2022

DEMO PLAN - E. MAIN AVE -


EAST

AREA TO BE DEMOLISHED

LIMIT OF WORK



MONUMENT SIGNAGE (VARIES)

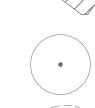

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Salvellum

Dard K

115 15th Avenue East, Suite Seattle, Washington 98112 Architecture Interiors Site



CITY OF PUYALLUP STAMP AREA

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AMENI
ANDRESS:
PROJECT ADDRESS:
1617 E MAIN AVE
PUYALLUP, WA 9837
OWNER:

REVISION DATE DESCRIPTION

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DATE DESCRIPTION

4/22/2022 CONSTRUCTION DOCUMENTS
8/26/2022 CIVIL PERMIT DOCUMENTS

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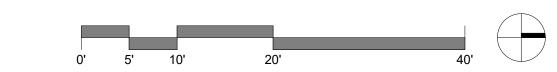
BOARD & VELLUM PROJECT #: 2021089.00
PUYALLUP PROJECT #: TBD


PLOT DATE: 04.19.2022

DEMO PLAN - EAST ENTRY -SOUTH

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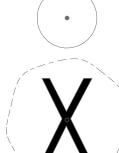




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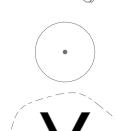
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CITY OF PUYALLUP STAMP AREA
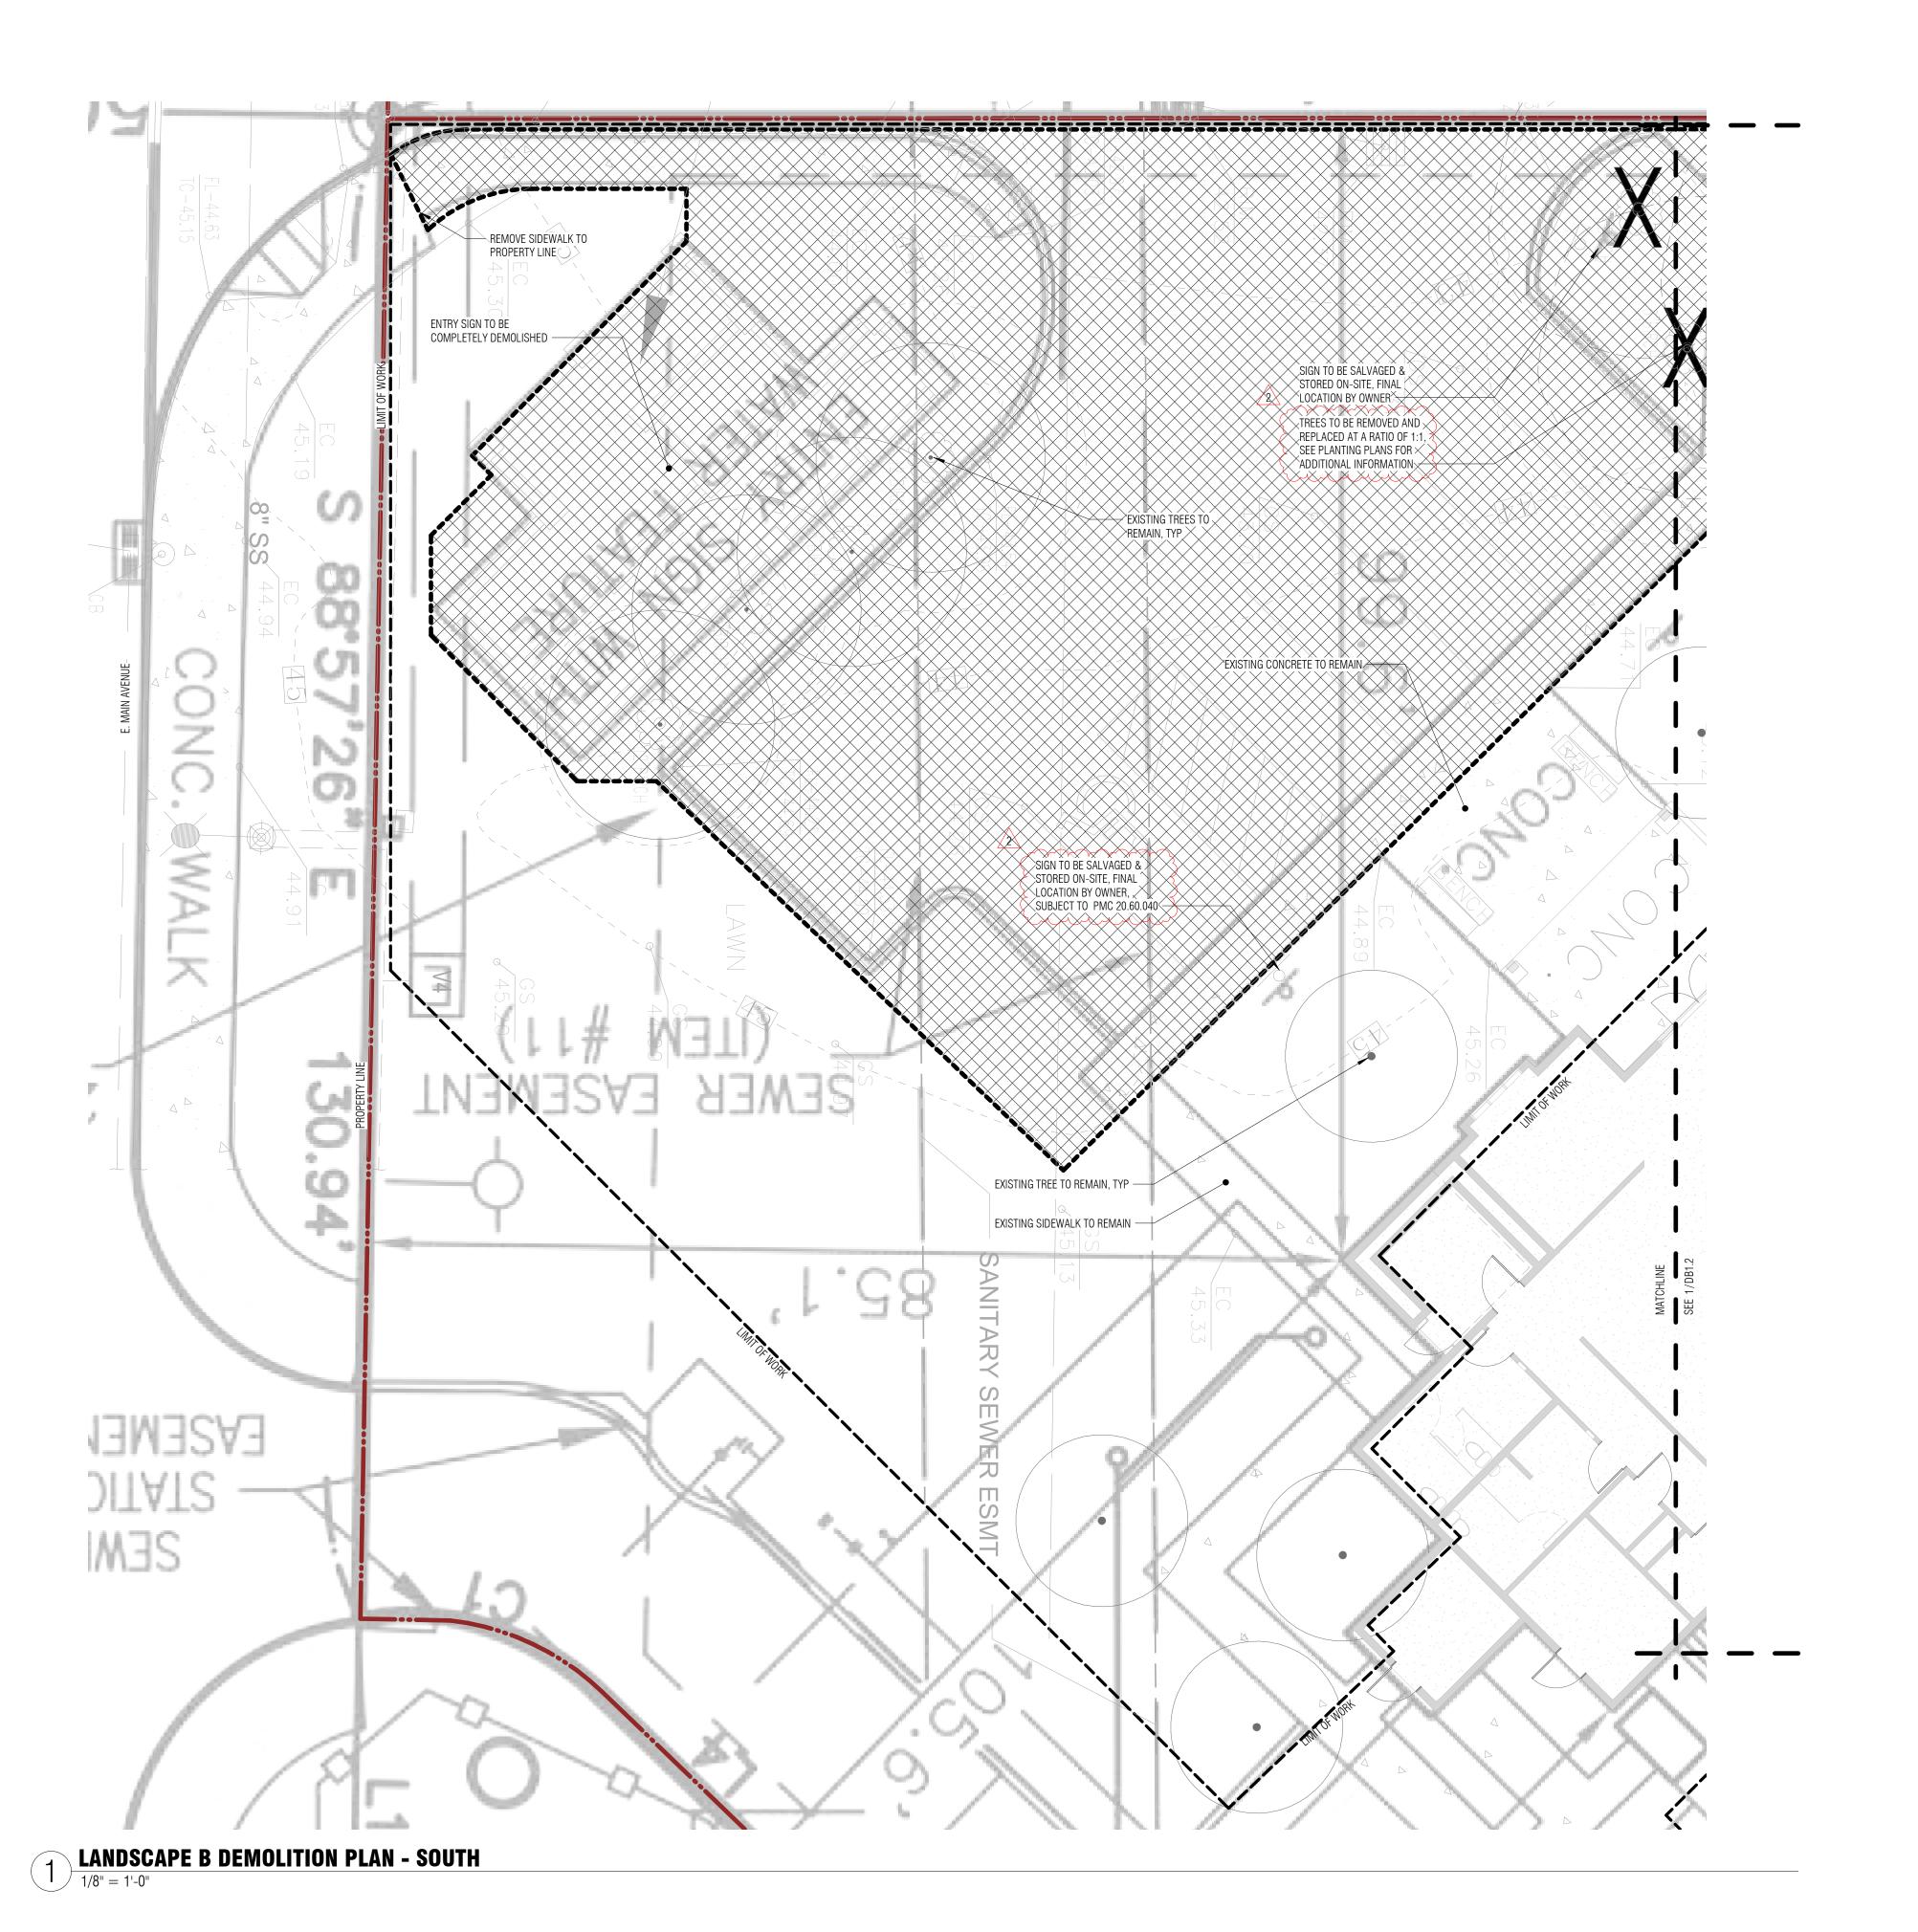
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4/22/2022 CONSTRUCTION DOCUMENTS 8/26/2022 CIVIL PERMIT DOCUMENTS


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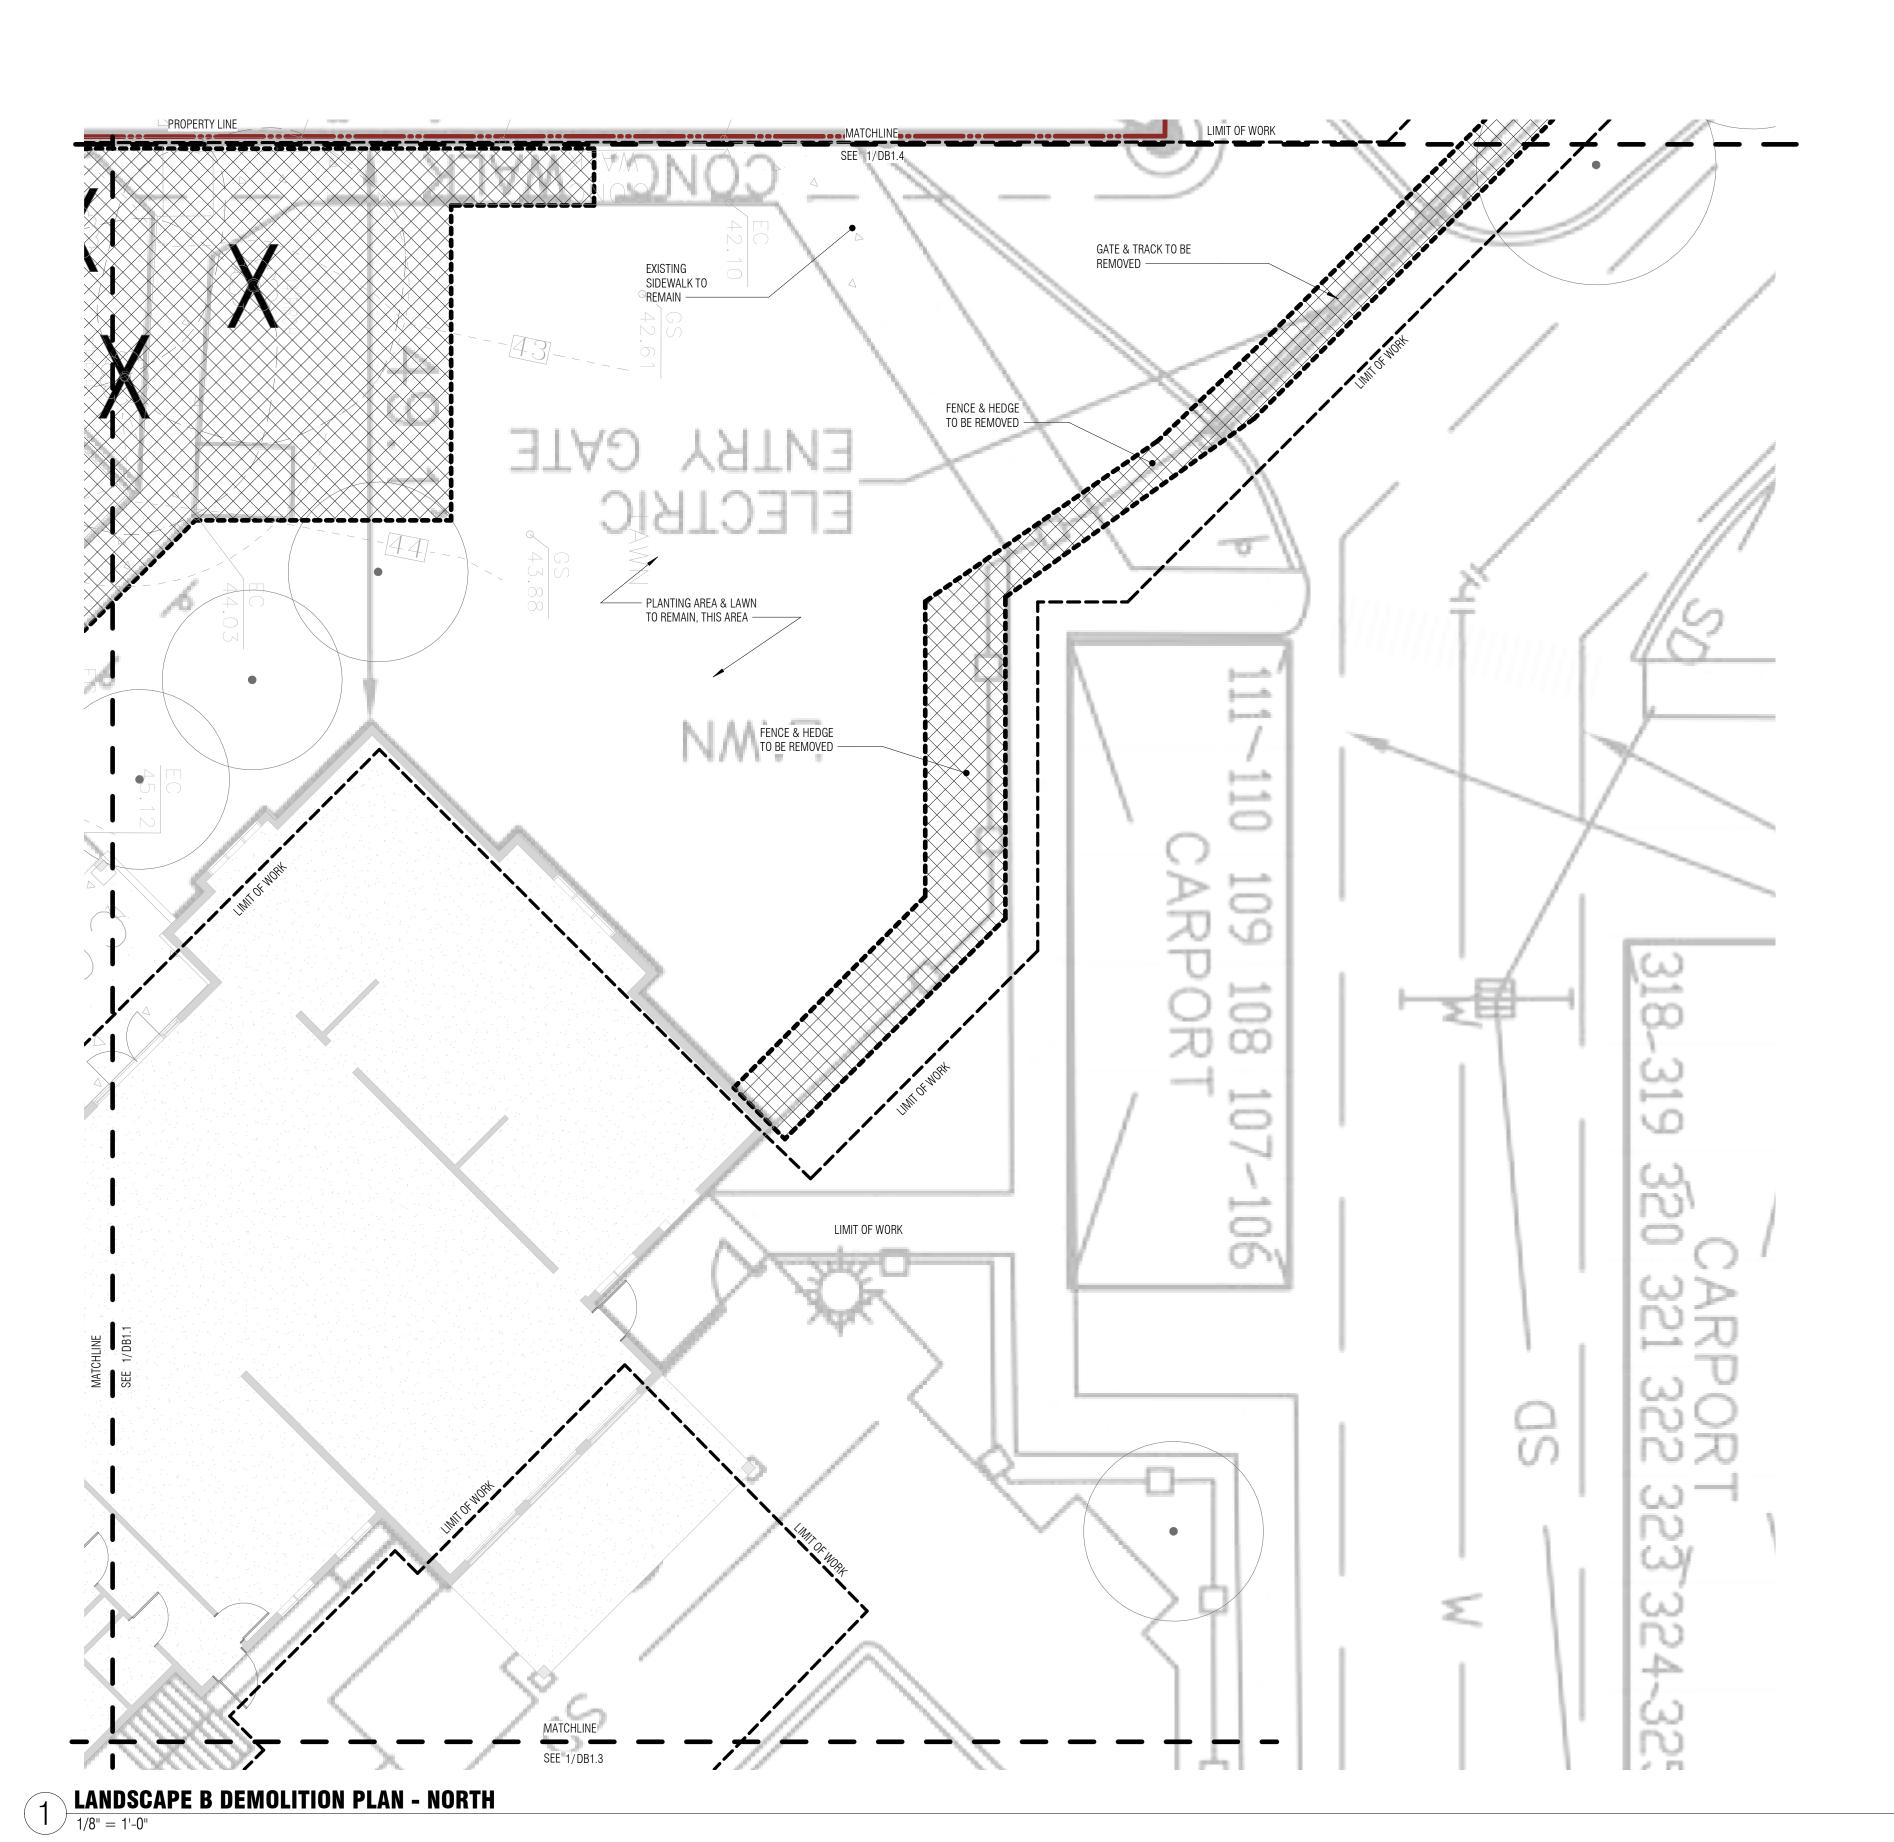
BOARD & VELLUM PROJECT #: 2021089.00 PUYALLUP PROJECT #:

PLOT DATE:

DEMO PLAN - SOUTH

04.19.2022



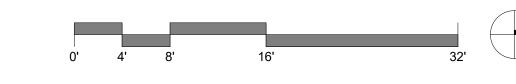

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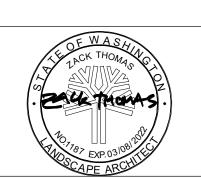
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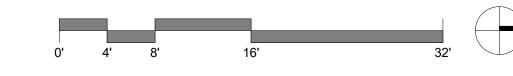
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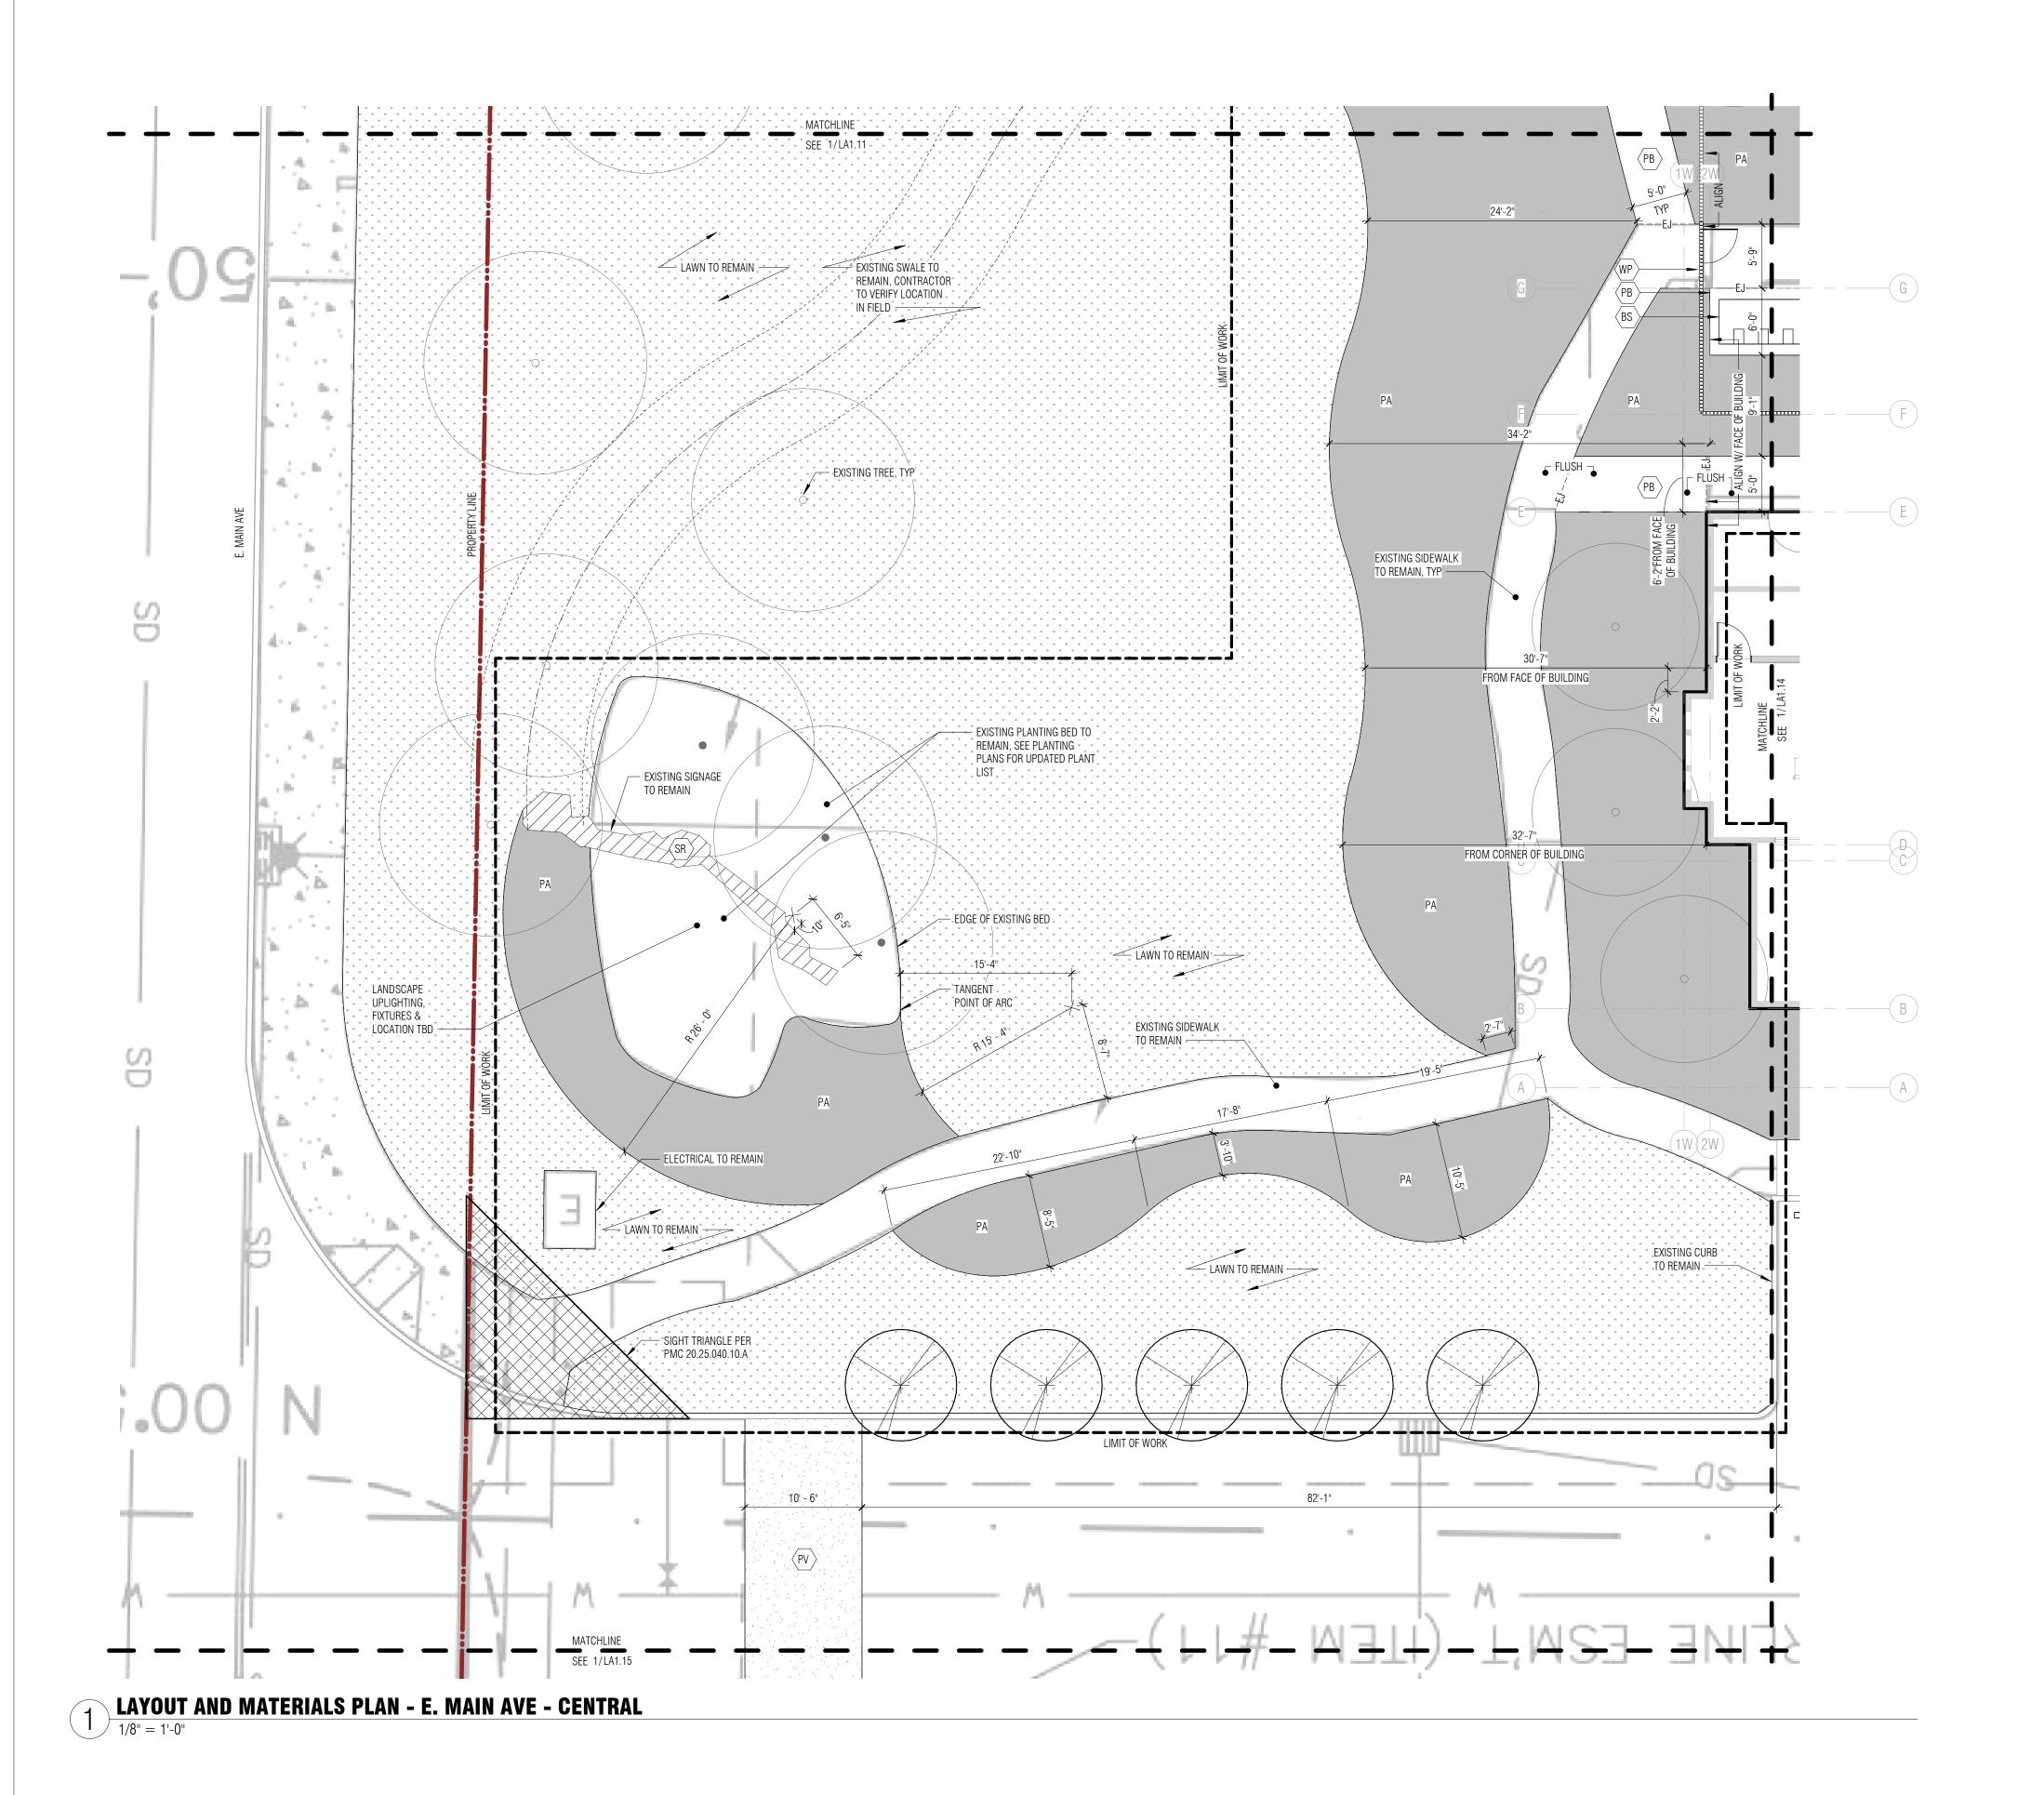
BOARD & VELLUM PROJECT #: 2021089.00 PUYALLUP PROJECT #:

04.19.2022

PLOT DATE:

DEMO PLAN - NORTH





TAG		DESCRIPTION	DETAIL
PB	EJ	CIP CONCRETE AND SCORING	2/L5.11
(PP)		CIP CONCRETE WITH INTEGRAL COLOR COLOR: DAVIS COLOR DUNE 6058	1/L5.11
(PO)	[CIP CONCRETE WITH HEAVY SALT ROCK FINISH TO MATCH EXISTING	1/L5.11
⟨SR⟩		MONUMENTAL SIGNAGE	
(AT)		ASPHALT	SEE CIVIL
PA		PLANTING AREA	
TG	, PA	GRASS LAWN	
(WC)		6" CIP CONCRETE CURB	SEE CIVIL
⟨SW⟩		18" HT CIP CONCRETE SEATWALL	3/L5.11
⟨WP⟩		METAL POOL FENCING & GATE	PER MANUF
(BS)		ELECTRIC BIKE STATION	OFCI
		PROPERTY LINE	
		LIMIT OF WORK	



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CITY OF PUYALLUP STAMP AREA

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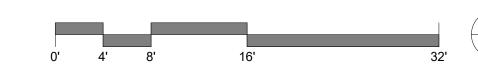
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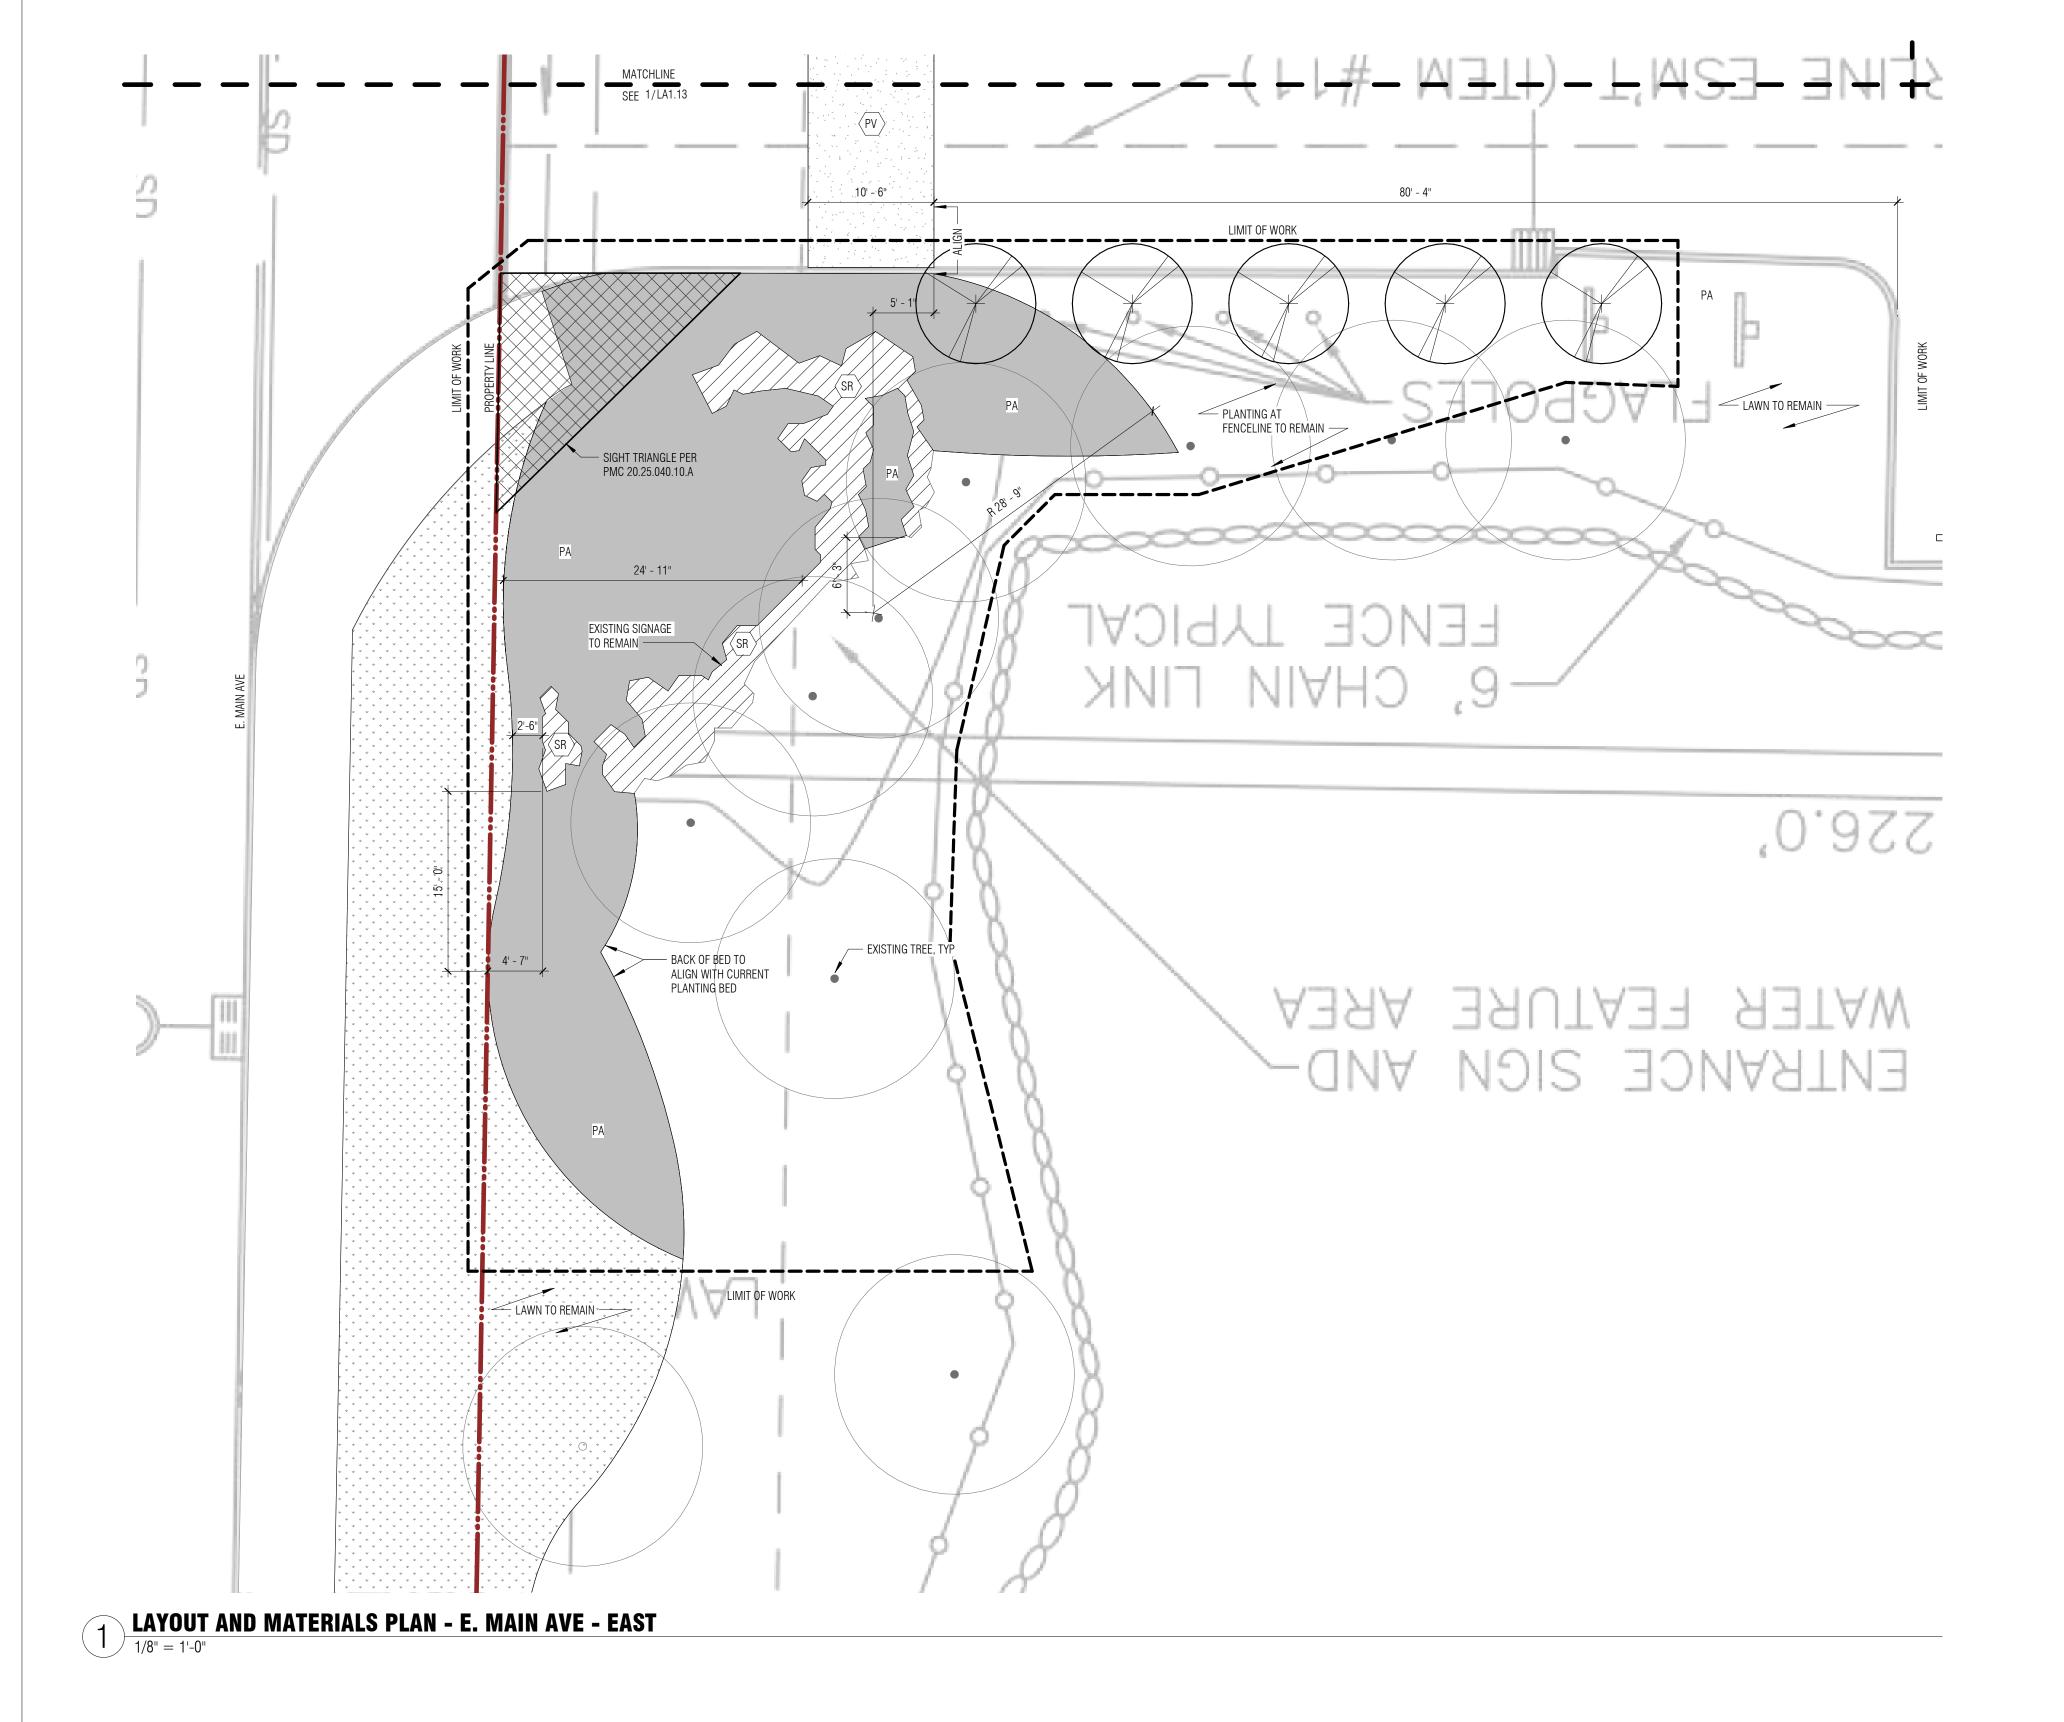
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PUYALLUP PROJECT #:

LAYOUT AND MATERIALS PLAN - E. MAIN AVE -CENTRAL





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TAG		DESCRIPTION	DETAIL
⟨PB⟩	EJ	CIP CONCRETE AND SCORING	2/L5.11
(PP)		CIP CONCRETE WITH INTEGRAL COLOR COLOR: DAVIS COLOR DUNE 6058	1/L5.11
(P0)	-, -,	CIP CONCRETE WITH HEAVY SALT ROCK FINISH TO MATCH EXISTING	1/L5.11
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		PROPERTY LINE	
		LIMIT OF WORK	
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⟨PB⟩	<u> </u>	CIP CONCRETE AND SCORING	2/L5.11
(PP)		CIP CONCRETE WITH INTEGRAL COLOR COLOR: DAVIS COLOR DUNE 6058	1/L5.11
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⟨WP⟩		METAL POOL FENCING & GATE	PER MANUF
(BS)		ELECTRIC BIKE STATION	OFCI
		PROPERTY LINE	
		LIMIT OF WORK	

LAYOUT AND MATERIAL NOTES

LAYOUT PRIOR TO BEGINNING WORK.

BUILDING AND STRUCTURE.

OR FUNCTIONAL, ARE SHOWN ON THESE DRAWINGS.

ARCHITECT PRIOR TO CONSTRUCTION OR INSTALLATION.

ANGLES ARE ASSUMED TO BE 90 DEGREES UNLESS NOTED OTHERWISE.

1. ALL CONCRETE JOINTS TO BE TOOLED WITH 1/4" RADIUS UNLESS SHOWN OTHERWISE. NO TOOL MARKS OR SHINERS.

DISCREPANCIES TO LANDSCAPE ARCHITECT. CONTRACTOR TO OBTAIN LANDSCAPE ARCHITECT'S FINAL APPROVAL OF

THESE CONTRACT DOCUMENTS MAKE NO REPRESENTATIONS AS TO THE MEANS AND METHODS OF CONSTRUCTION. CONTRACTOR SHALL CONTACT LANDSCAPE ARCHITECT OF ANY UNFORSEEN CONDITIONS WHICH MAY AFFECT THE

THE USER OF THESE DRAWINGS IS CAUTIONED THAT UNDERGROUND UTILITIES AND FOUNDATIONS AS SHOWN ARE NOT

GUARANTEED NOR IS THERE ANY GUARANTEE THAT ALL EXISTING UTILITIES AND FOUNDATIONS, WHETHER ABANDONED

DIMENSIONS AND RADII FOR EDGES, STEPS, WALLS & PAVEMENTS ARE TO EXPOSED FACES UNLESS NOTED OTHERWISE.

INTENDED DESIGN AS SET FORTH IN THE DRAWINGS BEFORE PROCEEDING WITH CONSTRUCTION.

INSTALL ISOLATION JOINTS IN CONCRETE PAVING ABUTTING CURBS, STEPS AND OTHER FIXED OBJECTS. DO NOT SCALE DRAWINGS; CONSULT LANDSCAPE ARCHTECT FOR ANSWERS TO ALL DIMENSIONAL QUESTIONS.


10. ANY CHANGES PROPOSED TO DIMENSIONS SHOWN ON THIS DRAWING SHALL BE APPROVED BY THE LANDSCAPE

12. STRUCTURAL ENGINEER TO REVIEW AND APPROVE STRUCTURAL CONNECTIONS OF METAL POSTS AND WIRES TO

11. ALL STRUCTURES TO REMAIN SHALL BE PROTECTED UNLESS OTHERWISE NOTED TO BE DEMOLISHED.

$\langle PB \rangle$	<u> </u>	CIP CONCRETE AND SCORING	2/L5.11
(PP)		CIP CONCRETE WITH INTEGRAL COLOR COLOR: DAVIS COLOR DUNE 6058	1/L5.11
(PO)	-> -	CIP CONCRETE WITH HEAVY SALT ROCK FINISH TO MATCH EXISTING	1/L5.11
$\langle SR \rangle$		MONUMENTAL SIGNAGE	
$\langle AT \rangle$		ASPHALT	SEE CIVIL
$\langle PA \rangle$		PLANTING AREA	
TG	Ţ PA Ţ	GRASS LAWN	
⟨WC⟩		6" CIP CONCRETE CURB	SEE CIVIL
$\langle SW \rangle$		18" HT CIP CONCRETE SEATWALL	3/L5.11
$\langle WP \rangle$		METAL POOL FENCING & GATE	PER MANUF
(BS)		ELECTRIC BIKE STATION	OFCI
		PROPERTY LINE	
		LIMIT OF WORK	

MATERIALS LEGEND

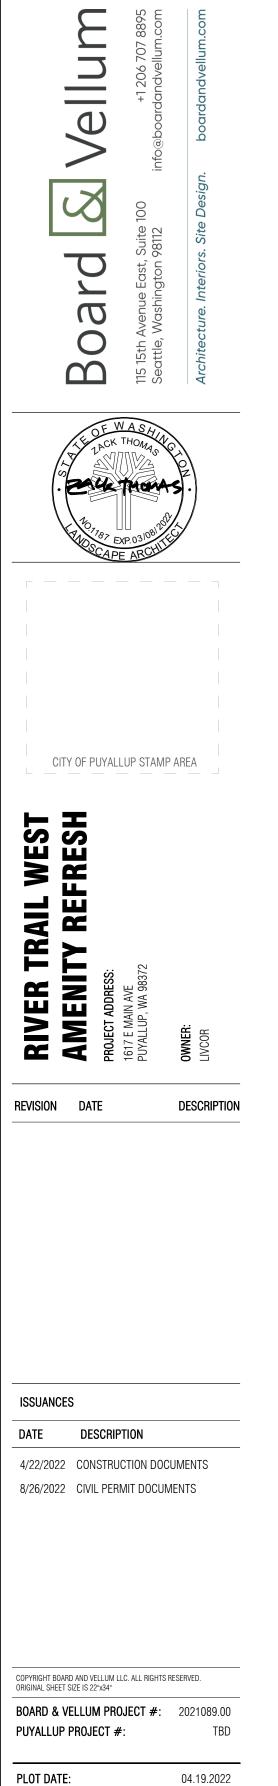

LAYOUT AND MATERIALS PLAN - E. MAIN AVE - EAST

SHEET NO.:

O' 4' 8' 16' LA1.15

PLANT SCHEME

BOTANICAL NAME / COMMON NAME

<u>UPPER BANK</u>

ARCTOSTAPHYLOS UVA-URSI / KINNIKINNICK CALAMAGROSTIS ACUTIFLORA / KARL FOERSTER FEATHER REED GRASS CALLUNA VULGARIS 'SPRING TORCH' - SPRING TORCH HEATHER CAMASSIA QUAMASH / CAMAS CORNUS SERICEA 'KELSEYI' / KELSEY RED TWIG DOGWOOD DESCHAMPSIA CESPITOSA / TUFTED HAIR GRASS ERICA X DARLEYENSIS 'WHITE PERFECTION' / WHITE PERFECTION HEATH IRIS SSP / PACIFIC COAST IRIS PIERIS JAPONICA / JAPANESE ANDROMEDA RHODODENDRON SSP. / VARIOUS AZALEA RHODODENDRON DAVIESII / DWARF WHITE AZALEA RHODODENDRON X 'CUNNINGHAMS WHITE' / CUNNINGHAMS WHITE RHODODENDRON SESLARIA AUTUMNALIS / AUTUMN MOOR GRASS

RIVERSIDE



ARCTOSTAPHYLOS UVA-URSI / KINNIKINNICK CAMASSIA QUAMASH / CAMAS SESLARIA AUTUMNALIS / AUTUMN MOOR GRASS

VIBURNUM DAVIDII / DAVID VIBURNUM

RIVERINE GRASSES

 $\nabla \nabla \nabla \nabla \nabla \nabla \nabla$

FLOWERING MEADOW

CAMASSIA QUAMASH / CAMAS DESCHAMPSIA CESPITOSA / TUFTED HAIR GRASS SESLARIA AUTUMNALIS / AUTUMN MOOR GRASS

CALAMAGROSTIS ACUTIFLORA / KARL FOERSTER FEATHER REED GRASS

PRO TIME PT 710 FLOWERING MEADOW MIX

PLANT SCHEDULE

BOTANICAL NAME

AUUK KINIKINNICK

TREES					
QTY.	TAG	BOTANICAL NAME	COMMON NAME	CAL. MIN. HT	CONT. REMARKS
3 13	ABTM MRSC	ACER BUERGERIANUM MALUS 'JFS KW213MX' PP 31008	TRIDENT MAPLE RASPBERRY SPEAR CRABAPPLE	1 1/2" 0"	B&B BRANCHED WITH A STRONG, CENTRAL LEADER
		MALES STOTAL TOMANT STOCK	The Beauty of Earl State Leaves	/2 \ \ \ \ \ \ \ \ \ \ \ \ \ \ \ \ \ \ \	Signification of the state of t
<u>SHRUBS</u>					
QTY.	TAG	BOTANICAL NAME	COMMON NAME	2 CONT.	MIN. SPACING REMARKS
83	CAKF	CALAMAGROTSIS ACUTIFLORA	KARL FOERSTER FEATHER REED GRASS	2 GAL	2' - 0"
52	CQCB	CAMASSIA QUAMASH	CAMAS	2 GAL	3' - 0"
20	CSRT	CORNUS SERICEA 'KELSEYI'	RED TWIG DOGWOOD	2 GAL 🔾	2' - 6"
190	DCTH	DESCHAMPSIA CESPITOSA	TUFTED HAIR GRASS	> 2 GAL -	2' - 6"
11	RCHR	RHODODENDRON X 'CUNNINGHAM'S WHITE' (H-2)	CUNNINGHAM'S WHITE RHODODENDRON	3 GAL	4' - 0"
545	SAAM	SESLARIA AUTUMNALIS	AUTUMN MOOR GRASS	2 GAL	3' - 0"
00011110	001/50				
GROUND	COVEK				

COMMON NAME

ARCTOSTAPHYLOS UVA-URSI

SIZE SPACING

www....

SPACING REMARKS

1' - 6"

PLANTING NOTES

ESTIMATED TOTAL CUBIC YARDS OF TOP SOIL REQUIRED TO MEET REQUIREMENTS: 400 CUBIC YARDS

A. INSTALLATION OF AN IRRIGATION SYSTEM WITH AN AUTOMATIC CONTROLLER IS RECOMMENDED.

 PLANTING/LAWN AREA PREPARATION AND SOIL AMENDMENT A. CONFORM TO SECTION 8.2 (A) OF THE VEGETATION MANAGEMENT STANDARDS (VMS) FOR ALL AREAS OF PLANTING AND LAWN WORK.

2'-0" MIN

1'-6", SEE

NOTE 2

SIDEWALK

SEE NOTE 1

MIN WIDTH OF TREE PIT = 2TIMES ROOTBALL

DIAMETER OR 5'-0", WHICHEVER IS GREATER

MULCH AREA TO BE CLEAR OF GRASS, WEEDS,

ETC. TO REDUCE COMPETITION WITH TREE ROOTS

B. DO NOT WORK SOILS IF TOO WET. CONTACT OWNER IF SOILS ARE VISIBLY WET. C. WATER IN SOILS AFTER PLACING. ALLOW 24 HOURS FOR SOILS TO SETTLE AND FILL LOW SPOTS

A. SEEDED LAWNS: USE SEED MIX RECOMMENDED FOR SOLAR CONDITIONS OF THE NEW LAWN AREA. APPLY SEED AT RATE RECOMMENDED BY SUPPLIER AND WATER AREA. B. SOD: USE A SAND-BASED, NON-NETTED SOD SIMILAR TO PRODUCT SUPPLIED BY COUNTRY GREEN. INSTALL SOD AS RECOMMENDED BY SUPPLIER AND WATER AREA.

C. MONITOR SOIL MOISTURE AND APPLY WATER AS NEEDED UNTIL GRASS OR SOD IS ESTABLISHED (MIN 30 DAYS).

PLANTING INSTALLATION

A. PROVIDE FROM A RECOGNIZED NURSERY GROWN IN ACCORDANCE WITH GOOD HORTICULTURAL PRACTICES. PROVIDE ONLY HEALTHY, VIGOROUS STOCK FREE OF DISEASE, AND DEFECTS SUCH AS INJURIES, ABRASIONS OR DISFIGUREMENT. PROVIDE PLANTS IN VARIETIES AND SIZES INDICATED ON PLANTING PLAN. NOTIFY OWNER IF PLANTS SPECIES, VARITIES, SIZES OR QUANTITIES ARE UNAVAILABLE TO COORDINATE SUBSTITUTIONS.

LAYOUT PLANTS ON SOIL SURFACE FOR REVIEW AND APPROVAL BY OWNER. INSTALL PLANTS IMMEDIATELY AFTER LAYOUT APPROVED. Ť D. Ť MŮĽCH ŘŘEAŠ IMMĚDIATELY AFTEŘ PLÁNTING WITH MIŇÍMUM 4" ĎE SHŘEDĎĚD HÁRDWÔOD MUĽČH TŎ MAŤCH ŠPĒCIFICATÍON ŎF VMŠ. BAŠÍS-ŎF-DEŠIGN PRODÚCT ÍS LAŇDSCÁPE MŮLCH AS SUPPLIED BY, CEDAR GROVE. E. MONTOR SOIL MOISTURE AND APPLY WATER AS NEEDED UNTIL PROJECT IS COMPLETED AND HANDED OVER TO OWNER.

1. INSTALLATION INCLUDES REMOVAL OF STAKES ONE YEAR

2. SHAPE SOIL SURFACE TO PROVIDE 3' DIAMETER

STAKE TREE WITH (2) TREATED 2" DIAMETER LODGEPOLE PINE DOWELED TREE STAKES

(8'-0" LENGTH) LOOP EACH TIE AROUND HALF TREE LOOSELÝ TO PROVIDE 1" SLACK FOR

"CHAINLOCK" OR EQUAL TREE TIE MATERIAL (1" WIDTH) NAIL OR STAPLE

TREE TIE MATERIAL TO STAKE TO

HOLD VERTICALLY. LOOP EACH TIE

AROUND HALF TREE LOOSELY TO PROVIDE 1" SLACK FOR TRUNK

SET TOP OF ROOT CROWN 2" ABOVE

- 2"-3" MULCH DEPTH (TAPERED AT

ADJACENT CURB AND SIDEWALK GRADE

MULCH TREE PIT MIN 5'-0" LENGTH X FULL

PLANTING STRIP WIDTH BETWEEN CURB AND

SIDEWALK (FOR PLANTING STRIPS LESS THAN

6'-0" WIDE.) PROVIDE 5'-0" MULCH RING FOR PLANTING STRIPS WIDER THAN 6'-0"

REMOVE ALL WIRE & STRING, AND REMOVE

ADJACENT PAVING/CURB

18" DEEP ROOT BARRIER TYP.

*DRIVE STAKES 6" TO 1'-0" INTO

UNDISTURBED SOIL BELOW

ROOTBALL

DRIVE STAKE AT ROOTBALL EDGE (TYP)

NATIVE BACKFILL SOIL AMENDMENT

TREE PIT AREA X ROOTBALL DEPTH

WITH 25% (@1/3 CU YD) DECOMPOSED ORGANIC MULCH AMENDMENT FOR ENTIRE

UNDISTURBED SUBGRADE (PROVIDES FIRM

BASE SO THAT ROOTBALL WILL NOT SINK)

WITHIN 10' OF PAVING

OVEREXCAVATION)

 ROUGHEN SIDES OF PLANTING HOLE MAXIMIZE EXCAVATED AREA WITHOUT UNDERMINING

TREE PIT DEPTH = ROOTBALL DEPTH (MEASURE BEFORE DIGGING TO AVOID

ALL BURLAP FROM TOP 2/3 OF ROOTBALL

AFTER INSTALLATION

WATERING RING

TRUNK GROWTH

GROWTH


 NATIVE PLANTING REQUIREMENTS A. PLANTING TO CONTAIN A MINIMUM OF 25% NATIVE TO THE PUGET SOUND REGION, SOURCES USED: a. GREAT PLANT PICKS (ELISABETH CAREY MILLER GARDEN)

b. PLANTS OF THE PACIFIC NORTHWEST COAST (2004), BY JIM POJAR & ANDY MACKINNON


CONFORM TO THE SPECIFICATIONS & DRAWINGS IN THESE LANDSCAPE PLANS AND THE REQUIREMENTS OF THE CITY OF PUYALLUP VEGETATION VEGETATION MANAGEMENT STANDARDS (VMS). WHERE THERE IS A CONFLICT CONFORM TO THE MORE STRINGENT REQUIREMENTS.


CITY OF PUYALLUP MINIMUM SOIL REQUIREMENTS:

SOIL PREPARATION IN ALL DISTURBED AREAS WITH NEW LANDSCAPING SHALL CONFORM TO SPECIFICATIONS PROVIDED IN BMP T5.13 - THE "STORM WATER MANAGEMENT MANUAL OF WESTERN WASHINGTON", DEPARTMENT OF ECOLOGY, DATED AUGUST 2012, OR AS SUBSEQUENTLY AMENDED. COMPACTION OF LANDSCAPED AREAS FROM VEHICLES AND HEAVY EQUIPMENT SHALL BE AVOIDED AFTER TILLING.

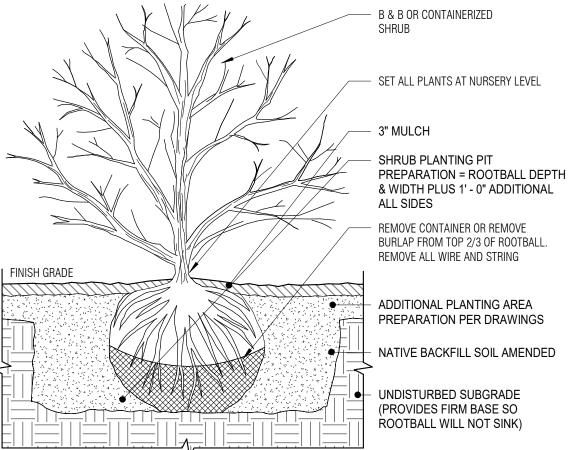


2 SHRUB PLANTING 1" = 1'-0"

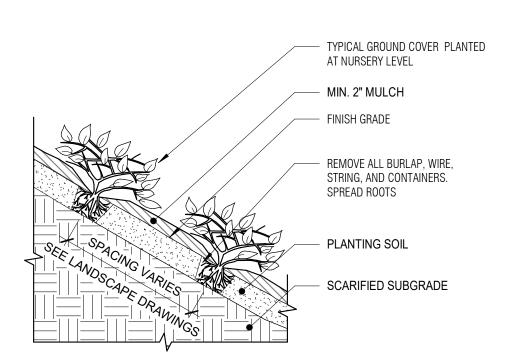

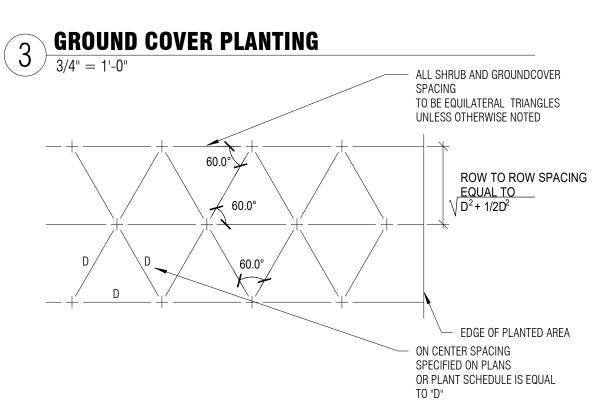

DECIDUOUS TREE PLANTING



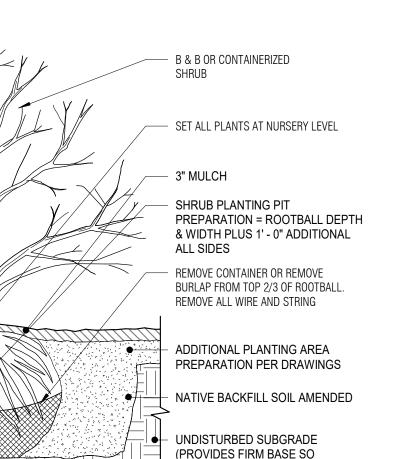

4/22/2022 CONSTRUCTION DOCUMENTS 8/26/2022 CIVIL PERMIT DOCUMENTS

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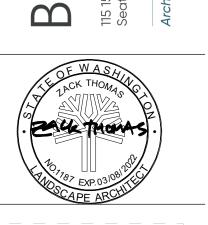
PLOT DATE: PLANTING SCHEDULE &

NOTES SHEET NO.:

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CITY OF PUYALLUP STAMP AREA

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2 2022.11.18 CIVIL PERMIT RESPONSE

ISSUANCES

DATE DESCRIPTION

04.19.2022

PUYALLUP PROJECT #:

EXISTING SWALE TO — LAWN TO REMAIN — REMAIN, CONTRACTOR TO VERIFY LOCATION IN FIELD — ___ EXISTING TREE, TYP S - EXISTING PLANTING TO LAWN TO REMAIN — (1) REQUIRED TREE PER 1:1 REPLACEMENT TREE REQUIREMENT SIGHT TRIANGLE PER PMC 20.25.040.10.A 15' - 0" MIN SETBACK LANDSCAPE A PLANTING PLAN - E. MAIN AVE - CENTRAL 1/8" = 1'-0"

PLANTING LEGEND



UPPER BANK PLANTING SCHEME



RIVERSIDE PLANTING SCHEME



RIVERINE GRASSES PLANTING SCHEME



FLOWERING MEADOW PLANTING SCHEME

BOTANICAL NAME COMMON NAME ABTM ACER BUERGERIANUM TRIDENT MAPLE MRSC MALUS 'JFS KW213MX' PP 31008

TAG BOTANICAL NAME

CAMASSIA QUAMASH CSRT RED TWIG DOGWOOD CORNUS SERICEA 'KELSEYI' DCTH DESCHAMPSIA CESPITOSA TUFTED HAIR GRASS RCHR RHODODENDRON X 'CUNNINGHAM'S WHITE' (H-2) CUNNINGHAM'S WHITE RHODODENDRON AUTUMN MOOR GRASS

TAG BOTANICAL NAME COMMON NAME







RASPBERRY SPEAR CRABAPPLE

KARL FOERSTER FEATHER REED GRASS

COMMON NAME

SAAM SESLARIA AUTUMNALIS

GROUNDCOVER

AUUK KINIKINNICK ARCTOSTAPHYLOS UVA-URSI

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CITY OF PUYALLUP STAMP AREA

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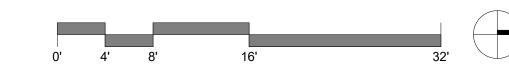
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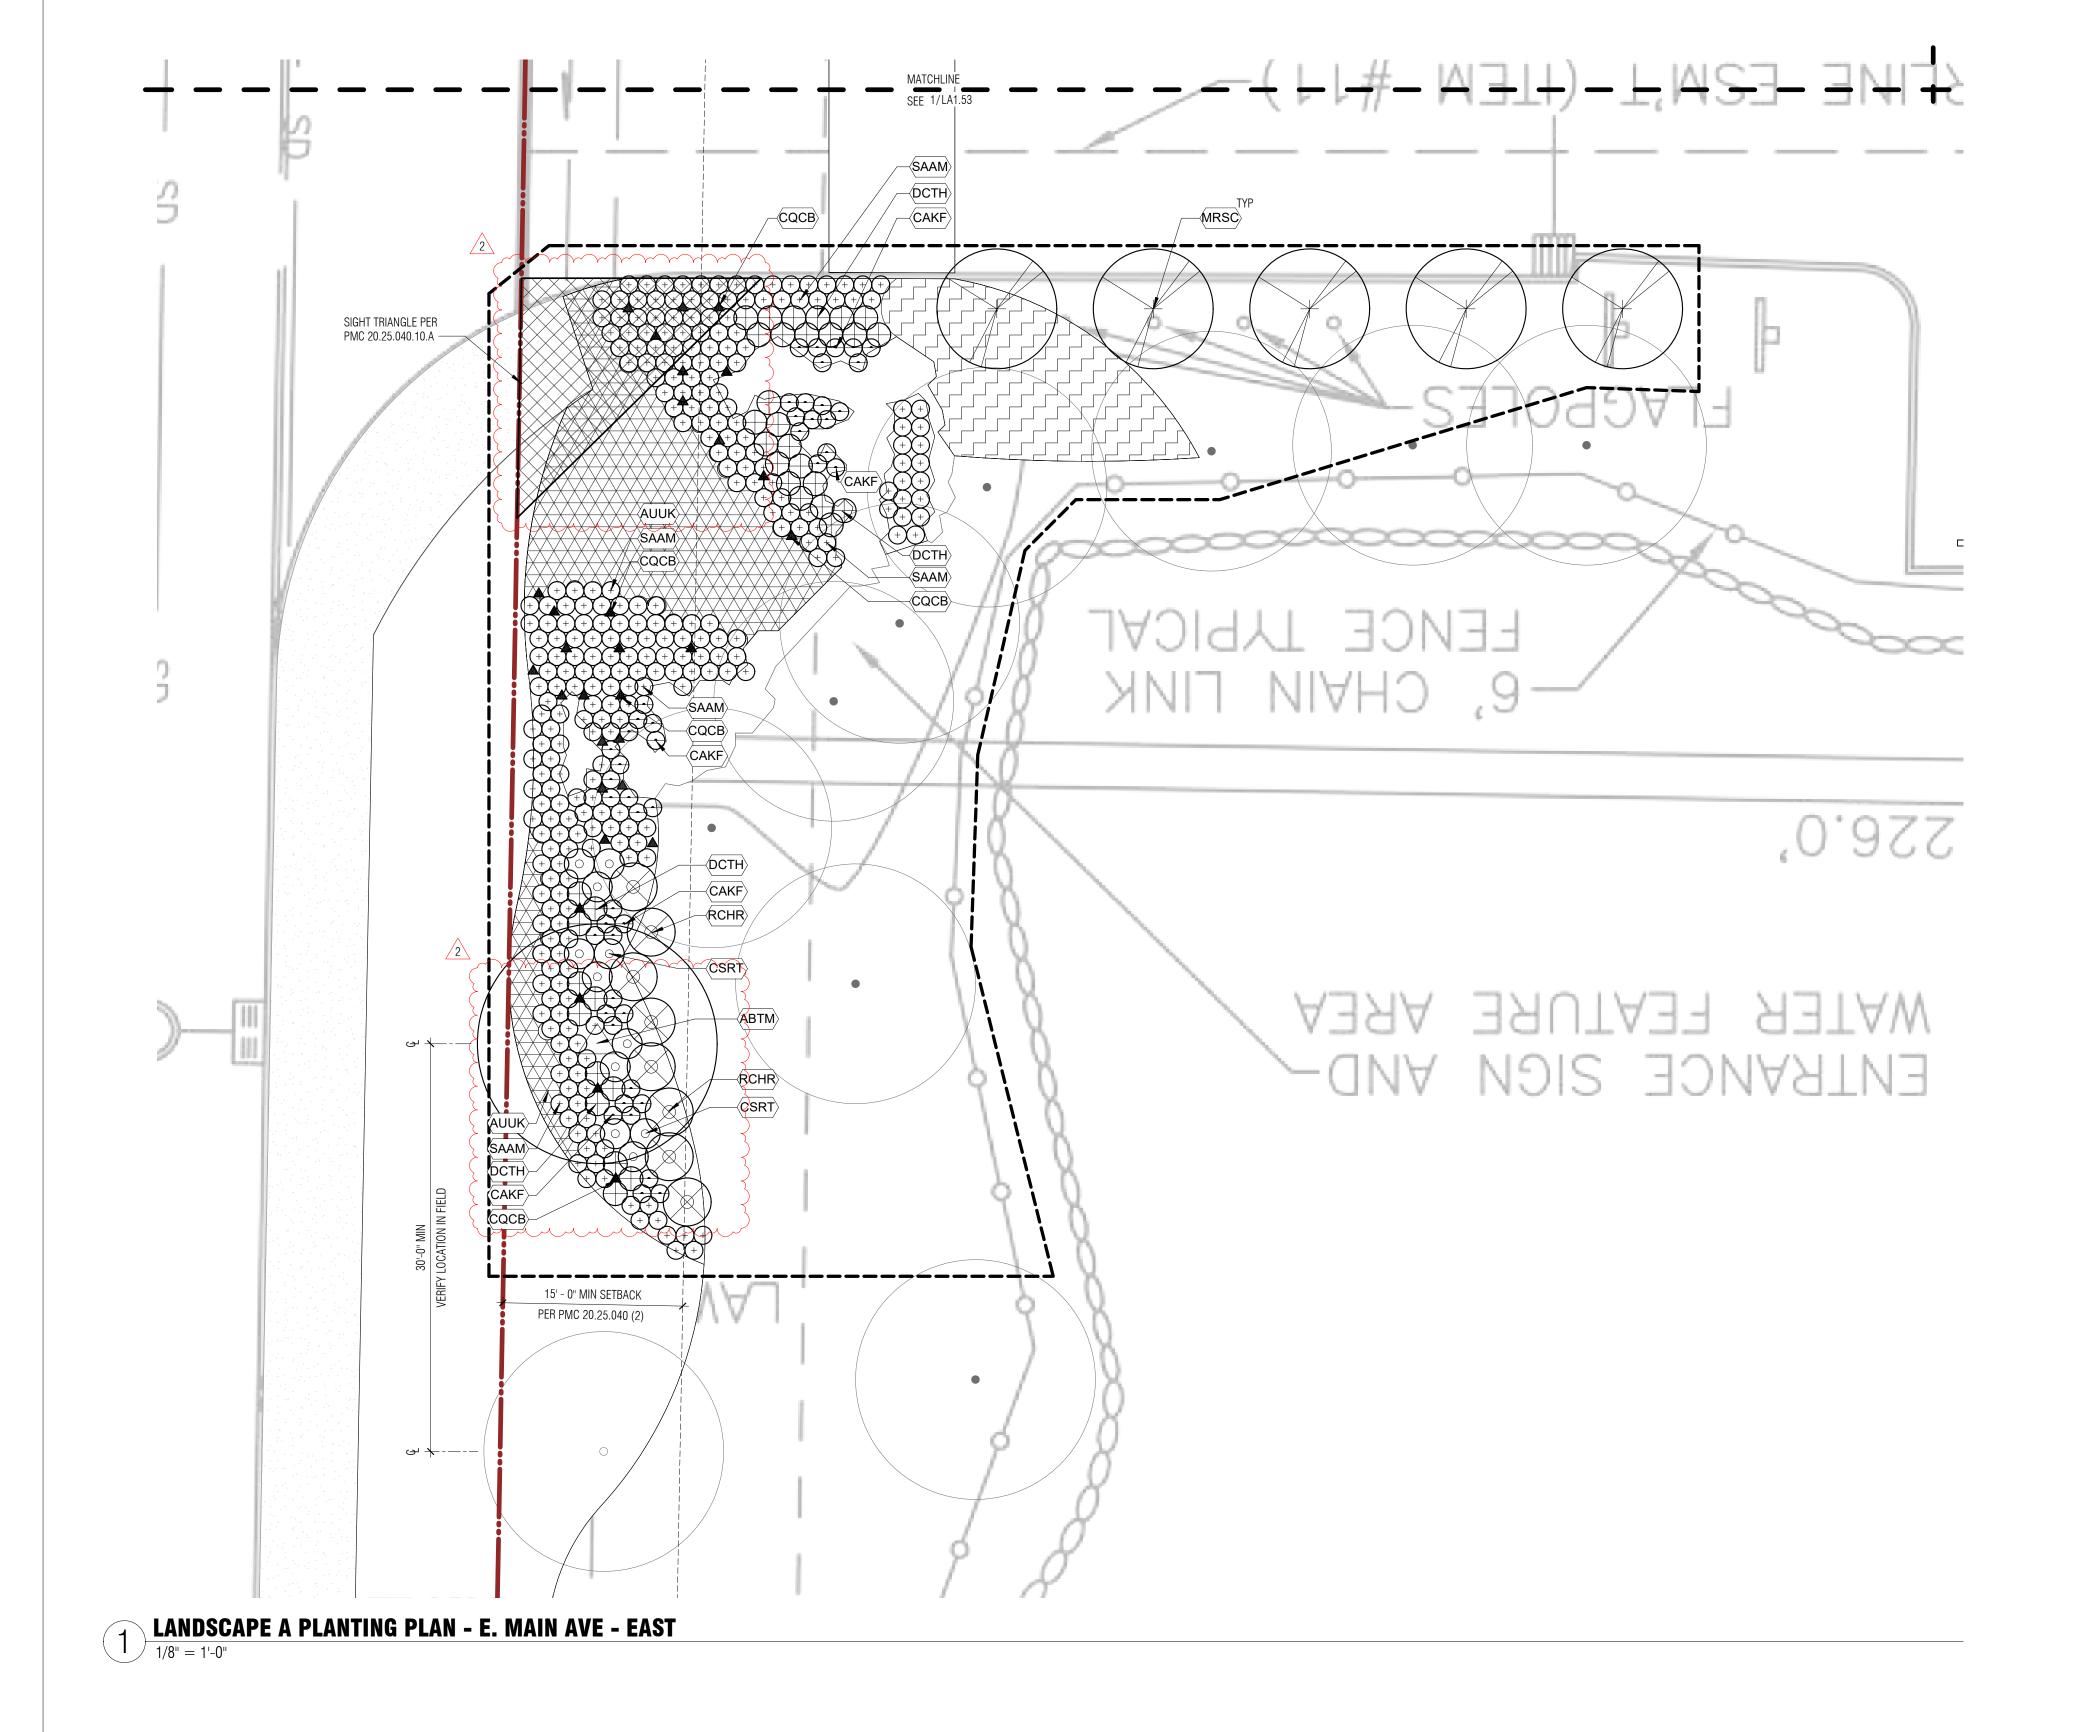
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PLOT DATE: 04.19.2022

PLANTING PLAN - E. MAIN AVE - CENTRAL







UPPER BANK PLANTING SCHEME



RIVERSIDE PLANTING SCHEME



RIVERINE GRASSES PLANTING SCHEME





FLOWERING MEADOW PLANTING SCHEME

BOTANICAL NAME

ABTM ACER BUERGERIANUM

TRIDENT MAPLE RASPBERRY SPEAR CRABAPPLE

COMMON NAME

MRSC MALUS 'JFS KW213MX' PP 31008

TAG BOTANICAL NAME

COMMON NAME

CALAMAGROTSIS ACUTIFLORA CAMASSIA QUAMASH

KARL FOERSTER FEATHER REED GRASS CORNUS SERICEA 'KELSEYI' RED TWIG DOGWOOD

DESCHAMPSIA CESPITOSA

TUFTED HAIR GRASS RCHR RHODODENDRON X 'CUNNINGHAM'S WHITE' (H-2) CUNNINGHAM'S WHITE RHODODENDRON **AUTUMN MOOR GRASS**

SAAM SESLARIA AUTUMNALIS

GROUNDCOVER

TAG BOTANICAL NAME

AUUK KINIKINNICK

COMMON NAME

ARCTOSTAPHYLOS UVA-URSI

CITY OF PUYALLUP STAMP AREA

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REVISION DATE

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DATE DESCRIPTION

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PLOT DATE: 04.19.2022

PLANTING PLAN - E. MAIN

AVE - EAST

O' 4' 8' 16' LA1.55



LAWN TO REMAIN LIMIT OF WORK (PRCTI20220683) 15' - 0" MIN SETBACK PER PMC 20.25.040 (2) PAVED DRIVEWAY

1 LANDSCAPE A PLANTING PLAN - EAST ENTRY - SOUTH

1/8" = 1'-0"

PLANTING LEGEND



UPPER BANK PLANTING SCHEME

RIVERSIDE PLANTING SCHEME



RIVERINE GRASSES PLANTING SCHEME



FLOWERING MEADOW PLANTING SCHEME

COMMON NAME **BOTANICAL NAME** ABTM ACER BUERGERIANUM TRIDENT MAPLE

TAG BOTANICAL NAME


CORNUS SERICEA 'KELSEYI' RED TWIG DOGWOOD DCTH DESCHAMPSIA CESPITOSA TUFTED HAIR GRASS RCHR RHODODENDRON X 'CUNNINGHAM'S WHITE' (H-2) CUNNINGHAM'S WHITE RHODODENDRON

TAG BOTANICAL NAME COMMON NAME AUUK KINIKINNICK





MRSC MALUS 'JFS KW213MX' PP 31008

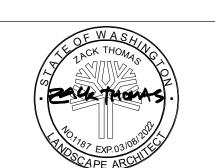

CITY OF PUYALLUP STAMP AREA

Vellum

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COMMON NAME

RASPBERRY SPEAR CRABAPPLE

KARL FOERSTER FEATHER REED GRASS

SAAM SESLARIA AUTUMNALIS AUTUMN MOOR GRASS

GROUNDCOVER

ARCTOSTAPHYLOS UVA-URSI

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REVISION DATE

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DATE DESCRIPTION


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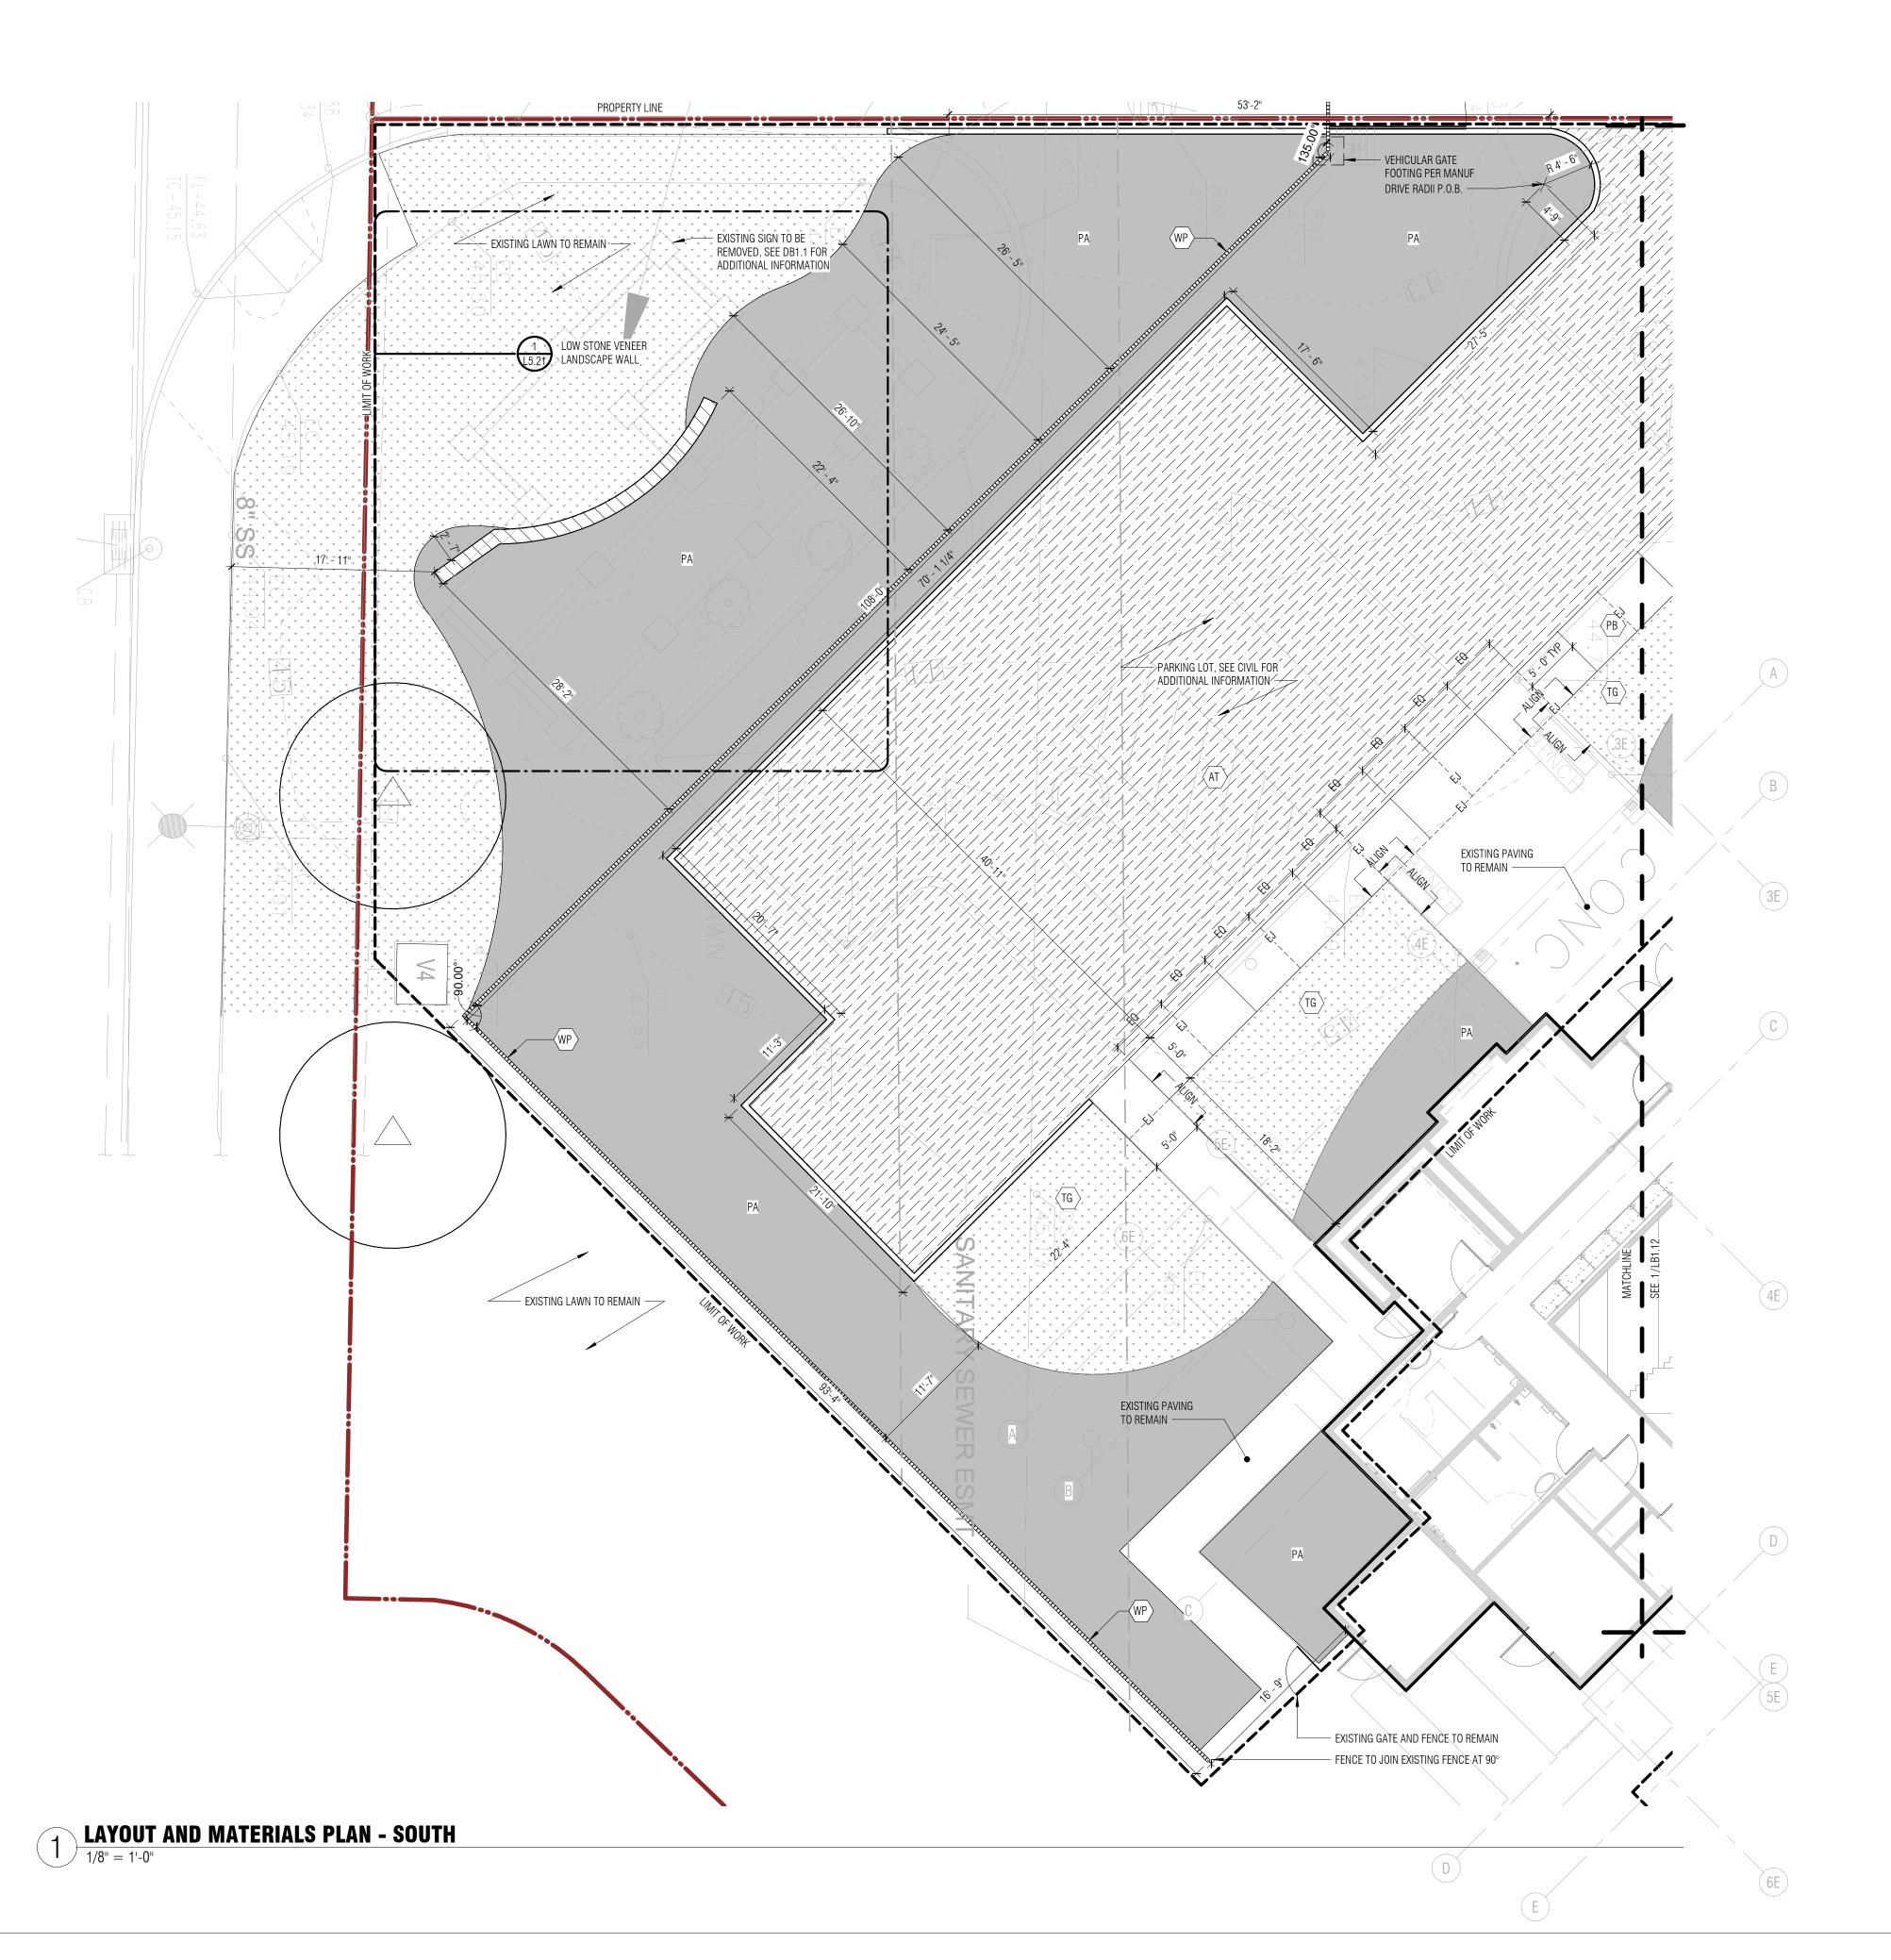
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04.19.2022

PLOT DATE:

PLANTING PLAN - EAST ENTRY - SOUTH



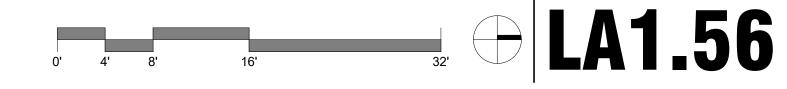

IVIAIL	INIALO	LLULND	
TAG		DESCRIPTION	DETAIL
⟨PB⟩	EJ — -	CIP CONCRETE AND SCORING	1/L5.11
(PP)		CIP CONCRETE WITH INTEGRAL COLOR COLOR: DAVIS COLOR DUNE 6058	1/L5.11
(PO)	>>	CIP CONCRETE WITH HEAVY SALT ROCK FINISH TO MATCH ADJACENT PAVING	1/L5.11
SR		MONUMENTAL SIGNAGE	
(AT)		ASPHALT	SEE CIVIL
PA	PA	PLANTING AREA	
TG	*	GRASS LAWN	
(WC)		6" CIP CONCRETE CURB	SEE CIVIL
SW		18" HT CIP CONCRETE SEATWALL	3/L5.11
⟨WP⟩		METAL FENCING & GATE	PER MANUF
(BS)		ELECTRIC BIKE STATION	OFCI
		PROPERTY LINE	
		LIMIT OF WORK	

LAYOUT AND MATERIAL NOTES

- ALL CONCRETE JOINTS TO BE TOOLED WITH 1/4" RADIUS UNLESS SHOWN OTHERWISE. NO TOOL MARKS OR SHINERS.
 VERIFY DIMENSIONS AND ACCEPT CONDITIONS BEFORE PROCEEDING WITH ANY WORK. REPORT LANDSCAPE DISCREPANCIES TO LANDSCAPE ARCHITECT. CONTRACTOR TO OBTAIN LANDSCAPE ARCHITECT'S FINAL APPROVAL OF LAYOUT PRIOR TO BEGINNING WORK.
- INTENDED DESIGN AS SET FORTH IN THE DRAWINGS BEFORE PROCEEDING WITH CONSTRUCTION. THE USER OF THESE DRAWINGS IS CAUTIONED THAT UNDERGROUND UTILITIES AND FOUNDATIONS AS SHOWN ARE NOT
- INSTALL ISOLATION JOINTS IN CONCRETE PAVING ABUTTING CURBS, STEPS AND OTHER FIXED OBJECTS.
- DO NOT SCALE DRAWINGS; CONSULT LANDSCAPE ARCHTECT FOR ANSWERS TO ALL DIMENSIONAL QUESTIONS.
- ANGLES ARE ASSUMED TO BE 90 DEGREES UNLESS NOTED OTHERWISE.
- ARCHITECT PRIOR TO CONSTRUCTION OR INSTALLATION.

MATERIALS LEGEND

- THESE CONTRACT DOCUMENTS MAKE NO REPRESENTATIONS AS TO THE MEANS AND METHODS OF CONSTRUCTION. CONTRACTOR SHALL CONTACT LANDSCAPE ARCHITECT OF ANY UNFORSEEN CONDITIONS WHICH MAY AFFECT THE
- GUARANTEED NOR IS THERE ANY GUARANTEE THAT ALL EXISTING UTILITIES AND FOUNDATIONS, WHETHER ABANDONED
- OR FUNCTIONAL, ARE SHOWN ON THESE DRAWINGS. DIMENSIONS AND RADII FOR EDGES, STEPS, WALLS & PAVEMENTS ARE TO EXPOSED FACES UNLESS NOTED OTHERWISE
- 10. ANY CHANGES PROPOSED TO DIMENSIONS SHOWN ON THIS DRAWING SHALL BE APPROVED BY THE LANDSCAPE
- 11. ALL STRUCTURES TO REMAIN SHALL BE PROTECTED UNLESS OTHERWISE NOTED TO BE DEMOLISHED.
 12. STRUCTURAL ENGINEER TO REVIEW AND APPROVE STRUCTURAL CONNECTIONS OF METAL POSTS AND WIRES TO BUILDING AND STRUCTURE.

REVISION DATE DESCRIPTION 1 2022.07.08 COMMENT RESPONSE

2 7/14/2022 SIGNAGE PERMIT

CITY OF PUYALLUP STAMP AREA

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DATE DESCRIPTION

4/22/2022 CONSTRUCTION DOCUMENTS 8/26/2022 CIVIL PERMIT DOCUMENTS


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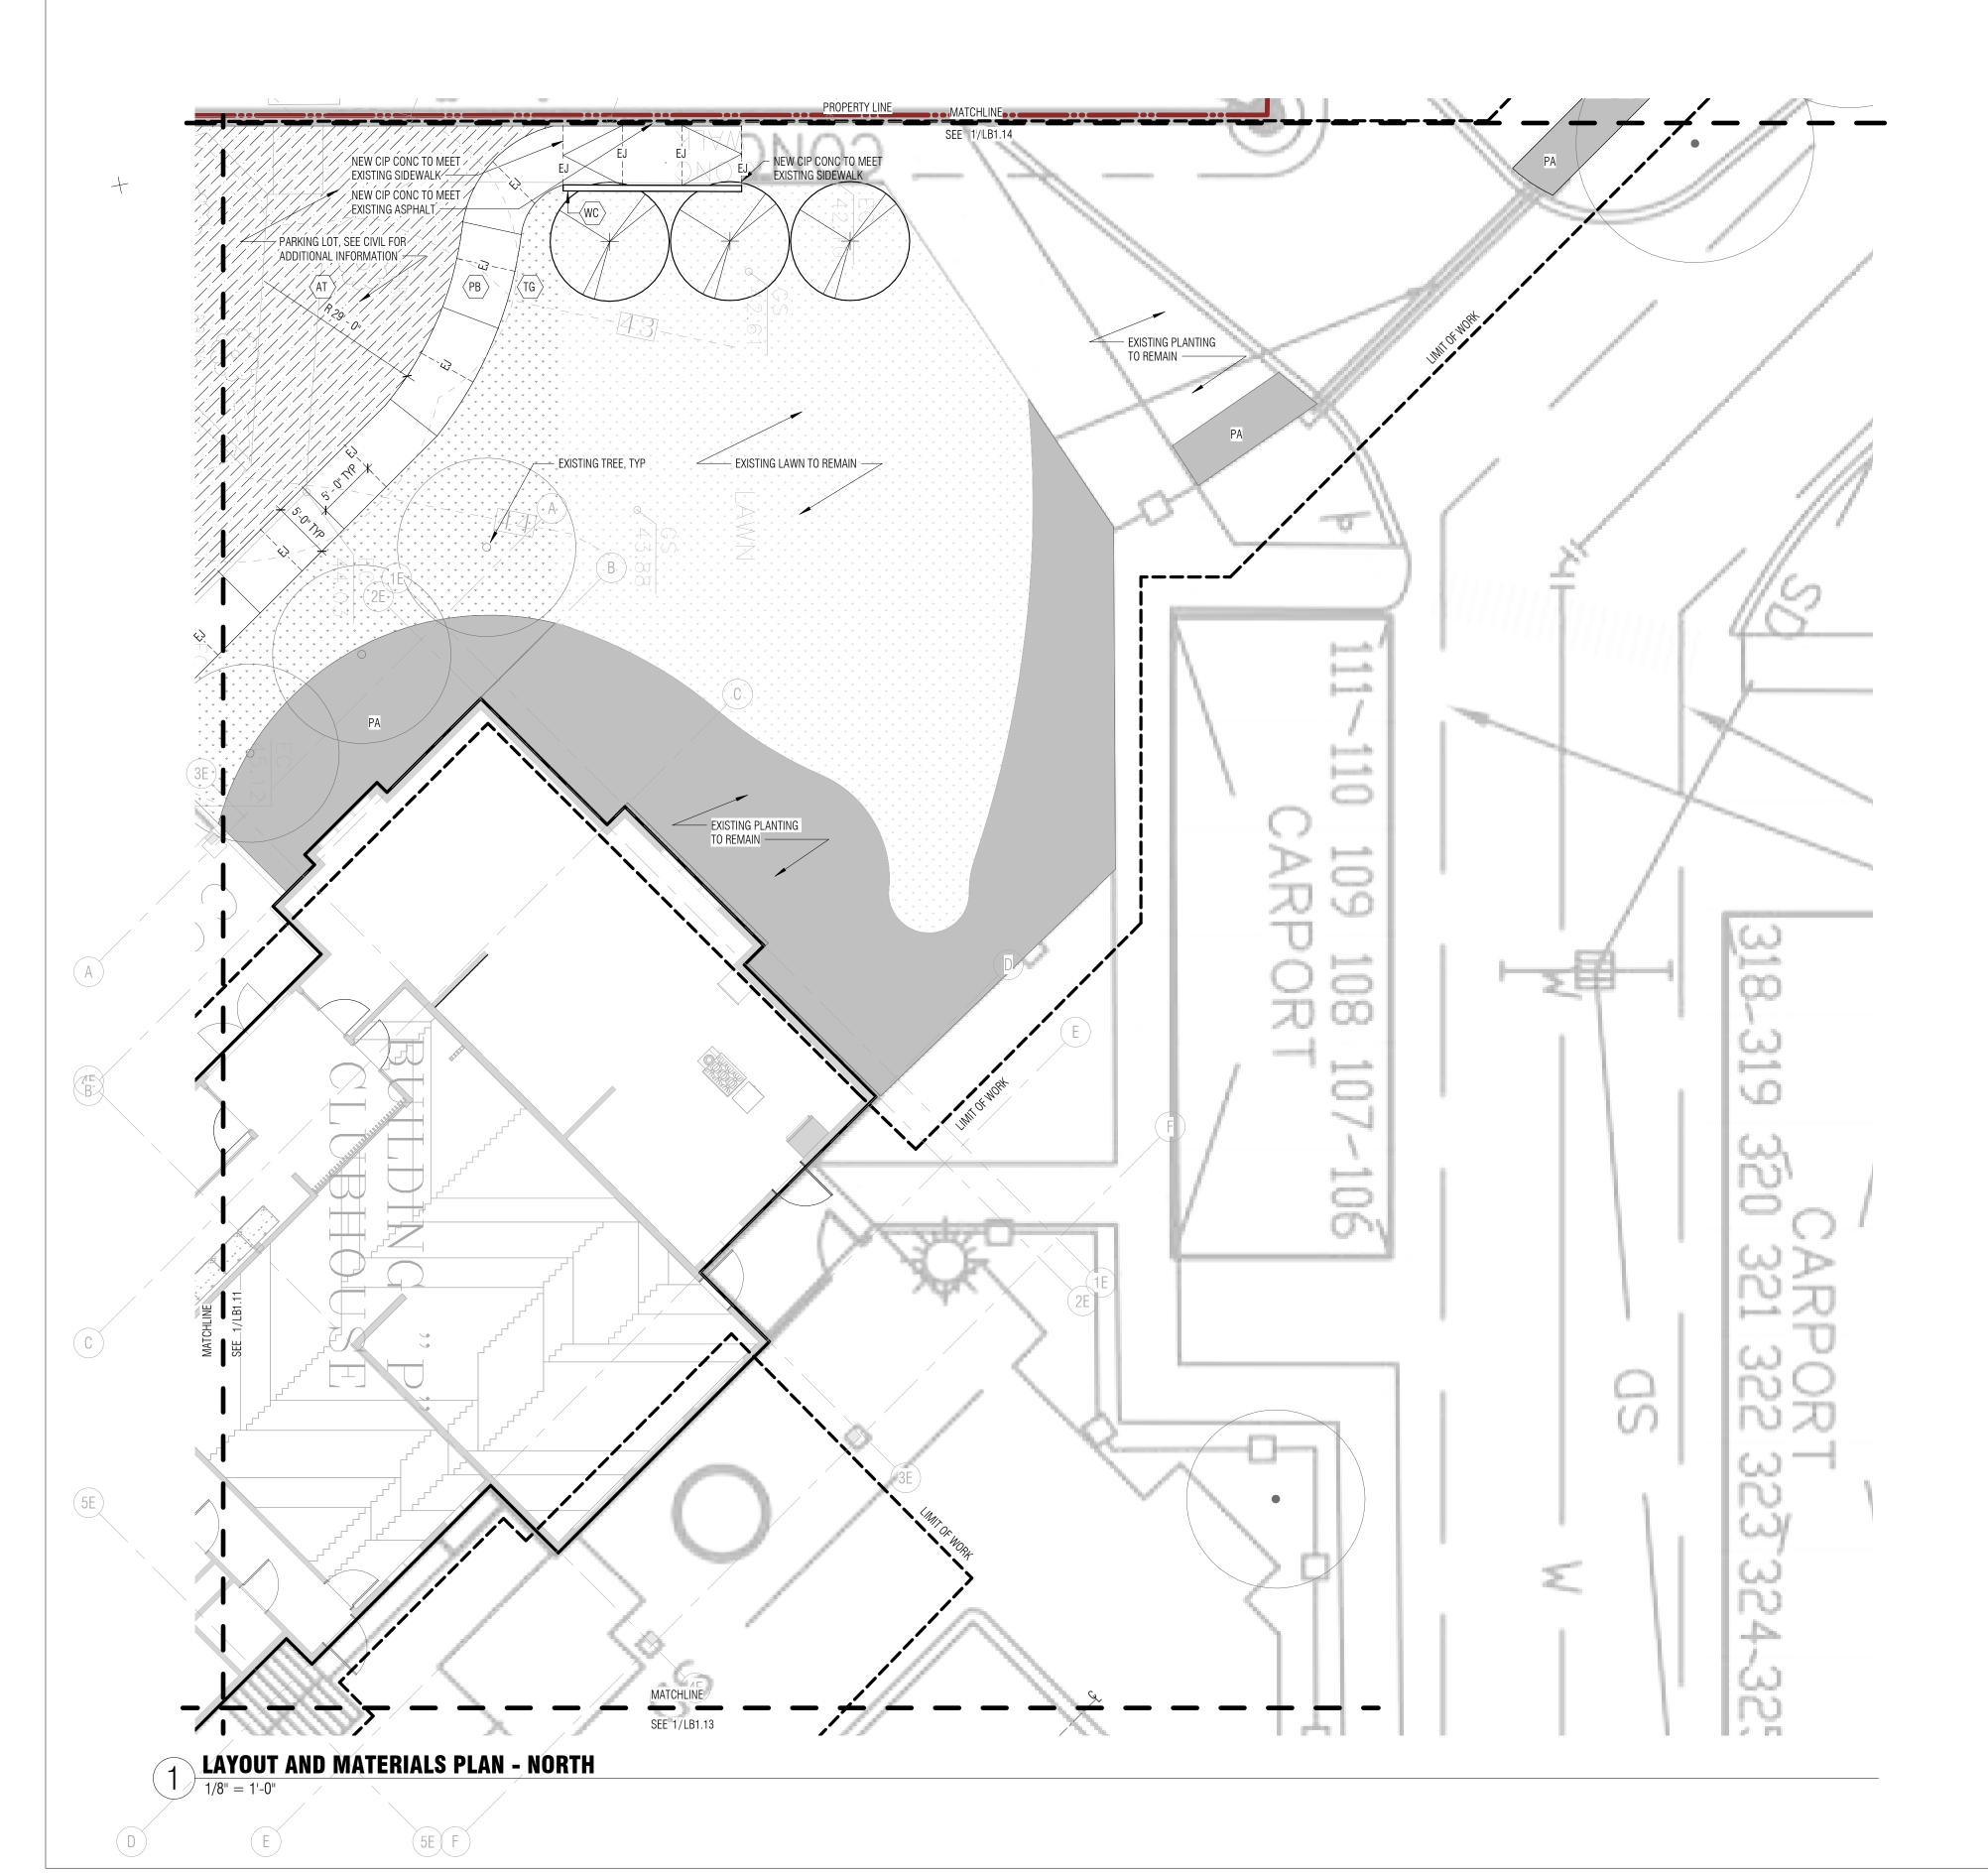
PLOT DATE: 04.19.2022

PUYALLUP PROJECT #:

LAYOUT AND MATERIALS

PLAN - SOUTH SHEET NO.:



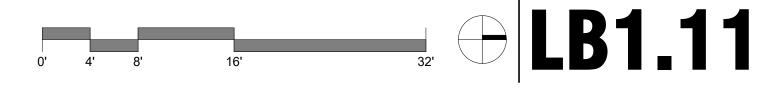

MATERIALS LEGEND

TAG		DESCRIPTION	DETAIL
⟨PB⟩	-EJ —	CIP CONCRETE AND SCORING	1/L5.11
(PP)		CIP CONCRETE WITH INTEGRAL COLOR COLOR: DAVIS COLOR DUNE 6058	1/L5.11
(PO)		CIP CONCRETE WITH HEAVY SALT ROCK FINISH TO MATCH ADJACENT PAVING	1/L5.11
SR		MONUMENTAL SIGNAGE	
\(\lambda\)		ASPHALT	SEE CIVIL
PA	PA	PLANTING AREA	
TG	*	GRASS LAWN	
⟨WC⟩		6" CIP CONCRETE CURB	SEE CIVIL
SW		18" HT CIP CONCRETE SEATWALL	3/L5.11
⟨WP⟩		METAL FENCING & GATE	PER MANUF
(BS)		ELECTRIC BIKE STATION	OFCI
		PROPERTY LINE	
		LIMIT OF WORK	

LAYOUT AND MATERIAL NOTES

- DISCREPANCIES TO LANDSCAPE ARCHITECT. CONTRACTOR TO OBTAIN LANDSCAPE ARCHITECT'S FINAL APPROVAL OF
- THESE CONTRACT DOCUMENTS MAKE NO REPRESENTATIONS AS TO THE MEANS AND METHODS OF CONSTRUCTION. CONTRACTOR SHALL CONTACT LANDSCAPE ARCHITECT OF ANY UNFORSEEN CONDITIONS WHICH MAY AFFECT THE
- THE USER OF THESE DRAWINGS IS CAUTIONED THAT UNDERGROUND UTILITIES AND FOUNDATIONS AS SHOWN ARE NOT GUARANTEED NOR IS THERE ANY GUARANTEE THAT ALL EXISTING UTILITIES AND FOUNDATIONS, WHETHER ABANDONED
- DIMENSIONS AND RADII FOR EDGES, STEPS, WALLS & PAVEMENTS ARE TO EXPOSED FACES UNLESS NOTED OTHERWISE. INSTALL ISOLATION JOINTS IN CONCRETE PAVING ABUTTING CURBS, STEPS AND OTHER FIXED OBJECTS.
- 8. DO NOT SCALE DRAWINGS; CONSULT LANDSCAPE ARCHTECT FOR ANSWERS TO ALL DIMENSIONAL QUESTIONS.
- 9. ANGLES ARE ASSUMED TO BE 90 DEGREES UNLESS NOTED OTHERWISE. 10. ANY CHANGES PROPOSED TO DIMENSIONS SHOWN ON THIS DRAWING SHALL BE APPROVED BY THE LANDSCAPE
- 11. ALL STRUCTURES TO REMAIN SHALL BE PROTECTED UNLESS OTHERWISE NOTED TO BE DEMOLISHED.
- 12. STRUCTURAL ENGINEER TO REVIEW AND APPROVE STRUCTURAL CONNECTIONS OF METAL POSTS AND WIRES TO BUILDING AND STRUCTURE.

- 1. ALL CONCRETE JOINTS TO BE TOOLED WITH 1/4" RADIUS UNLESS SHOWN OTHERWISE. NO TOOL MARKS OR SHINERS.
- LAYOUT PRIOR TO BEGINNING WORK.
- INTENDED DESIGN AS SET FORTH IN THE DRAWINGS BEFORE PROCEEDING WITH CONSTRUCTION. OR FUNCTIONAL, ARE SHOWN ON THESE DRAWINGS.

- ARCHITECT PRIOR TO CONSTRUCTION OR INSTALLATION.

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DATE DESCRIPTION

4/22/2022 CONSTRUCTION DOCUMENTS 8/26/2022 CIVIL PERMIT DOCUMENTS


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BOARD & VELLUM PROJECT #: 2021089.00 PUYALLUP PROJECT #:

PLOT DATE: 04.19.2022

LAYOUT AND MATERIALS

PLAN - NORTH

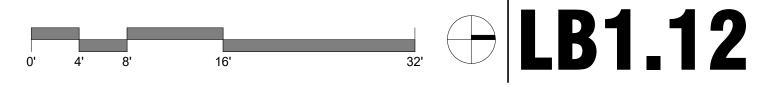

PLANT SCHEME

BOTANICAL NAME / COMMON NAME

<u>UPPER BANK</u>

ARCTOSTAPHYLOS UVA-URSI / KINNIKINNICK CALAMAGROSTIS ACUTIFLORA / KARL FOERSTER FEATHER REED GRASS CALLUNA VULGARIS 'SPRING TORCH' - SPRING TORCH HEATHER CAMASSIA QUAMASH / CAMAS CORNUS SERICEA 'KELSEYI' / KELSEY RED TWIG DOGWOOD DESCHAMPSIA CESPITOSA / TUFTED HAIR GRASS ERICA X DARLEYENSIS 'WHITE PERFECTION' / WHITE PERFECTION HEATH IRIS SSP / PACIFIC COAST IRIS PIERIS JAPONICA / JAPANESE ANDROMEDA RHODODENDRON SSP. / VARIOUS AZALEA RHODODENDRON DAVIESII / DWARF WHITE AZALEA RHODODENDRON X 'CUNNINGHAMS WHITE' / CUNNINGHAMS WHITE RHODODENDRON SESLARIA AUTUMNALIS / AUTUMN MOOR GRASS

RIVERSIDE



ARCTOSTAPHYLOS UVA-URSI / KINNIKINNICK CAMASSIA QUAMASH / CAMAS SESLARIA AUTUMNALIS / AUTUMN MOOR GRASS

CALAMAGROSTIS ACUTIFLORA / KARL FOERSTER FEATHER REED GRASS

VIBURNUM DAVIDII / DAVID VIBURNUM

RIVERINE GRASSES

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DESCHAMPSIA CESPITOSA / TUFTED HAIR GRASS SESLARIA AUTUMNALIS / AUTUMN MOOR GRASS FLOWERING MEADOW

PRO TIME PT 710 FLOWERING MEADOW MIX

CAMASSIA QUAMASH / CAMAS

PLANT SCHEDULE

<u>SHKUBS</u>					
QTY.	TAG	BOTANICAL NAME	COMMON NAME	CONT.	MIN. SPACING REMA
83	CAKF	CALAMAGROTSIS ACUTIFLORA	KARL FOERSTER FEATHER REED GRASS	2 GAL	2' - 0"
52	CQCB	CAMASSIA QUAMASH	CAMAS	2 GAL	3' - 0"
20	CSRT	CORNUS SERICEA 'KELSEYI'	RED TWIG DOGWOOD	₹ 2 GAL	2' - 6"
190	DCTH	DESCHAMPSIA CESPITOSA	TUFTED HAIR GRASS	≥ 2 GAL	2' - 6"
11	RCHR	RHODODENDRON X 'CUNNINGHAM'S WHITE' (H-2)	CUNNINGHAM'S WHITE RHODODENDRON	3 GAL	4' - 0"
545	SAAM	SESLARIA AUTUMNALIS	AUTUMN MOOR GRASS	2 GAL	3' - 0"

PLANTING NOTES

ESTIMATED TOTAL CUBIC YARDS OF TOP SOIL: 400 CUBIC YARDS

A. INSTALLATION OF AN IRRIGATION SYSTEM WITH AN AUTOMATIC CONTROLLER IS RECOMMENDED.

PLANTING/LAWN AREA PREPARATION AND SOIL AMENDMENT A. CONFORM TO SECTION 8.2 (A) OF THE VEGETATION MANAGEMENT STANDARDS (VMS) FOR ALL AREAS OF PLANTING AND LAWN WORK.

B. DO NOT WORK SOILS IF TOO WET. CONTACT OWNER IF SOILS ARE VISIBLY WET. C. WATER IN SOILS AFTER PLACING. ALLOW 24 HOURS FOR SOILS TO SETTLE AND FILL LOW SPOTS

A. SEEDED LAWNS: USE SEED MIX RECOMMENDED FOR SOLAR CONDITIONS OF THE NEW LAWN AREA. APPLY SEED AT RATE RECOMMENDED BY SUPPLIER AND WATER AREA. B. SOD: USE A SAND-BASED, NON-NETTED SOD SIMILAR TO PRODUCT SUPPLIED BY COUNTRY GREEN. INSTALL SOD AS RECOMMENDED BY SUPPLIER AND WATER AREA.

C. MONITOR SOIL MOISTURE AND APPLY WATER AS NEEDED UNTIL GRASS OR SOD IS ESTABLISHED (MIN 30 DAYS).

PLANTING INSTALLATION

A. PROVIDE FROM A RECOGNIZED NURSERY GROWN IN ACCORDANCE WITH GOOD HORTICULTURAL PRACTICES. PROVIDE ONLY HEALTHY, VIGOROUS STOCK FREE OF DISEASE, AND DEFECTS SUCH AS INJURIES, ABRASIONS OR DISFIGUREMENT. B. PROVIDE PLANTS IN VARIETIES AND SIZES INDICATED ON PLANTING PLAN. NOTIFY OWNER IF PLANTS SPECIES, VARITIES, SIZES OR QUANTITIES ARE UNAVAILABLE TO COORDINATE SUBSTITUTIONS.

Ť D. Ť MŮLCH ŘŘEAŠ IMMĚDIATELY AFTEŘ PLÁNTING WITH MIŇÍMUM 4" ĎE SHŘEDĎĚD HÁRDWÔOD MULCH TŎ MAŤCH ŠPECIFICATÍON ŎF VMŠ. BAŠÍS-ŎF-DEŠIGN PRODÚCT ÍS LAŇDSCÁPE MŮLCH AS SUPPLIED BY, CEDAR GROVE. E. MONTOR SOIL MOISTURE AND APPLY WATER AS NEEDED UNTIL PROJECT IS COMPLETED AND HANDED OVER TO OWNER.

LAYOUT PLANTS ON SOIL SURFACE FOR REVIEW AND APPROVAL BY OWNER. INSTALL PLANTS IMMEDIATELY AFTER LAYOUT APPROVED.

NATIVE PLANTING REQUIREMENTS

A. PLANTING TO CONTAIN A MINIMUM OF 25% NATIVE TO THE PUGET SOUND REGION, SOURCES USED:

SEE NOTE 1

MIN WIDTH OF TREE PIT = 2TIMES ROOTBALL

DIAMETER OR 5'-0", WHICHEVER IS GREATER

MULCH AREA TO BE CLEAR OF GRASS, WEEDS,

ETC. TO REDUCE COMPETITION WITH TREE ROOTS

1'-6", SEE

NOTE 2

SIDEWALK

a. GREAT PLANT PICKS (ELISABETH CAREY MILLER GARDEN) b. PLANTS OF THE PACIFIC NORTHWEST COAST (2004), BY JIM POJAR & ANDY MACKINNON CONFORM TO THE SPECIFICATIONS & DRAWINGS IN THESE LANDSCAPE PLANS AND THE REQUIREMENTS OF THE CITY OF PUYALLUP VEGETATION VEGETATION MANAGEMENT STANDARDS (VMS). WHERE THERE IS A CONFLICT CONFORM TO THE MORE STRINGENT REQUIREMENTS.

CITY OF PUYALLUP MINIMUM SOIL REQUIREMENTS:

SOIL PREPARATION IN ALL DISTURBED AREAS WITH NEW LANDSCAPING SHALL CONFORM TO SPECIFICATIONS PROVIDED IN BMP T5.13 - THE "STORM WATER MANAGEMENT MANUAL OF WESTERN WASHINGTON", DEPARTMENT OF ECOLOGY, DATED AUGUST 2012, OR AS SUBSEQUENTLY AMENDED. COMPACTION OF LANDSCAPED AREAS FROM VEHICLES AND HEAVY EQUIPMENT SHALL BE AVOIDED AFTER TILLING.

B & B OR CONTAINERIZED

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CITY OF PUYALLUP STAMP AREA

ST AIL WE IVER TRAMENITY AN PROJE 1617 E PUYAL OWNEI

REVISION DATE DESCRIPTION 1 2022.07.08 COMMENT RESPONSE

2 2022.11.18 CIVIL PERMIT RESPONSE

ISSUANCES DATE DESCRIPTION

4/22/2022 CONSTRUCTION DOCUMENTS 8/26/2022 CIVIL PERMIT DOCUMENTS

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BOARD & VELLUM PROJECT #: 2021089.00 PUYALLUP PROJECT #:

PLOT DATE: 04.19.2022 PLANTING SCHEDULE &

NOTES SHEET NO.:

LB1.50

- SET ALL PLANTS AT NURSERY LEVEL — 3" MULCH - SHRUB PLANTING PIT PREPARATION = ROOTBALL DEPTH & WIDTH PLUS 1' - 0" ADDITIONAL 1. INSTALLATION INCLUDES REMOVAL OF STAKES ONE YEAR ALL SIDES AFTER INSTALLATION 2. SHAPE SOIL SURFACE TO PROVIDE 3' DIAMETER REMOVE CONTAINER OR REMOVE WATERING RING BURLAP FROM TOP 2/3 OF ROOTBALL. REMOVE ALL WIRE AND STRING | FINISH GRADE - ADDITIONAL PLANTING AREA PREPARATION PER DRAWINGS STAKE TREE WITH (2) TREATED 2" DIAMETER LODGEPOLE PINE DOWELED TREE STAKES NATIVE BACKFILL SOIL AMENDED (8'-0" LENGTH) LOOP EACH TIE AROUND HALF TREE LOOSELY TO PROVIDE 1" SLACK FOR TRUNK GROWTH UNDISTURBED SUBGRADE (PROVIDES FIRM BASE SO ROOTBALL WILL NOT SINK) "CHAINLOCK" OR EQUAL TREE TIE MATERIAL (1" WIDTH) NAIL OR STAPLE TREE TIE MATERIAL TO STAKE TO 2'-0" MIN HOLD VERTICALLY. LOOP EACH TIE 2 SHRUB PLANTING

1" = 1'-0" AROUND HALF TREE LOOSELY TO PROVIDE 1" SLACK FOR TRUNK

> TYPICAL GROUND COVER PLANTED AT NURSERY LEVEL MIN. 2" MULCH — FINISH GRADE REMOVE ALL BURLAP, WIRE, STRING, AND CONTAINERS. SPREAD ROOTS PLANTING SOIL SCARIFIED SUBGRADE

GROUND COVER PLANTING ALL SHRUB AND GROUNDCOVER SPACING TO BE EQUILATERAL TRIANGLES UNLESS OTHERWISE NOTED 60.0° ROW TO ROW SPACING EQUAL TO ≠ 60.0° $\sqrt{D^2 + 1/2D^2}$ - EDGE OF PLANTED AREA ON CENTER SPACING SPECIFIED ON PLANS OR PLANT SCHEDULE IS EQUAL

DECIDUOUS TREE PLANTING

TRIANGULAR PLANT SPACING

1/4" = 1'-0"

GROWTH

SET TOP OF ROOT CROWN 2" ABOVE

- 2"-3" MULCH DEPTH (TAPERED AT

ADJACENT CURB AND SIDEWALK GRADE

MULCH TREE PIT MIN 5'-0" LENGTH X FULL

PLANTING STRIP WIDTH BETWEEN CURB AND

SIDEWALK (FOR PLANTING STRIPS LESS THAN

6'-0" WIDE.) PROVIDE 5'-0" MULCH RING FOR PLANTING STRIPS WIDER THAN 6'-0"

REMOVE ALL WIRE & STRING, AND REMOVE

ADJACENT PAVING/CURB

18" DEEP ROOT BARRIER TYP.

*DRIVE STAKES 6" TO 1'-0" INTO

UNDISTURBED SOIL BELOW

ROOTBALL

DRIVE STAKE AT ROOTBALL EDGE (TYP)

NATIVE BACKFILL SOIL AMENDMENT

TREE PIT AREA X ROOTBALL DEPTH

WITH 25% (@1/3 CU YD) DECOMPOSED ORGANIC MULCH AMENDMENT FOR ENTIRE

UNDISTURBED SUBGRADE (PROVIDES FIRM

BASE SO THAT ROOTBALL WILL NOT SINK)


WITHIN 10' OF PAVING

OVEREXCAVATION)

- ROUGHEN SIDES OF PLANTING HOLE MAXIMIZE EXCAVATED AREA WITHOUT UNDERMINING

TREE PIT DEPTH = ROOTBALL DEPTH (MEASURE BEFORE DIGGING TO AVOID

ALL BURLAP FROM TOP 2/3 OF ROOTBALL

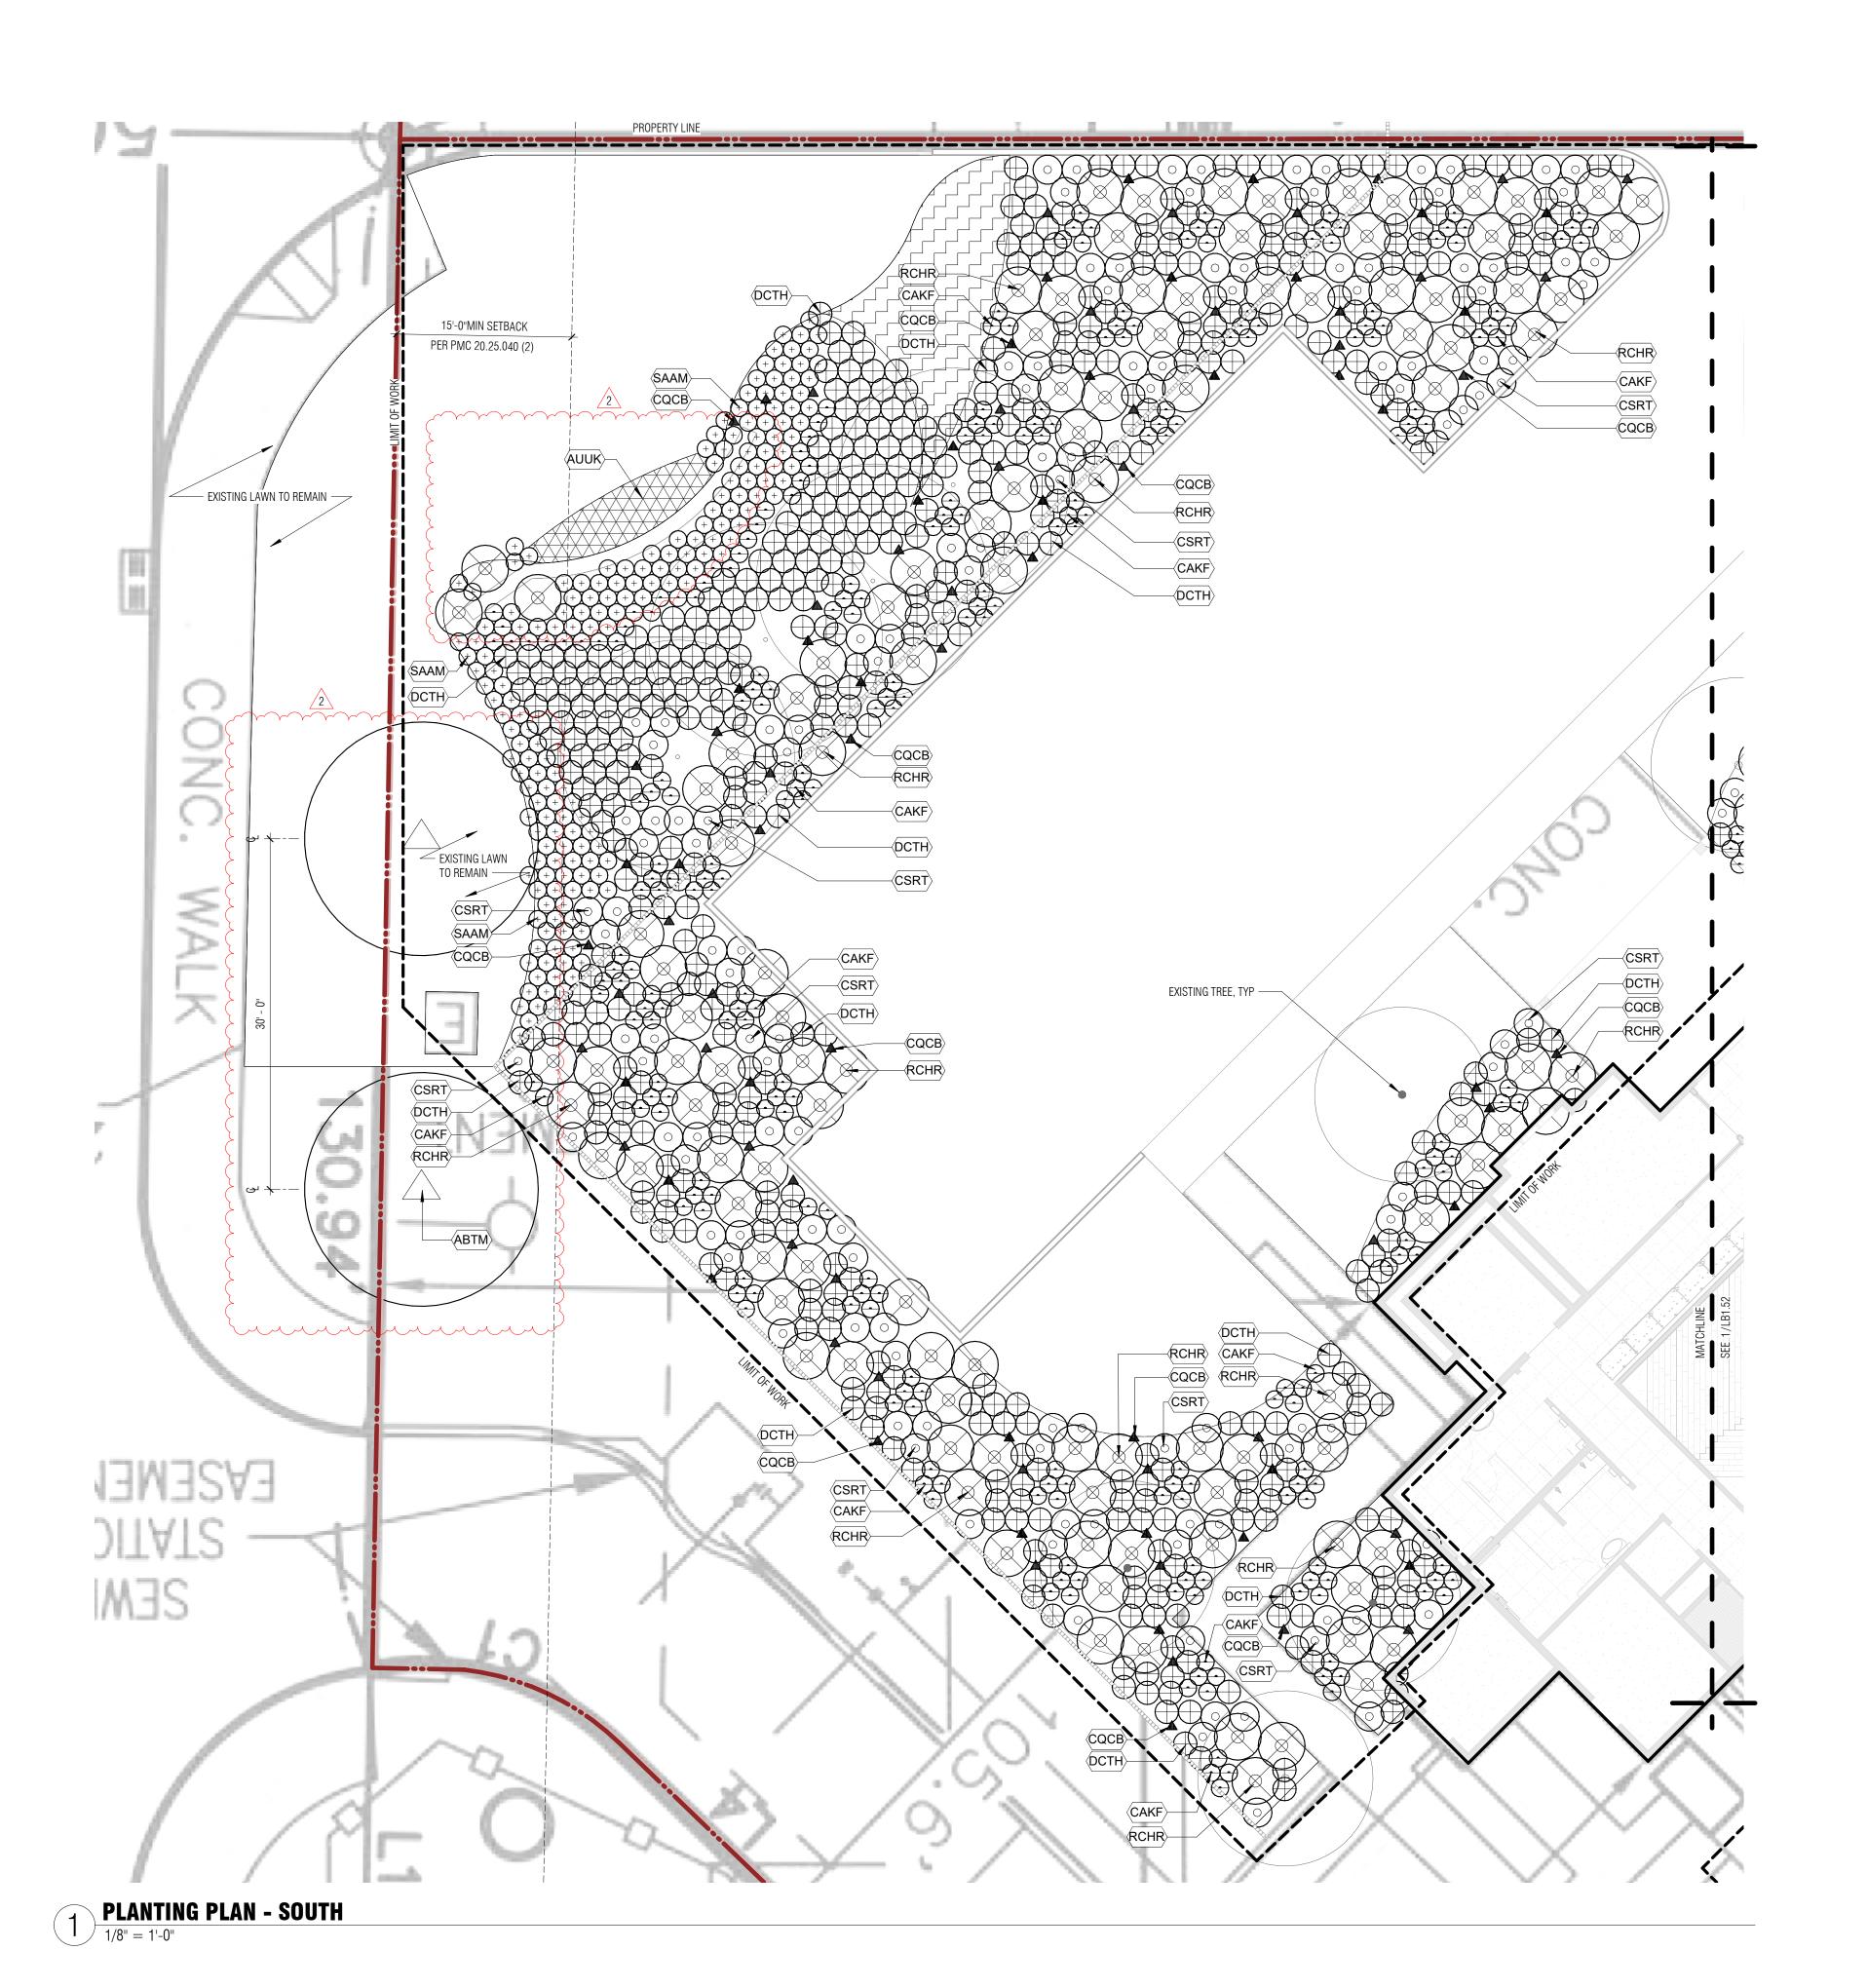

PLANTING LEGEND



UPPER BANK PLANTING SCHEME

RIVERSIDE PLANTING SCHEME



RIVERINE GRASSES PLANTING SCHEME

FLOWERING MEADOW PLANTING SCHEME

COMMON NAME **BOTANICAL NAME** ABTM ACER BUERGERIANUM TRIDENT MAPLE

TAG BOTANICAL NAME COMMON NAME

KARL FOERSTER FEATHER REED GRASS CAMASSIA QUAMASH CORNUS SERICEA 'KELSEYI' RED TWIG DOGWOOD DCTH DESCHAMPSIA CESPITOSA TUFTED HAIR GRASS RCHR RHODODENDRON X 'CUNNINGHAM'S WHITE' (H-2) CUNNINGHAM'S WHITE RHODODENDRON

RASPBERRY SPEAR CRABAPPLE

AUTUMN MOOR GRASS

SAAM SESLARIA AUTUMNALIS

MRSC MALUS 'JFS KW213MX' PP 31008


GROUNDCOVER TAG BOTANICAL NAME COMMON NAME

AUUK KINIKINNICK ARCTOSTAPHYLOS UVA-URSI







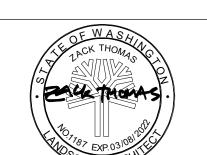

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CITY OF PUYALLUP STAMP AREA

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PROJE
1617 E
PUYAL
OWNEI

REVISION DATE

2 2022.11.18 CIVIL PERMIT RESPONSE

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PLANTING PLAN - SOUTH



(3) REQUIRED TREES PER 1:1 REPLACEMENT TREE REQUIREMENT - PLANTING TO REPLACE REMOVED HEDGE AND EXISTING TREE, TYP — PLANTING TO REPLACE REMOVED HEDGE AND EXISTING PLANTING TO REMAIN 318 1 PLANTING PLAN - NORTH 1/8" = 1'-0"

PLANTING LEGEND





RIVERSIDE PLANTING SCHEME





FLOWERING MEADOW PLANTING SCHEME

TAG BOTANICAL NAME

COMMON NAME

ABTM ACER BUERGERIANUM MRSC MALUS 'JFS KW213MX' PP 31008 TRIDENT MAPLE

RASPBERRY SPEAR CRABAPPLE

TAG BOTANICAL NAME

COMMON NAME KARL FOERSTER FEATHER REED GRASS

CAKF CALAMAGROTSIS ACUTIFLORA CQCB CAMASSIA QUAMASH CSRT CORNUS SERICEA 'KELSEYI'

RED TWIG DOGWOOD TUFTED HAIR GRASS

RCHR RHODODENDRON X 'CUNNINGHAM'S WHITE' (H-2) SAAM SESLARIA AUTUMNALIS

DCTH DESCHAMPSIA CESPITOSA CUNNINGHAM'S WHITE RHODODENDRON AUTUMN MOOR GRASS

GROUNDCOVER

TAG BOTANICAL NAME

COMMON NAME

AUUK KINIKINNICK ARCTOSTAPHYLOS UVA-URSI



UPPER BANK PLANTING SCHEME



RIVERINE GRASSES PLANTING SCHEME



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1617 E
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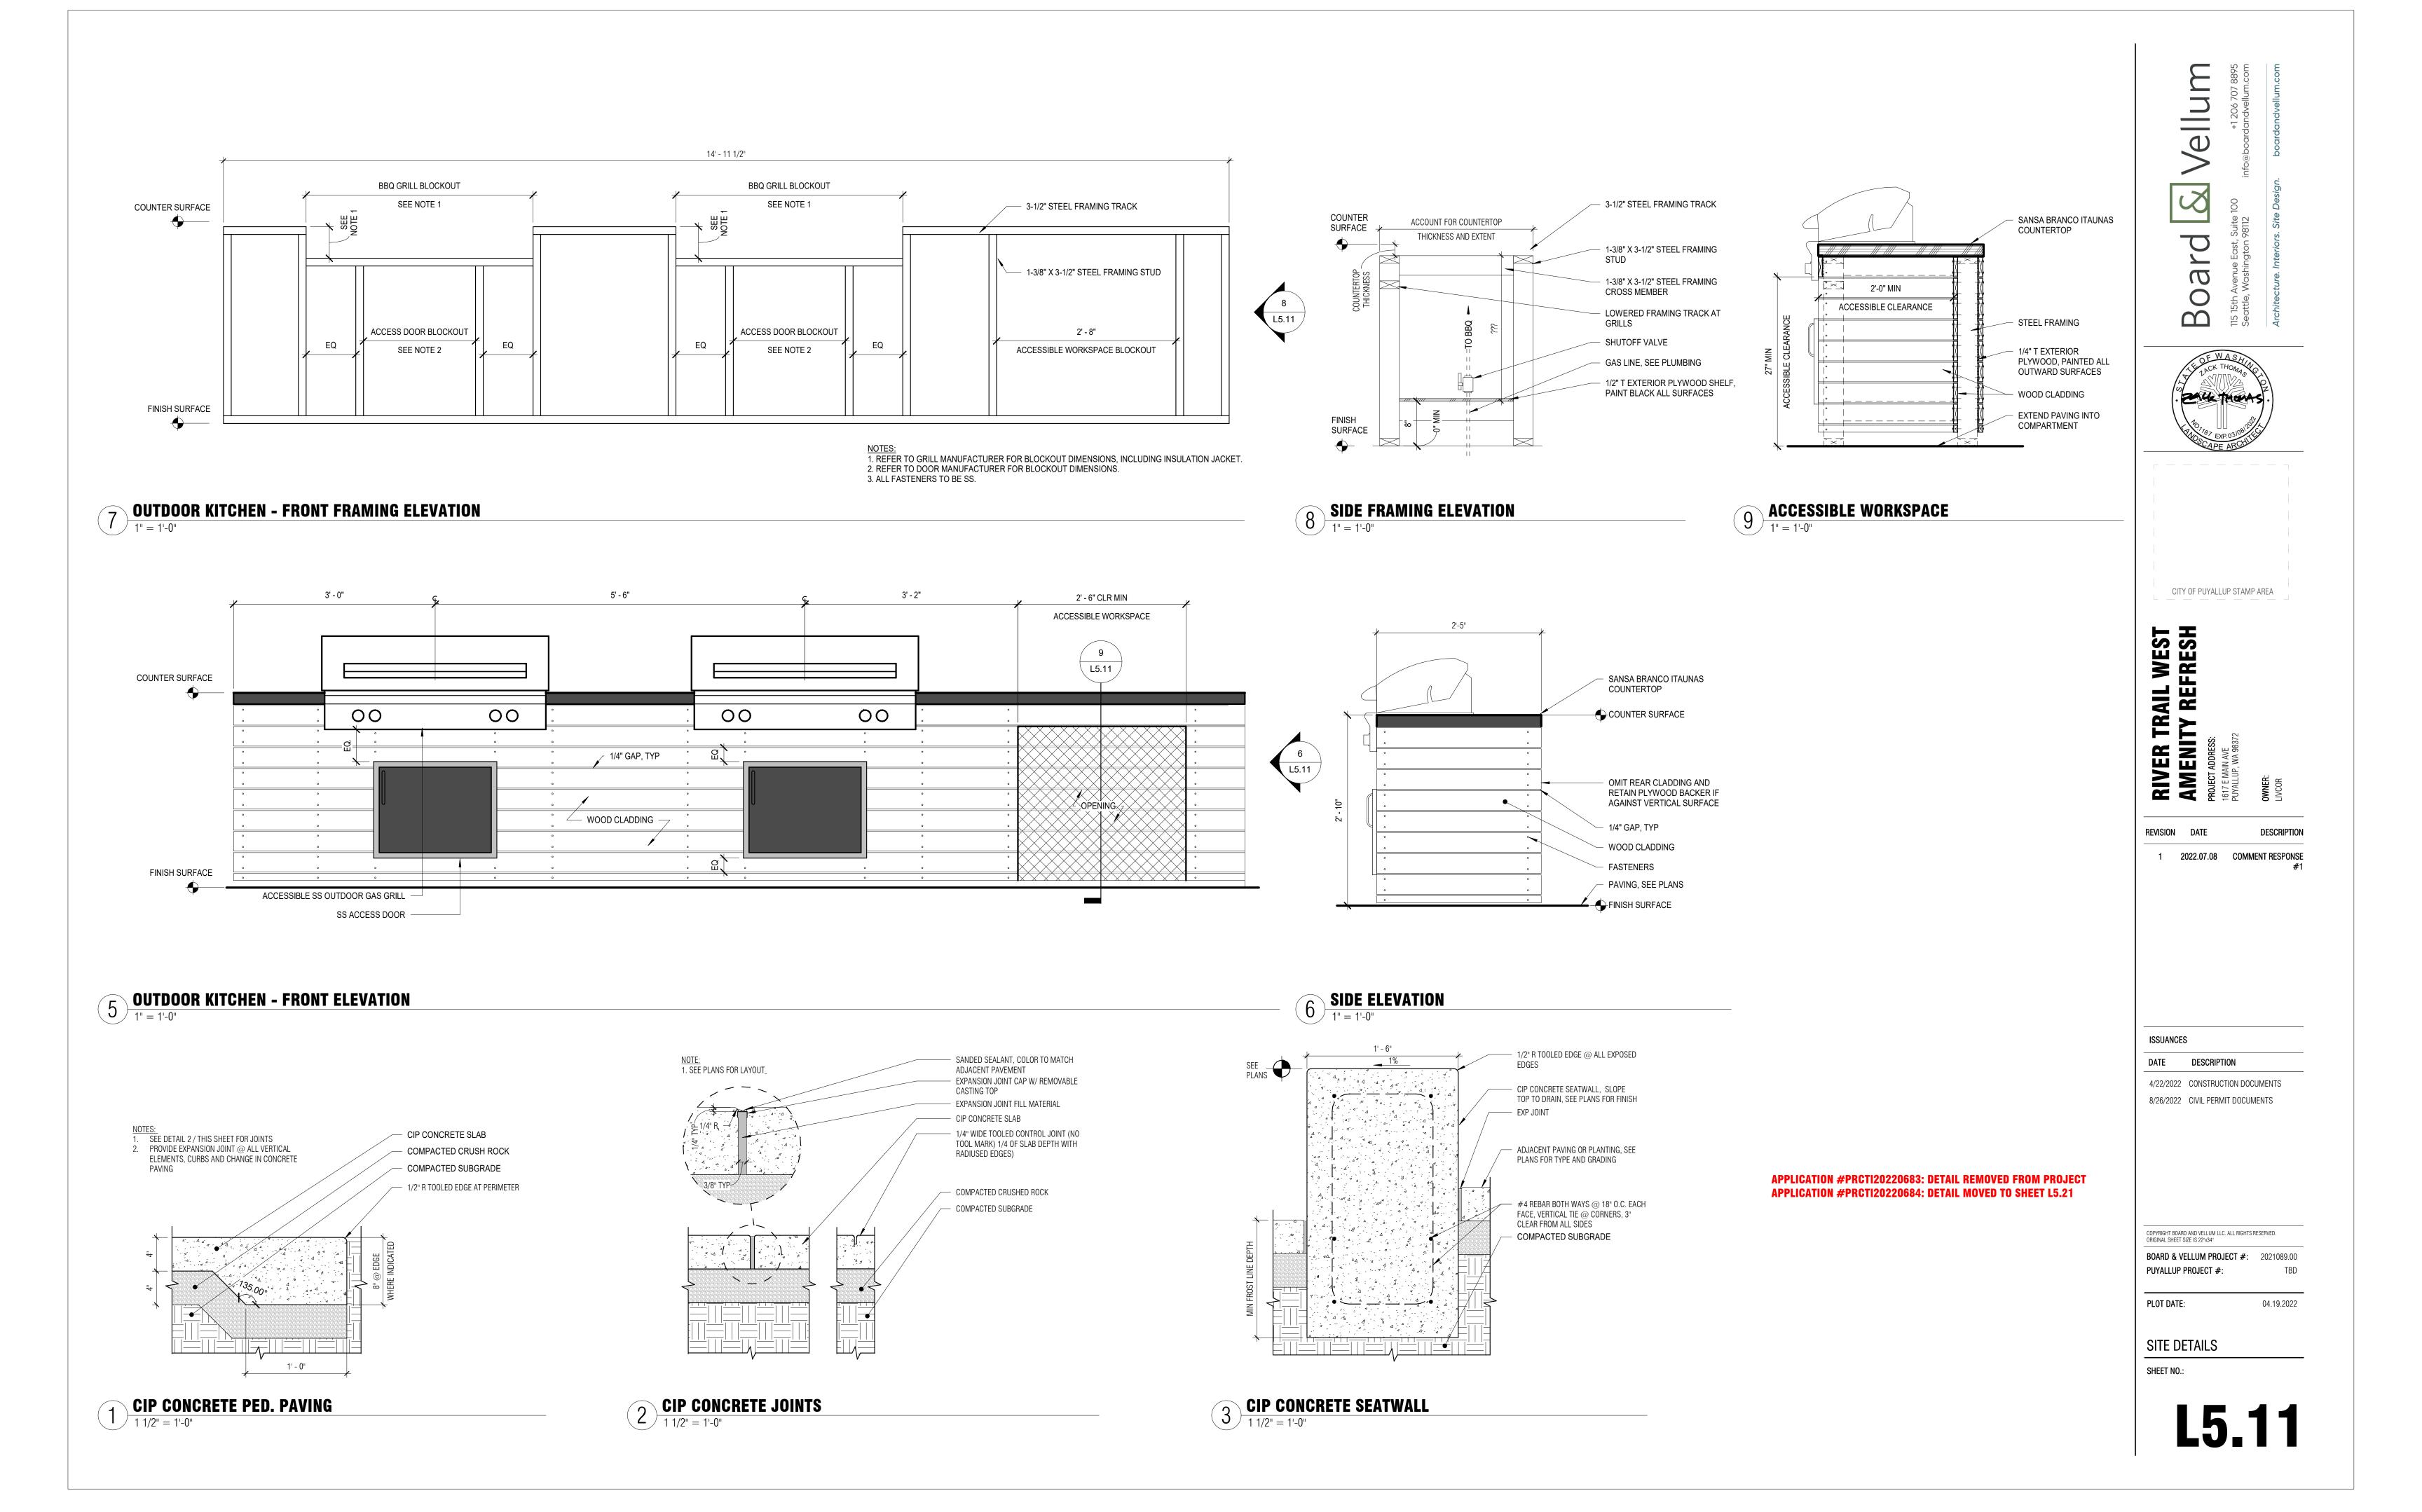
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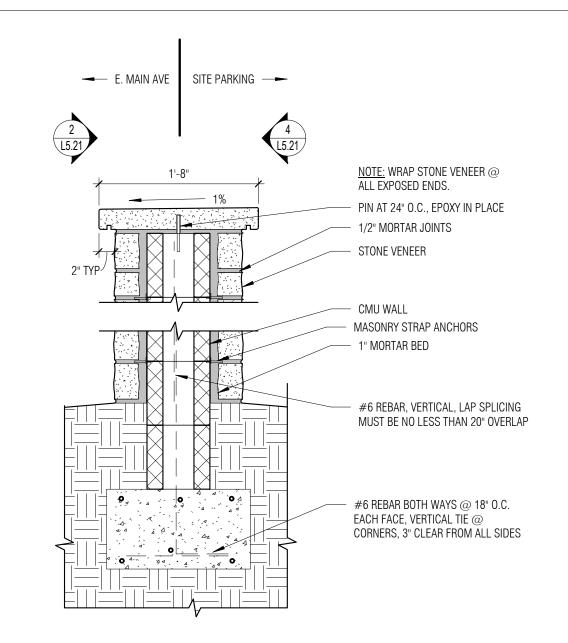
PLOT DATE:

PLANTING PLAN - NORTH


04.19.2022









LOW STONE VENEER LANDSCAPE WALL

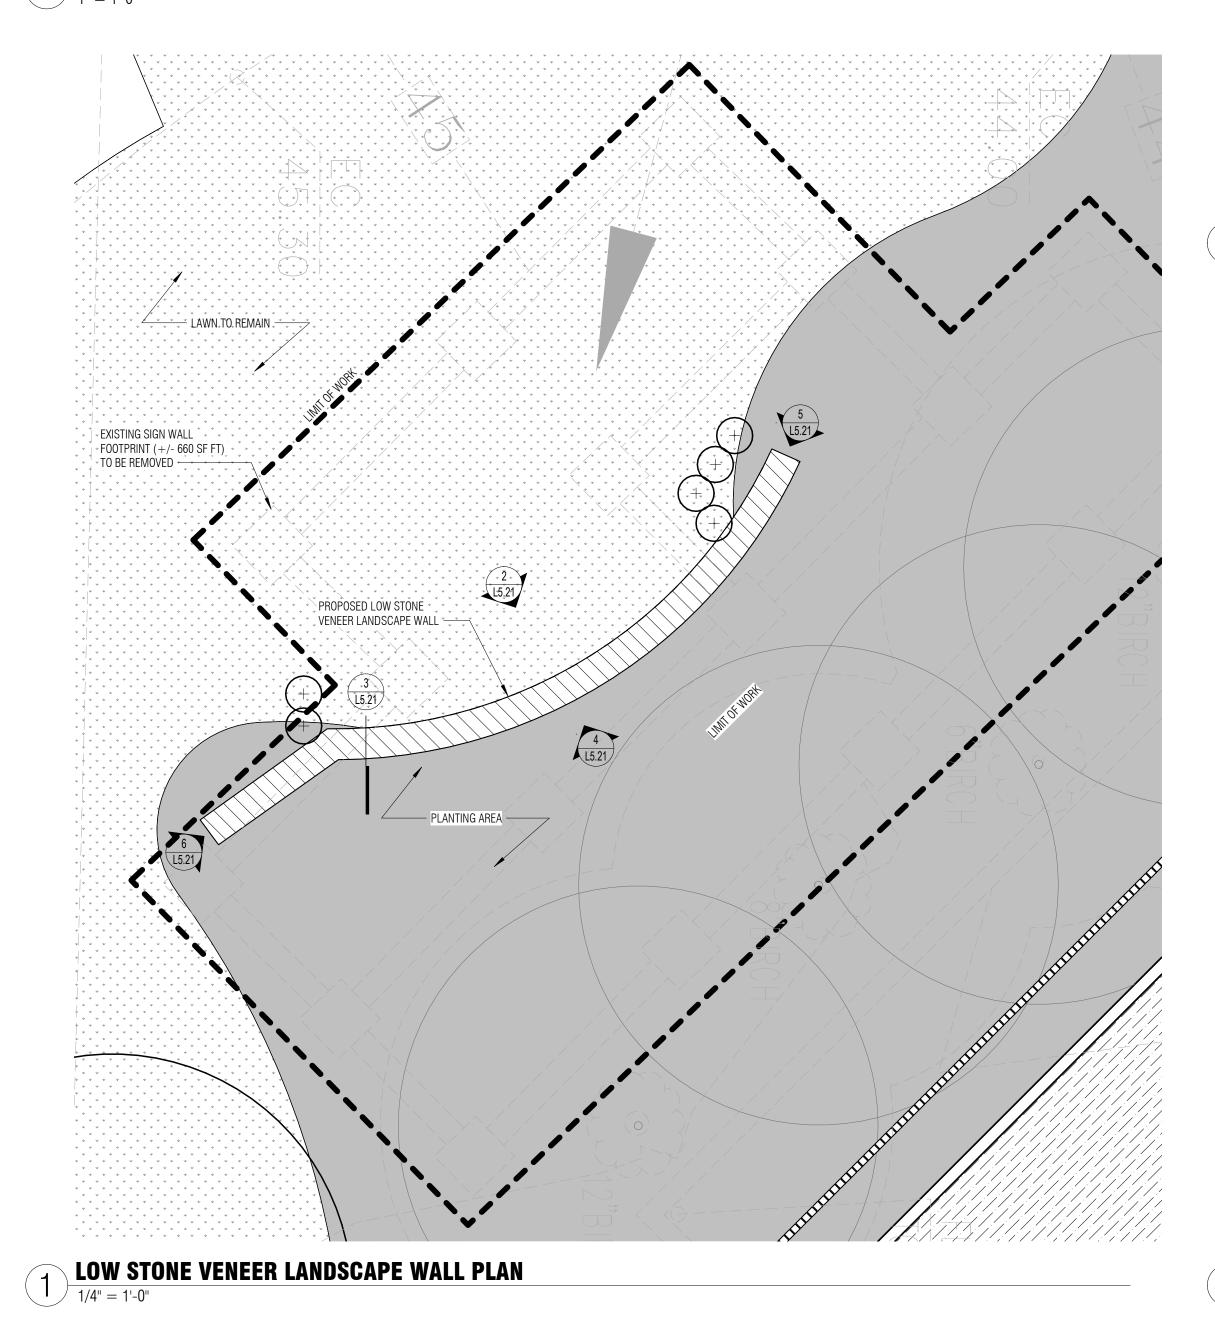

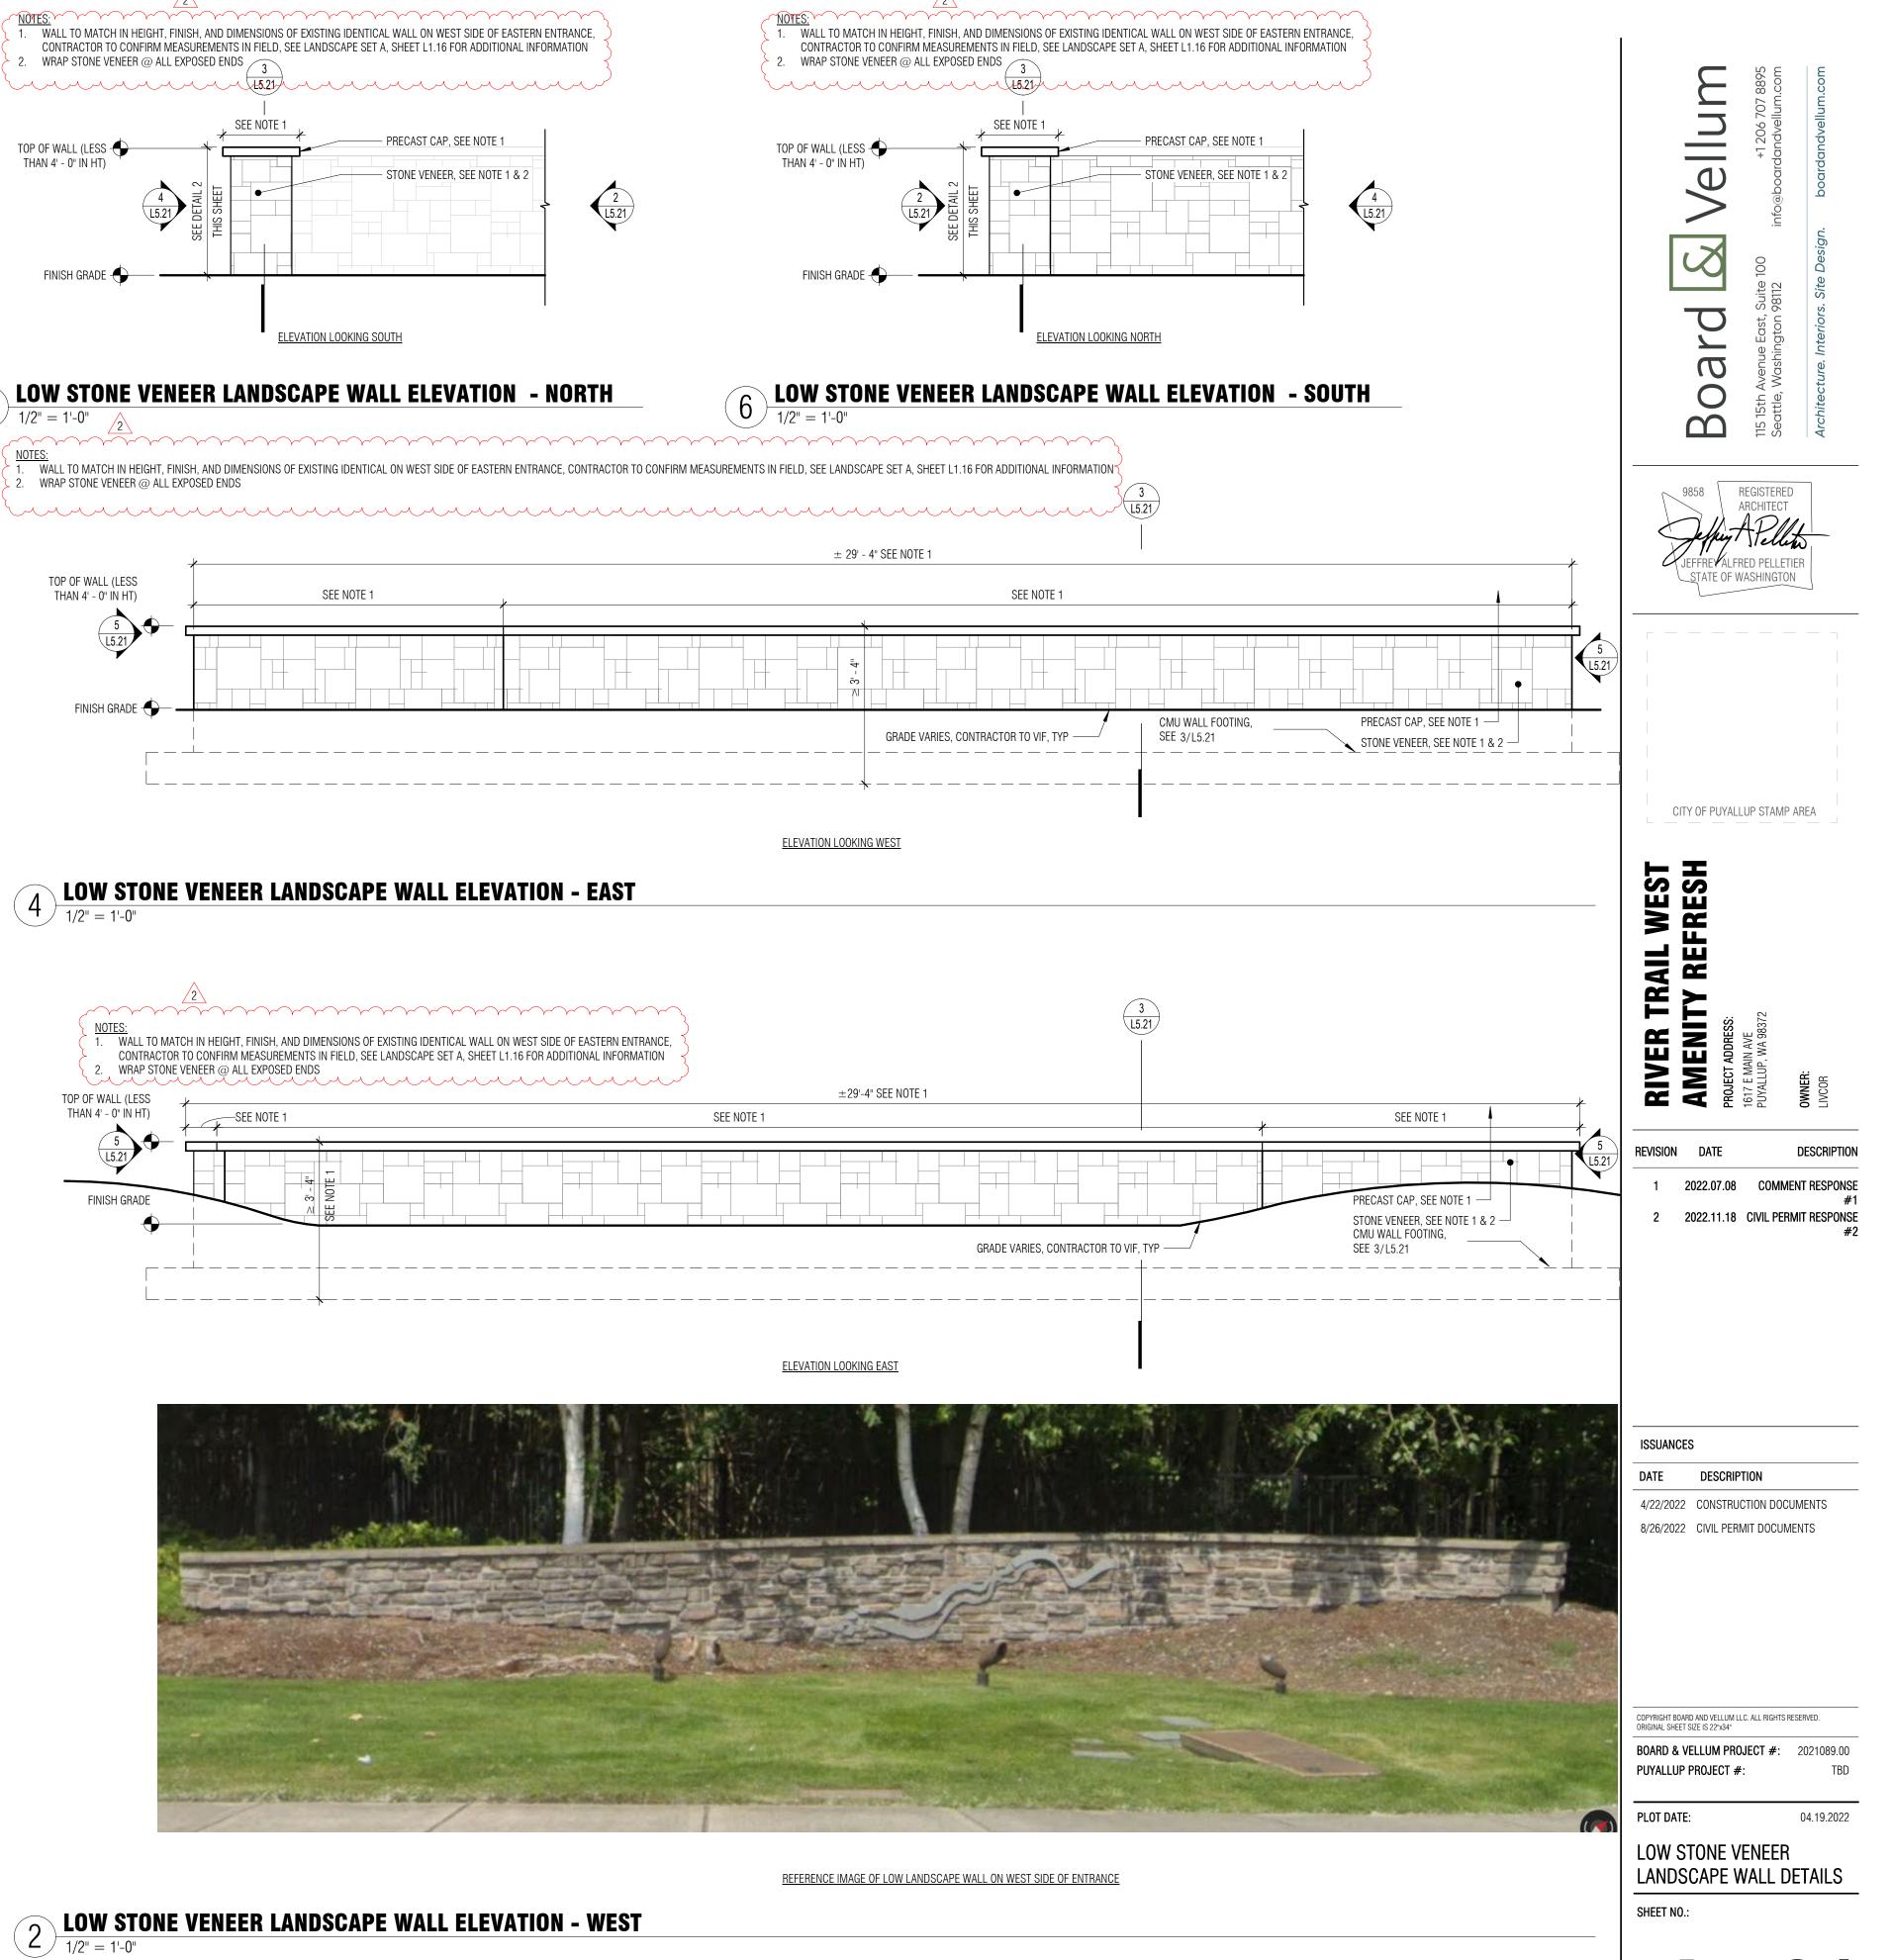

L5.21

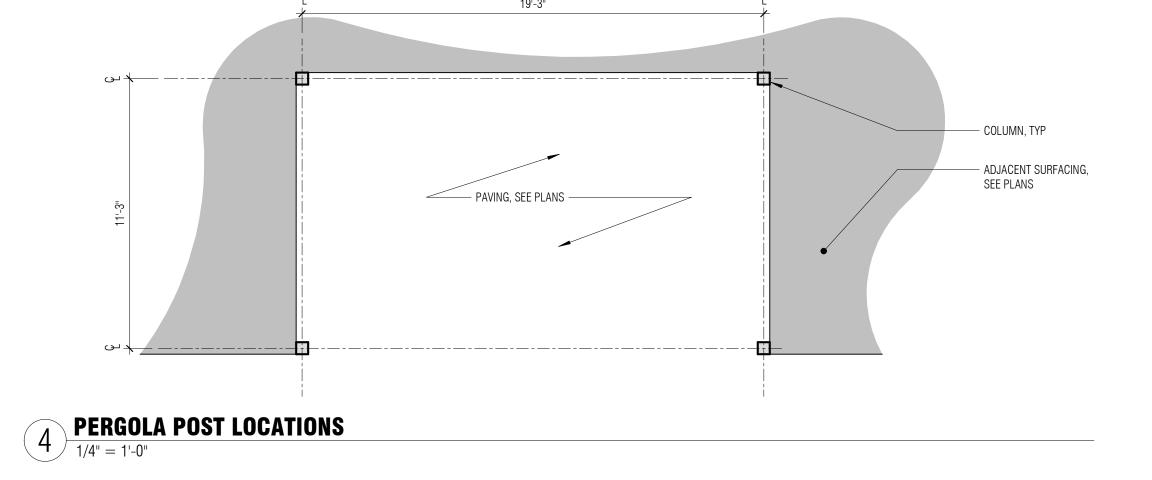

19'-3"

FRONT ELEVATION


PERGOLA ELEVATION - FRONT


1/4" = 1'-0"

11'-3"

SIDE ELEVATION

SLOPE TO DRAIN ———

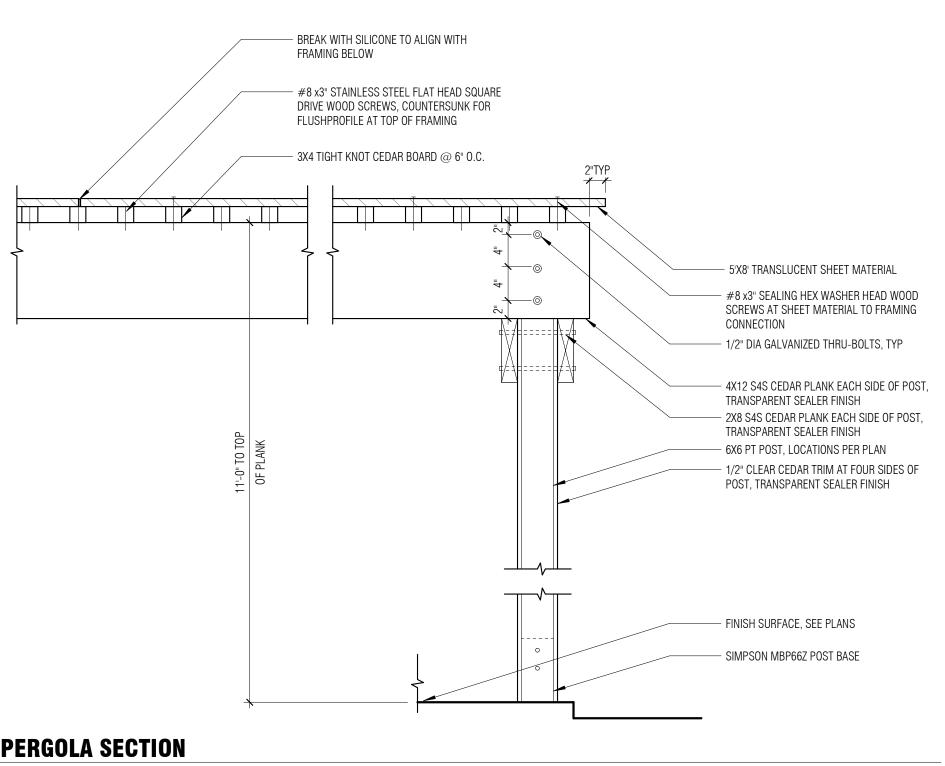

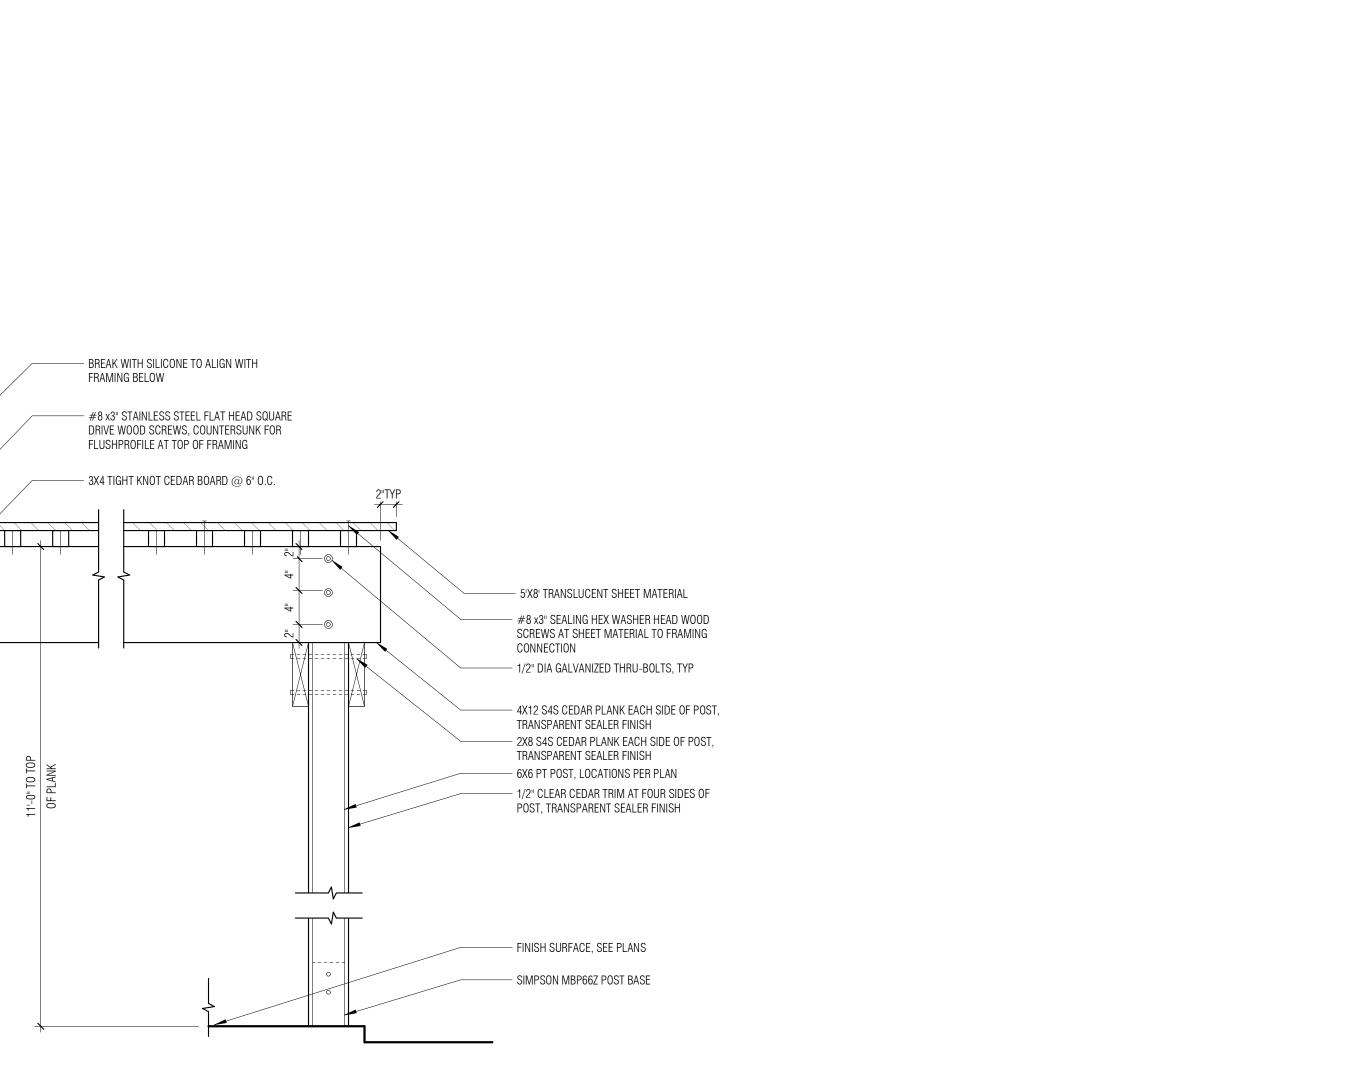

L5.31

CITY OF PUYALLUP STAMP AREA

RIVER TRAIL WEST
AMENITY REFRESH
1617 E MAIN AVE
PUYALLUP, WA 98372
UNCOR

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PUYALLUP PROJECT #:

PERGOLA DETAILS

PLOT DATE:

SHEET NO.:

BOARD & VELLUM PROJECT #: 2021089.00

04.19.2022