

City of Puyallup

Engineering APPROVED

See permit

conditions. ycharitou 12/12/2022 1:00:29 PM

City of Puyallup

ISSUED PERMIT

Building

Engineering

Fire

evelopment & Permitting Services

Planning

Public Works

TENANT IMPROVEMENT OF 1,354 SF IN VACANT SPACE FOR A NEW HAIR

BEARD TRIMS FOR WOMEN AND MEN. NO HAIR DYING. COLORING OR NAIL

SALON PROVIDING SERVICES FOR SHAMPOOING AND HAIR CUTS AND

HI HE CHEONG

SECTION 21 TOWNSHIP 20 RANGE 04 QUARTER 43: COM AT INTER OF N LI

STATE RD #5 WITH W LI 4TH ST NW TH N 69 DEG 21 MIN 30 SEC W ALG SD

DEG 38 MIN 30 SEC E 10 FT TH N 69 DEG 21 MIN 30 SEC W TO E LI 8TH ST

FROM INTER OF N LI STATE RD #5 WITH W LI 4TH ST NW TH S 00 DEG 17 MIN 31 SEC W 468.33 FT TO A LI PAR/W & 300 FT N OF N LI STATE RD #5 TH ALG SD PAR LI N 69 DEG 21 MIN 30 SEC W 149.81 FT TH S 00 DEG 17 MIN 31

EXISTING, NO CHANGE (68 FEET; UP TO 90 FEET WITH HEIGHT BONUSES)

RESIDENTIAL UNIT; 2 WEATHER-RPROTECTED BIKE PARKING SPACES PER

SEC W 300 FT TO POB OUT OF 4-035 SEG M-0640 TJ MJ EMS

CITY OF PUYALLUP MUNICIPAL CODE 2018 INTERNATIONAL BUILDING CODE 2018 INTERNATIONAL MECHANICAL CODE

2018 WASHINGTON STATE ENERGY CODE 2018 NATIONAL ELECTRICAL CODE 2018 INTERNATIONAL BUILDING CODE

EXISTING, NO CHANGE (55% ALLOWED)

EXISTING, NO CHANGE (65% MAX.)

GROUND FLOOR PUBLIC STREET TO BE COMMERCIAL

EXISTING, NO CHANGE (85% MINIMUM, 100%+ MAXIMUM; 1 PER

ENVELOPE IS EXISTING, NO CHANGE IN ENVELOPE OR USE

CLASSIFICATION "BEAUTY SALONS". A QUALIFIED MECHANICAL

2018 INTERNATIONAL FIRE CODE 2018 UNIFORM PLUMBING CODE

RMX - RIVER ROAD MIXED USE

464,393 SF (10.661 ACRES)

91,653 SF

36,500 SF

180 SF

1,453 SF

12 - 20 FEET

12 - 20 FEET 10 FEET

III-B, SPRINKLERED

EXISTING, NO CHANGE IN USE

6 FEET

NW EXT N TH N ALG SD EXT LI TO SLY LI OF INTER-CO-RIV-IMP R/W TH ELY ALG SD S LI TO A PT BEARING N 00 DEG 17 MIN 31 SEC E FROM A PT LY N 00 DEG 17 MIN 31 SEC E 300 FT & N 69 DEG 21 MIN 30 SEC W 420.19 FT

VICINITY MAP

TENANT IMPROVEMENT

SERVICES WILL BE OFFERED.

EMAIL SEATTLE010600@YAHOO.COM

C/O MK PROPERTY SERVICES LLC

6301 DISCOVERY ST E

SOUND PROPERTIES LLC

SNOQUALMIE, WA 98065-0997

FIFE, WA 98424

T 206.858.1020

PO BOX 997

0420214051

COMMERCIAL

709 RIVER ROAD PUYALLUP, W<u>A</u> 9837[,]

G CLIPS

IMPROVEMENT CLIPS

TENANT

709 RIVER ROAD PUYALLUP, WA 98371

TENANT: JI HE CHEONG 6301 DISCOVERY ST E FIFE, WA 98424 T 206.858.1020 EMAIL SEATTLE010600@YAHOO.COM

GENERAL CONTRACTOR

KEYSTONE NW INC 13510 N CREEK DRIVE, SUITE K207 MILL CREEK, WA 98012-2095

CONTACT: EUGENE KIM T 425.879.6628 N LI STATE RD #5, 570 FT TO POB TH CONT ALG SD N LI 705.72 FT TH N 20 EMAIL EUGENEKIMKEYLAND@HOTMAIL.COM CONTRACTOR LICENSE # KEYSTNR1826JC

PERMIT SET

UBI # 604-189-027

REV

29 DEC 2022 | COP CORR CYCLE #01

City of Puyallup Building **APPROVED** ISSUE/REVISIONS

See permit for additional NO DATE requirements. **JMontgomery** 01/24/2023 2:52:52 PM

PROJECT NO 22032

DATE 23 SEPTEMBER 2022

DESIGN DRAWN BY

SITE PLAN &

SHEET INDEX

VERIFY THAT EXISTING HVAC SYSTEM MEETS THE REQUIREMENTS OF CHECKED 2018 IBC TABLE 403.3.1.1 MINIMUM VENTILATION RATES FOR OCCUPANCY

GENERAL INFO, CONTRACTOR SHALL MAKE MEASUREMENTS TO MEET THE CALCULATIONS AS SHOWN IN TABLE ON SHEET A1.2 FOR 'G CLIPS'. COMMISSION TEST WILL BE REQUIRED PRIOR TO FINAL INSPECTION. VICINITY MAP,

2018 WSEC COMMERCIAL LIGHTING REQUIREMENTS 2018 WSEC COMMERCIAL LIGHTING REQUIREMENTS & LIGHTING SUMMARY; 2018 IBC TABLE 4.3.3.1.1 MAIN FLOOR & MAIN FLOOR REFLECTED CEILING PLANS; LIGHT FIXTURE SCHEDULE **BUILDING SECTION**

A4.0 A9.0 BATHROOM FIXTURES & ACCESSORIES MOUNTING HEIGHTS; SUSPENDED CEILING DETAILS; PLUMBING FIXTURE COUNT

PARTITION TYPES

ROOM FINISH & DOOR SCHEDULES P2.0 MAIN FLOOR PLUMBING PLAN

GENERAL INFO, VICINITY MAP, SITE PLAN & SHEET INDEX

PRCTI20221702



2 SITE PLAN

SCALE: 1" = 50'-0"

APPROVED BY: GClark

CASE NO.: PRCTI20221702

DATE: 12/08/2022

CONDITIONS:

Approval of submitted plans is not an

THE APPROVED CONSTRUCTION PLANS, DOCUMENTS AND ALL ENGINEERING MUST BE POSTED ON THE JOB AT ALL INSPECTIONS IN A VISIBLE AND READILY ACCESSIBLE LOCATION.

FULL SIZED LEDGIBLE COLOR PLANS ARE REQUIRED TO BE PROVIDED BY THE PERMITEE ON SITE FOR INSPECTION

approval of omissions or oversights by this office or noncompliance with any applicable regulations of local government. The contractor is responsible for making sure that the building complies with all applicable codes and regulations of the local

government.

A9.1

A2.0

Lighting, Motor and Electrical Requirements List, pg 1 of 10

2018 WSEC Requirements for Commercial Buildings including Group R2, R3 & R4 over 3 stories & all R1 -- Administered by ©2022 NEEA, All rights reserved The following information is necessary to check a permit application for compliance with the lighting systems, motors and electrical system requirements in the Washington State Energy Code, Commercial Provisions.

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Tenant Improvement G CLIPS - 2018 WSEC

709 River Road Puyallup, WA 98371

. ayamap,	***************************************	Date: 2022-0			
Applies	Code Section	Component	Compliance Information Required In Permit Documentation	Location in Documents	Building Department Notes
LIGHTING	SCOPE				
NA	C103.1	Construction documents - General	For a shell & core or tenant space (first build- out) project, indicate if there is no lighting scope included in the project.		
	C103.1	Construction documents - General	For an alteration project, indicate if there is no lighting scope included in the project.		
LIGHTING	CONTROLS				
	C405.2	Lighting controls, general	For all lighting fixtures, indicate lighting control method on plans for spaces and lighting zone(s) served, or exception taken		
	C405.2, Option 2	Luminaire level lighting controls (LLLC)	Indicate on plans all fixtures provided with LLLC in lieu of C405.2 lighting controls; provide description of control capabilities and performance parameters		
	C405.2.5, Item 3 C405.2.1.1 C405.2.3.1	Lighting in dwelling units (dormitory, hotel and all other than multifamily)	Indicate method of automatic control of all installed luminaires in dwelling units in buildings other than multifamily (occupancy or light reduction controls)		
	C405.2.5, Item 2	Lighting in sleeping units	Indicate method of automatic off control of all installed luminaires in sleeping units (vacancy or key card control); also refer to Receptacles		
	C405.2.3 C405.2.3.1 C405.2.5	Manual controls	Indicate on plans the method of manual lighting control, location of manual control device and the area or specific application it serves		
	C405.2.3.1 C405.2.1.1 C405.2.4	Manual interior light reduction controls	Indicate on plans which method of manual 50% lighting load reduction is provided, or indicate applicable exception		
	C405.2.1 C405.2.2.1 C405.2.1, Exception 3	Method of automatic shut-off control	Indicate on plans the method of automatic shut-off control during unoccupied periods (occupancy sensor, time switch or digital timer switch) for all lighting zones		
	C405,2.1	Occupant sensor controls	Indicate on plans all luminaires that are controlled by occupant sensor controls; indicate controls are configured to turn luminaires 100% off when the space is unoccupied		
	C405.2.1 C405.2.1.1	Occupant sensor controls	Indicate if occupant sensor controls are configured to be manual on or automatic on to not more than 50% power; indicate spaces eligible for exception that allows automatic on to 100% power		

Lighting, Motor and Electrical Requirements List, pg 2 of 10

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Washington State For questions abo			Technical Support at 360-539-5300 or via email a	t com.techsupport@waenergycodes.com
	C405.2.1.2	Occupant sensor controls - warehouses spaces	Indicate each aisleway and corridor within a warehouse space are designated as separate zones that are independently controlled	
YES			Indicate occupant sensors are configured to automatically reduce lighting power by 50% when the zone is unoccupied and 100% off after the zone is unoccupied for over 20 minutes; indicate controls are configured to automatically restore lighting to full power when the zone or space is occupied	A2.0
YES	C405.2.1.3	Occupant sensor controls - open plan office areas	For open plan office areas larger than 300 sf, indicate general lighting is provided with vacancy controls that reduce lighting power by not less than 80% and are configured to turn luminaires 100% off when the space is unoccupied; indicate that no individual control zone area exceeds 600 sf	A2.0
	C405.2.1.4	Occupant sensor controls - parking garages	Indicate parking garage general lighting is provided with vacancy controls that reduce lighting power by not less than 30% and are configured to turn luminaires 100% off when no vehicles or pedestrians are present, unless eligible for an exception; indicate that no individual control zone area exceeds 3,600 sf	
NA	C405.2.1.5	Occupant sensor controls - enclosed fire-rated stairwells	Indicate stairway lighting is provided with vacancy controls that reduce lighting power by not less than 50% when the stairway in unoccupied	
YES	C405.2.2.1	Automatic time switch controls	Indicate spaces on plans where time switch controls turn luminaires 100% off during unoccupied hours	
NA			Indicate spaces on plans where time switch controls are configured to turn on lighting to full power versus 50% power	
			Indicate locations of override switches on plans and the lighting zone(s) served; indicate that the area(s) served by each override switch does not exceeds 5,000 sf	
	C405.2.1, Exception 3	Digital timer switch	Indicate digital timer switch control includes: manual on/off, time delay, audible and visual indication of impending time-out	
	C405.2.4.2 C405.2.4.3	Daylight zones - Sidelit and toplit	Indicate primary and secondary sidelit daylight zone floor areas on plans	
			Indicate toplit daylight zone floor areas on plans	
			For small vertical fenestration assemblies (rough opening less than 10 percent of primary daylight zone floor area) where daylight responsive controls are not required, provide fenestration area to daylight zone floor area calculation(s)	

Lighting, Motor and Electrical Requirements List, pg 3 of 10

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C	C405.2.4	Daylight responsive controls	Indicate on plans lighting zone(s) served by daylight responsive controls; indicate that the area served by each control device does not exceeds 2,500 sf	
			Identify sidelit and toplit daylight zones that are not provided with daylight sensing controls and the exception(s) that apply	
C	C405.2.4.1.1	Daylight responsive controls	Indicate on plans the lighting load reduction method (continuous dimming, or stepped dimming that provides at least two even steps between 0%-100% of rated power)	
C	C405.2.4.1	Daylight responsive controls	Indicate that daylight sensing controls are configured to completely shut off all controlled lights in the lighting zone	
C	C405.2.5	Additional controls - Specific application lighting controls	Identify spaces and lighting fixtures on plans that require specific application lighting controls per this section	
	C405.2.5, tem 1	Display and accent lighting	Indicate on plans that manual controls are provided that control display, accent lighting and display case lighting independently from both general area lighting and other lighting applications within the same space	
			Indicate manual and automatic (occupant sensor or time switch) lighting control methods	
	C405.2.5, tem 3	Hotel/motel guest rooms	Indicate method of automatic control - vacancy or captive key control of all installed luminaires and switched receptacles in guest room	
	C405.2.5, tem 1	Supplemental task lighting	Indicate method and location of manual and automatic shut-off control (occupant sensor or time switch) for supplemental task lighting, including under-shelf or under-cabinet lighting	
	C405.2.5, tem 1	Lighting equipment for sale or demonstration	Indicate on plans that lighting equipment for sale or demonstration are controlled independently from both general area lighting and other lighting applications within the same space	
			Indicate manual and automatic (occupant sensor or time switch) lighting control methods	
	C405.2.5, tem 4	Lighting for non- visual applications	Identify all eligible non-visual lighting applications on plans; indicate that the area served by each control device does not exceeds 4,000 sf	
			Indicate on plans that non-visual lighting are controlled independently from both general area lighting and other lighting applications within the same space	

Lighting, Motor and Electrical Requirements List, pg 4 of 10

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			Indicate method of manual lighting control and applicable automatic lighting control	
	C405.2.5, Item 5	Means of egress lighting	Identify on plans egress fixtures that function as both normal and emergency means of egress illumination	
			Provide calculation of lighting power density of total egress lighting	
			If total egress lighting power density is greater than 0.02 W/sq. ft., indicate on plans egress fixtures requiring automatic shut-off during unoccupied periods	
			Indicate method of automatic shut-off control	
NA	C405.4.1 C405.4.2	Lighting control of exempt interior lighting	Indicate that exempt interior lighting equipment and lighting located within spaces that are eligible for a lighting power exemption are controlled independently from non-exempt and general area lighting	
	C405.2.6	Exterior lighting controls	For decorative exterior lighting, indicate on plans automatic daylight shut-off controls, or exception taken	
			For exterior lighting that is not decorative, indicate on plans automatic daylight or timeswitch shut-off controls and setback controls; or indicate exception taken	
			For lighting requiring setback controls, include control sequence that reduces lighting power by at least 30% between 12am-6am, or from 1 hour after closing to 1 hour before opening, or based upon motion sensor	
			For building facade and landscape lighting, indicate control sequence for shut-off control is based on dawn-to-dusk and business opening/closing schedule; indicate whether automatic or time switch controls will be provided for this function	
	C405.5.2	Lighting control of exempt exterior lighting	Indicate that exempt exterior lighting and lighting located within exterior areas/surfaces that eligible for a lighting power exemption are controlled independently from non-exempt exterior lighting	
	C405.5.4	Exterior gas-fired lighting appliances	Indicate ignition system is a method other then continuously burning pilot light	
	C405.2.7	Area controls - Master control switches and circuit power limit	Indicate location(s) of master control switch(es) intended to control multiple independent switches; circuit breaker may not be used as a master control switch	
			Verify that no 20 amp circuit controlled by a single switch or automatic control is loaded beyond 80%	

Lighting, Motor and Electrical Requirements List, pg 5 of 10

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1 or quodiono t	about this report, oo	ntact WOLO Commercial	Teermodi Gapport at 000 000 000 or via emair a	t dom.teemaapport@wae	nergy codes.com
	C406.4	Enhanced digital lighting controls	To comply with additional efficiency credit, indicate on plans that interior lighting fixtures are configured with all of the following control functions, as applicable: 1) Each fixture is individually addressed, or exception taken; 2) Fixtures are configured for continuous dimming; 3) No more than eight fixtures are controlled by a single daylight sensor; 4) In enclosed and open office areas, illumination levels of overhead general area lighting is configured to be individually adjusted by occupants		
			Include calculations that demonstrate the total lighting power of all interior lighting fixtures configured with enhanced lighting controls is no less than 90% of the total interior lighting power for the area the enhanced lighting controls credit is being applied to		
INTERIOR	LIGHTING POW	ER & EFFICACY			
YES	C405.4.1 C405.4.2	Total connected interior lighting power	Include all luminaires in interior lighting fixture schedule; indicate fixture types, lamps, ballasts, and manufacturer's watts per fixture for the installed lamp	A2.0	
NA			Identify spaces eligible for lighting power exemption on plans and in WSEC interior lighting compliance reports; indicate the exception applied		
NA			Identify lighting equipment eligible for lighting power exemption in fixture schedule and in WSEC interior lighting compliance reports; indicate the exception applied		
	C405.1.1	Lighting in dwelling units (multifamily)	For all installed luminaires, include lamp type and number of lamps in lighting fixture schedule; for lamps that are not LED, T-8 or small diameter fluorescent, indicate efficacy of other lamp types is 65 lumens per watt or greater		
			For all installed luminaires, indicate in lighting fixture schedule whether complying via lighting power density or by qualifying lamp type; if by lamp type, include number of lamps		
			For all installed luminaires, indicate in lighting fixture schedule whether complying via lighting power density or by qualifying lamp type; if by lamp type, include number of lamps		
INTERIOR	LIGHTING POW	ER CALCULATION -	INDICATE COMPLIANCE PATH TAKEN		
NA	C405.4.2.1	Building Area Method	Demonstrate that total proposed wattage per building area does not exceed maximum allowed wattage per building area; identify locations of building areas on plans; provide WSEC exterior lighting compliance reports		

Lighting, Motor and Electrical Requirements List, pg 6 of 10

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C405.4.2.2	Space-By-Space Method	Demonstrate that total proposed wattage does not exceed maximum allowed wattage; identify locations of space types on plans, including retail display areas and areas with display, highlight and decorative lighting; provide WSEC exterior lighting compliance reports	A1.1, A1.2, A2.0
AL EFFICIENCY	CREDITS - REDUCED	INTERIOR LIGHTING POWER DENSITY	7
C406.3.1 C406.3.2	Reduced interior lighting power density	To comply with additional efficiency credit, demonstrate that total connected interior lighting wattage is 10% or 20% less than the total maximum allowed lighting wattage for the area the reduced lighting power credit is being applied to; indicate whether lighting power allowance is based on the building area method or space-by-space method; provide WSEC exterior lighting compliance reports	
C406.3	Reduced interior lighting power density - dwelling unit lamp efficacy	For project with dwelling units, to comply with additional efficiency credit indicate in lighting fixture schedule that lamps within installed interior luminaires have an efficacy rating of at least 65 lumens per watt; include number of lamps and provide calculations that demonstrate at least 95% of lamps have this efficacy rating	
R LIGHTING POW	ER & EFFICACY		
C405.5.2	Total connected exterior lighting power	Include all luminaires in exterior lighting fixture schedule; indicate fixture types, lamps, ballasts, and manufacturer's watts per fixture for the installed lamp	
		Identify exterior applications eligible for lighting power exemption on plans and in WSEC exterior lighting compliance reports; indicate exception applied	
C405.5.3(1)	Exterior lighting zone	Indicate building exterior lighting zone as specified by the AHJ	
C405.5.1	Exterior building grounds lighting	For building grounds fixtures rated at greater than 50 watts, indicate rated lamp efficacy (in lumens per watt) in fixture schedule	
R LIGHTING POW	ER CALCULATION		
C405.5.3	Tradable allowances	Demonstrate that total proposed tradable surface wattage does not exceed maximum allowed tradable surface wattage (including base site allowance); identify locations of tradable surfaces on plans; provide WSEC exterior lighting compliance reports	
	C406.3.1 C406.3.2 C406.3.2 C406.3.2 C406.3.3 C406.3 C405.5.2	AL EFFICIENCY CREDITS - REDUCED C406.3.1 C406.3.2 Reduced interior lighting power density C406.3 Reduced interior lighting power density - dwelling unit lamp efficacy C405.5.2 Total connected exterior lighting power C405.5.1 Exterior lighting zone C405.5.1 Exterior building grounds lighting	Method Not exceed naximum allowed wattage; identify locations of space types on plans, including retail display areas and areas with display, highlight and decorative lighting; provide WSEC exterior lighting compliance reports AL EFFICIENCY CREDITS - REDUCED INTERIOR LIGHTING POWER DENSITY

Lighting, Motor and Electrical Requirements List, pg 7 of 10

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			Demonstrate that proposed wattage per non-tradable surface type does not exceed maximum allowed wattage per non-tradable surface type (including base site allowance remaining after tradable allowance calculation); identify locations of non-tradable surfaces on plans; provide WSEC exterior lighting compliance reports	
LIGHTING A	LTERATIONS			
	C503.6.1	Interior and parking garage lighting fixture alterations	Where ≥ 50% of existing luminaires in an interior space or parking garage are replaced; indicate compliance path (building area or space-by-space method); include all new and existing-to-remain luminaires in WSEC interior lighting compliance reports; indicate proposed lighting wattage does not exceed maximum allowed per compliance path	
			Where < 50% of existing luminaires in an interior space or parking garage are replaced; indicate total existing lighting wattage in each space prior to alteration; include all new and existing-to-remain luminaires in WSEC interior lighting compliance reports; indicate proposed total lighting wattage in alteration area does not exceed total existing lighting wattage prior to alteration	
			Where ≥ 50% of existing exterior lighting wattage is replaced; include all new and existing-to-remain luminaires in WSEC exterior lighting compliance reports; indicate proposed total exterior lighting wattage does not exceed maximum allowed	
			Where < 50% of existing exterior lighting wattage is replaced; indicate total existing lighting wattage prior to alteration; include all new and existing-to-remain luminaires in WSEC interior exterior compliance reports; indicate proposed total exterior lighting wattage does not exceed total existing wattage prior to alteration	
	C503.6.2	Interior lighting wiring and circuiting alterations	Where new wiring is installed to serve new interior luminaires and /or luminaires are relocated to a new circuit; indicate manual and automatic lighting controls are provided (as applicable) - manual (C405.2.3); occupancy sensor (C405.2.1); light reduction (C405.2.3); daylight responsive (C405.2.4); specific application (C405.2.5)	
			Where new wiring is installed to serve new exterior luminaires and /or luminaires are relocated to a new circuit; indicate automatic lighting controls are provided (C405.2.6)	

Lighting, Motor and Electrical Requirements List, pg 8 of 10


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	C503.6.3	Lighting panel alterations	Where a new interior and/or exterior lighting panel is installed or an existing panel is moved (all new raceway and conductor wiring), indicate all applicable lighting controls requirements apply	
	C503.6.4	Newly-created rooms	Where interior space(s) is reconfigured (permanently installed walls or ceiling-height partitions) to create new enclosed spaces, indicate all applicable lighting controls requirements apply	
	C504.2	Lighting repairs	Identify existing luminaires being upgraded with bulb and / or ballast replacement; indicate fixture alteration does not increase existing fixture wattage	
	C505.1	Change of interior space use	Identify spaces on plans where the building area type or space use type is being changed from one type to another per Tables C405.4.2(1) or (2)	
			Indicate compliance method (building area or space-by-space); include all new and existing-to-remain luminaires in WSEC interior lighting compliance reports; indicate proposed lighting wattage does not exceed maximum allowed per compliance path	
ECEPTACL	ES			
	C405.10	Controlled receptacles	Identify all controlled and uncontrolled receptacles on electrical plans in each space in which they are required; include receptacle configuration such as spacing between controlled and uncontrolled, duplex devices, etc	
			Provide schedule that lists the number of controlled and uncontrolled receptacles in each space where controlled receptacles are required - classrooms, private offices, open office areas, conference rooms, copy rooms, break rooms and modular partitions/workstations	
			Indicate on plans the method of automatic control for each controlled receptacle zone (occupant sensor or programmable time-of-day control); indicate that each zone served by a single controller does not exceed 5,000 sf	
	C405.2.5, Item 2	Switched receptacles in sleeping units	Indicate method of automatic off control of all switched receptacles in sleeping units (vacancy or key card control)	
	C503.6.6	Electrical receptacle alerations	Where new receptacles are added or replaced within an alteration project that is 5,000 sf or larger, indicate receptacles are provided with automatic controls per C405.10, or exception taken	



freeman

PRCTI20221702

PO BOX 19296 SEATTLE, WA 98109-1296 T 206.399.3071 E FREEMANF@FREEMANFONG.COM

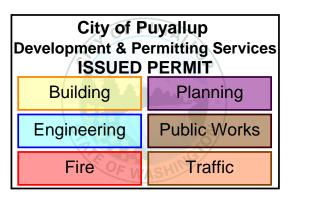TENANT
IMPROVEMENT

G

709 RIVER ROAD

PUYALLUP, WA 98371

TENANT:
JI HE CHEONG
6301 DISCOVERY ST E
FIFE, WA 98424
T 206.858.1020
EMAIL SEATTLE010600@YAHOO.COM

GENERAL CONTRACTOR

KEYSTONE NW INC 13510 N CREEK DRIVE, SUITE K207 MILL CREEK, WA 98012-2095

CONTACT: EUGENE KIM
T 425.879.6628
EMAIL EUGENEKIMKEYLAND@HOTMAIL.COM
CONTRACTOR LICENSE # KEYSTNR1826JC
UBI # 604-189-027

PERMIT SET



NO DATE REV

29 DEC 2022 COP CORR CYCLE #01

PROJECT NO 22032

DATE 23 SEPTEMBER 2022

DESIGN FF

2018 WSEC
COMMERCIAL
LIGHTING
REQUIREMENTS

DRAWN BY

CHECKED

A1.1

PRCTI20221702

Lighting, Motor and Electrical Requirements List, pg 9 of 10

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	C405.6	Electrical	Include electrical transformer schedule on	
	0.103.0	transformers	electrical plans; indicate transformer type, size, efficiency, or exception taken	
A	C405.11	Feeders and branch circuits	Provide documentation that demonstrates maximum voltage drop across feeders and branch circuits does not exceed 5%	
	C405.7	Dwelling unit electrical energy consumption	Indicate on electrical plans that each dwelling unit in Group R-2 has a separate electrical energy meter	
	C405.8	Electric motor efficiency	Include all motors, including fractional hp motors, in electric motor schedule on electrical plans; indicate motor type, horsepower, rpm, rated efficiency, or exception applied	
	C405.9.1	Elevator cabs	For luminaires in each elevator cab, provide calculations that demonstrate average efficacy is not less than 35 lumens per watt	
			For elevators that do not have an integral air conditioning system, indicate rated watts per cfm for elevator cab ventilation fans do not exceed 0.33 watts per cfm	
			Indicate automatic controls that de-energize lighting and ventilation fans when elevator is stopped and unoccupied for a period of 15 minutes or more	
	C405.9.2	Escalators and moving walks	Indicate escalators comply with ASME A17.1/CSA B44; automatic controls are configured to reduce operational speed to the minimum permitted when not in use	
	C405.9.3	Regenerative drive	Indicate all one-way down or reversible escalators are provided with a variable frequency regenerative drive	
OCUME	NTATION AND SY	STEM REQUIREMEN	NTS TO SUPPORT COMMISSIONING (CX)	
JA	C408.4	Scope of electrical power and lighting systems commissioning	Indicate that all electrical systems (receptacles, transformers, motors, vertical and horizontal transportation) for which the WSEC requires control functions and / or configuration to perform specific functions are required to be commissioned	
JA.			Where total building lighting load is > 20 kW, or where total lighting load of luminaires requiring daylight sensing and / or occupancy control > 10 kW, indicate that all automatic lighting control systems are required to be commissioned; or provide building lighting power calculation demonstrating eligibility for exception	
A	C405.13 C408.1.1 C408.1.2 C408.1.4.2 C103.6.3	Commissioning requirements in construction documents	Indicate Cx requirements in plans and specifications for all applicable electrical and lighting control systems per C408	

Page 9/10

Lighting, Motor and Electrical Requirements List, pg 10 of 10

2018 WSEC Requirements for Commercial Buildings including Group R2, R3 & R4 over 3 stories & all R1 -- Administered by ©2022 NEEA, All rights reserved

The following information is necessary to check a permit application for compliance with the lighting systems, motors and electrical system requirements in the

NA	C408.1.2 C408.1.2.1 C408.1.4 C103.6.3	Commissioning requirements in construction documents	Include general summary of Cx plan per C408.1.2 including: 1) Narrative description of activities; 2) Responsibilities of the Cx team; 3) Schedule of activities including verification of project close out documentation per C103.6; 4) Conflict of interest plan (if required)		
NA	C408.1.2 C408.1.4 C103.6.3	Commissioning requirements in construction documents	Include in general summary that a Cx project report and Compliance Checklist (Figure C408.1.4.1) shall be completed by the Certified Cx Professional and provided to the owner prior to the final electrical inspection		
NA	C408.4.1	Functional performance testing criteria	Identify in plans and specifications the intended operation of all equipment and controls during all modes of operation, including interfacing between new and existing-to-remain systems		
PROJECT (CLOSE OUT DOC	CUMENTATION		1	'
YES	C103.6.3	Project close out documentation requirements	Indicate in plans that project close out documentation is required including WSEC lighting compliance reports that document all interior and exterior lighting area and / or surface types, lighting power allowances and installed densities	A1.1, A1.2	
ren n	cted for any questic	on, provide explanation.			

 $12/23/22, 10:17 \ PM \\ https://waenergycodes.com/print_project_summary_form.php?k=Y29tYm9fdGZ2X3B0PWx0Z19zY29wZV9uZXdfaW50ZXJpb3IIN0NwZF9pbml0aWFsX3RlbmFudCZ0ZnY9bHRnX3Njb3BIX2...$

LIGHTING COM	PLIANCE	SUMMAR	RY								
2018 WSEC Compliance Forms	for Commercial	Buildings includin	g Group R2, R3	& R4 over 3 storie	s and all	R1			Administered by:	©2022 N	NEEA, All rights reserved
l t		Project Title		Tenant Impro	ovement	G CLIPS - 2018 WSE	C	For Building Departmen	Use:	Date	e: Dec 24, 2022
		Project Address		709 River R Puyallup, WA						Dute	. 500 21, 2022
Information		Applicant Name			Freem	nan Fong					
		Applicant Phone	;		206-3	99-3071					
		Applicant Email		freen	nanf@fr	reemanfong.com					
	For	questions about th	is report, conta	ct WSEC Commerc	ial Tech	nical Support at 360-53	39-5300 or vi	a email at com.techsuppo	rt@waenergycodes.com		
General Occupancy			All Commercia	ıl	Genera	nl Building Use Type		Services, Barber/B	auty Building Cond. Floor Area		1,453
				New Building or					Project Cond. Floor Area		1,453
General Project Types		Tenant Spaces –	First Build Out	, and the second		Interior Lighting Alteration Lighting Scop	one	Floors Above Grade		1	
				Lighting Scope			Lighting 50	оре	Compliance Method	Compl	iance Method 1 - General
Lighting Project Description				Tenant	Improve	ement for new G CLIP	S. New finish	es and paint. New sinks a	nd new washer and dryer.		
Lighting Compliance Scope	Projec	t Type		erior / Exterior les both interior & par	rking)	Luminaire Replacer	nent Scope	Compliance Method	LPA Calculation Adjustment	(Compliance Verification
and Method	Tenant Spaces -	- First Build Out	Int	erior Lighting				Space by space	No Calculation Adjustments selec	ted	COMPLIES
Additional Efficiency											

Project Title Tenant Improvement G CLIPS - 2018 WSEC Date D											
Lighting Power Calculation TENANT SPACES – FIRST BUILD OUT - INTERIOR LIGHTING Compliance Verific											
Compliance Method		Space by space	tment		none						
			Interior Lighting Power A	llowance - Space by Space	•						
General Space Type	Specific Space Type	Ceiling Height (Ft)	Gross Interior Area (SF)	LPA (Watts/SF)	Total Watts Allowed (SF x LPA x 1)	Total Proposed Watts (LPD + Display LPD)	Compliance Status				
Corridors	Service		115	0.41	47						
Lounge/breakroom	General		288	0.59	170						
Office	Enclosed less than 250 sf		168	0.74	124						
Office	Open plan		711	0.61	434						
Restroom	General		50	0.63	32						
Storage room	General		101	0.38	38						
		•		Proposed Total LPD		709					
	Total	s			845	709	COMPLIES				

	Proposed Lighting Power Density									
Fixture Type	Fixture ID	Quantity of Fixtures (#F)	Watts or Wattage Limit per Fixture (WpF)	Total Linear Feet (LF)	Watts per Linear Foot (WpLF)	Total Watts Proposed (#F x WpF) or (LF x WpLF)				
Individual Fixtures										
Horizontal surface-mount	В	1	5			5				
Troffer	A	5	32			160				
Troffer	A	12	32			384				
Troffer	A	2	32			64				
Troffer	A	1	32			32				
Troffer	A	1	32			32				
Walkmounted	\\\\\\\\\\\\\\\\\\\\\\\\\\\\\\\\\\\\\\		20	$ \\ \\ \\ \\ \\ \\ \\ \\ \\ \\ \\ \\ \\ \\ \\ \\ \\ \\ \\$		√ 20 √ 20				
Other fixture type	D	4	3			12				
					Proposed Total LPD	709				

Project Title		nent G CLIPS - 2018 WSEC		~	Date Dec 24, 2022			
roposed Fixtures I	Details	TENANT SPACES – FIRST BUILD O	UT - INTERIOR LIGHT	ING				
Fixture Type/Application	Fixture ID	Location in Documents	Lamp Type	New or Existing-to-Remain				
ndividual Fixtures								
Horizontal surface- mount	В	A2.0	LED		Existing			
	Fixture Description: Ex	ist. Surface Ceiling LED Fixture		Are the	se fixtures located within a daylight zone?: No			
	Do these fixtures requir	e specific application lighting controls?: None requi	ired					
Troffer	A	A2.0	T-8 Fluorescent		Existing			
	Fixture Description: Ex	ist. Recessed 2 x 4 Fluorescent Fixture		Are the	se fixtures located within a daylight zone?:			
	Do these fixtures requir	e specific application lighting controls?: None requi	ired					
Troffer	A	A2.0	T-8 Fluorescent		Existing			
	Fixture Description: Ex	ist. Recessed 2 x 4 Fluorescent Fixture		Are the	Are these fixtures located within a daylight zone?: Yes, controls provided			
	Daylight zone location(s): Sidelit daylight zones (primary and/or secondary	7)	Dimmi	ng method: Step dimming			
	Do these fixtures requir Section 1006.1	e specific application lighting controls?: Exit access	& egress lighting per IBC					
Troffer	A	A2.0	T-8 Fluorescent		Existing			
	Fixture Description: Ex	ist. 2 x 4 Fluorescent Fixture		Are these fixtures located within a daylight zone?: No				
	Do these fixtures requir	e specific application lighting controls?: None requi	red					
Troffer	A	A2.0	T-8 Fluorescent		Existing			
	Fixture Description: Ex	ist. Recessed 2 x 4 Fluorescent Fixture		Are these fixtures located within a daylight zone?: No				
	Do these fixtures requir	e specific application lighting controls?: None requi	red					
Troffer	A	A2.0	T-8 Fluorescent		Existing			
	Fixture Description: Ex	ist. Recessed 2 x 4 Fluorescent Fixture		Are the	se fixtures located within a daylight zone?: No			
	Do these fixtures requir	e specific application lighting controls?: None requi	red					
Wall-mounted	С	A2.0	LED		Existing			
	Fixture Description: Ex	ist. Wall Bath LED Fixture		Are the	se fixtures located within a daylight zone?: No			
	Do these fixtures requir	e specific application lighting controls?: None requi	ired					
Other fixture type	D	A2.0	LED		Existing			
	Fixture Description: Ex	ist. Exit Sign		Are the	se fixtures located within a daylight zone?: Yes, applying exception for controls			
	_	ls exception applied: Lighting requiring specific ap	plication controls		se fixtures require specific application lighting controls?: Exit access & egress lighting per IBC			



2018 IBO	C TABLE 403.3.1.1	MINIMUM VEN	TILATION RATES	
OCCUPANCY CLASSIFICATION	OCCUPANT DENSITY #/1000 FT ²	PEOPLE OUTDOOR AIRFLOW RATE IN BREATHING ZONE, R \rho CFM/PERSON	AREA OUTDOOR AIRFLOW RATE IN BREATHING ZONE, Ra CFM/FT ²	EXHAUST AIRFLOW RATE CFM/FT ²
BEAUTY SALONS	25	20	0.12	0.6
"G CLIPS" REQUIREMENTS	37	740 CFM	175 CFM	872 CFM

CALCULATIONS:

OCCUPANCY DENSITY = 1,453 SF / 1000 X 25 = 36.325 OR 37
PEOPLE OUTDOOR AIRFLOW RATE IN BREATHING ZONE = 20 X 37 = 740
AREA OUTDOOR AIRFLOW RATE IN BREATHING ZONE = 0.12 X 1,453 SF = 174.36 OR 175
EXHAUST AIRFLOW RATE = 0.6 X 1,453 SF = 871.8 OR 872

LANDLORD INDICATED THAT ALL TENANTS HAVE THEIR OWN AIR HANDLERS.

THEREFORE, MINIMUM VENTILATION RATE STANDARD SHOULD SUPPLY AND EXHAUST 872 CFM FOR BALANCE FOR G CLIPS.

freeman architects

PRCTI20221702

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TENANT
IMPROVEMENT

CLIPS

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GENERAL CONTRACTOR

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CONTRACTOR LICENSE # KEYSTNR1826JC
UBI # 604-189-027

PERMIT SET



	ISSUE/REVISIONS						
NO	DATE	REV					
1	29 DEC 2022	COP CORR CYCLE #01					
PROJECT N	10	2203					
DATE		23 SEPTEMBER 202					

2018 WSEC
COMMERCIAL LIGHTING
REQUIREMENTS &
LIGHTING SUMMARY;

DESIGN

DRAWN BY

A12

> 2018 IBC TABLE 4.3.3.1.1

PRCTI20221702

Building


Engineering

City of Puyallup
Development & Permitting Services
ISSUED PERMIT

Planning

Public Works

Traffic

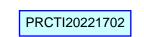



IMPROVEMENT

TENANT

PUYALLUP, WA 98371

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PERMIT SET



ISSUE/REVISIONS NO DATE REV

9 DEC 2022 COP CORR CYCLE #01

PROJECT NO 22032 DATE 23 SEPTEMBER 2022

DESIGN DRAWN BY

CHECKED

Development & Permitting Services

Planning

Public Works


Traffic


ISSUED PERMIT

Engineering

PRCTI20221702

MAIN FLOOR & MAIN FLOOR REFLECTED **CEILING PLANS**; SCHEDULES

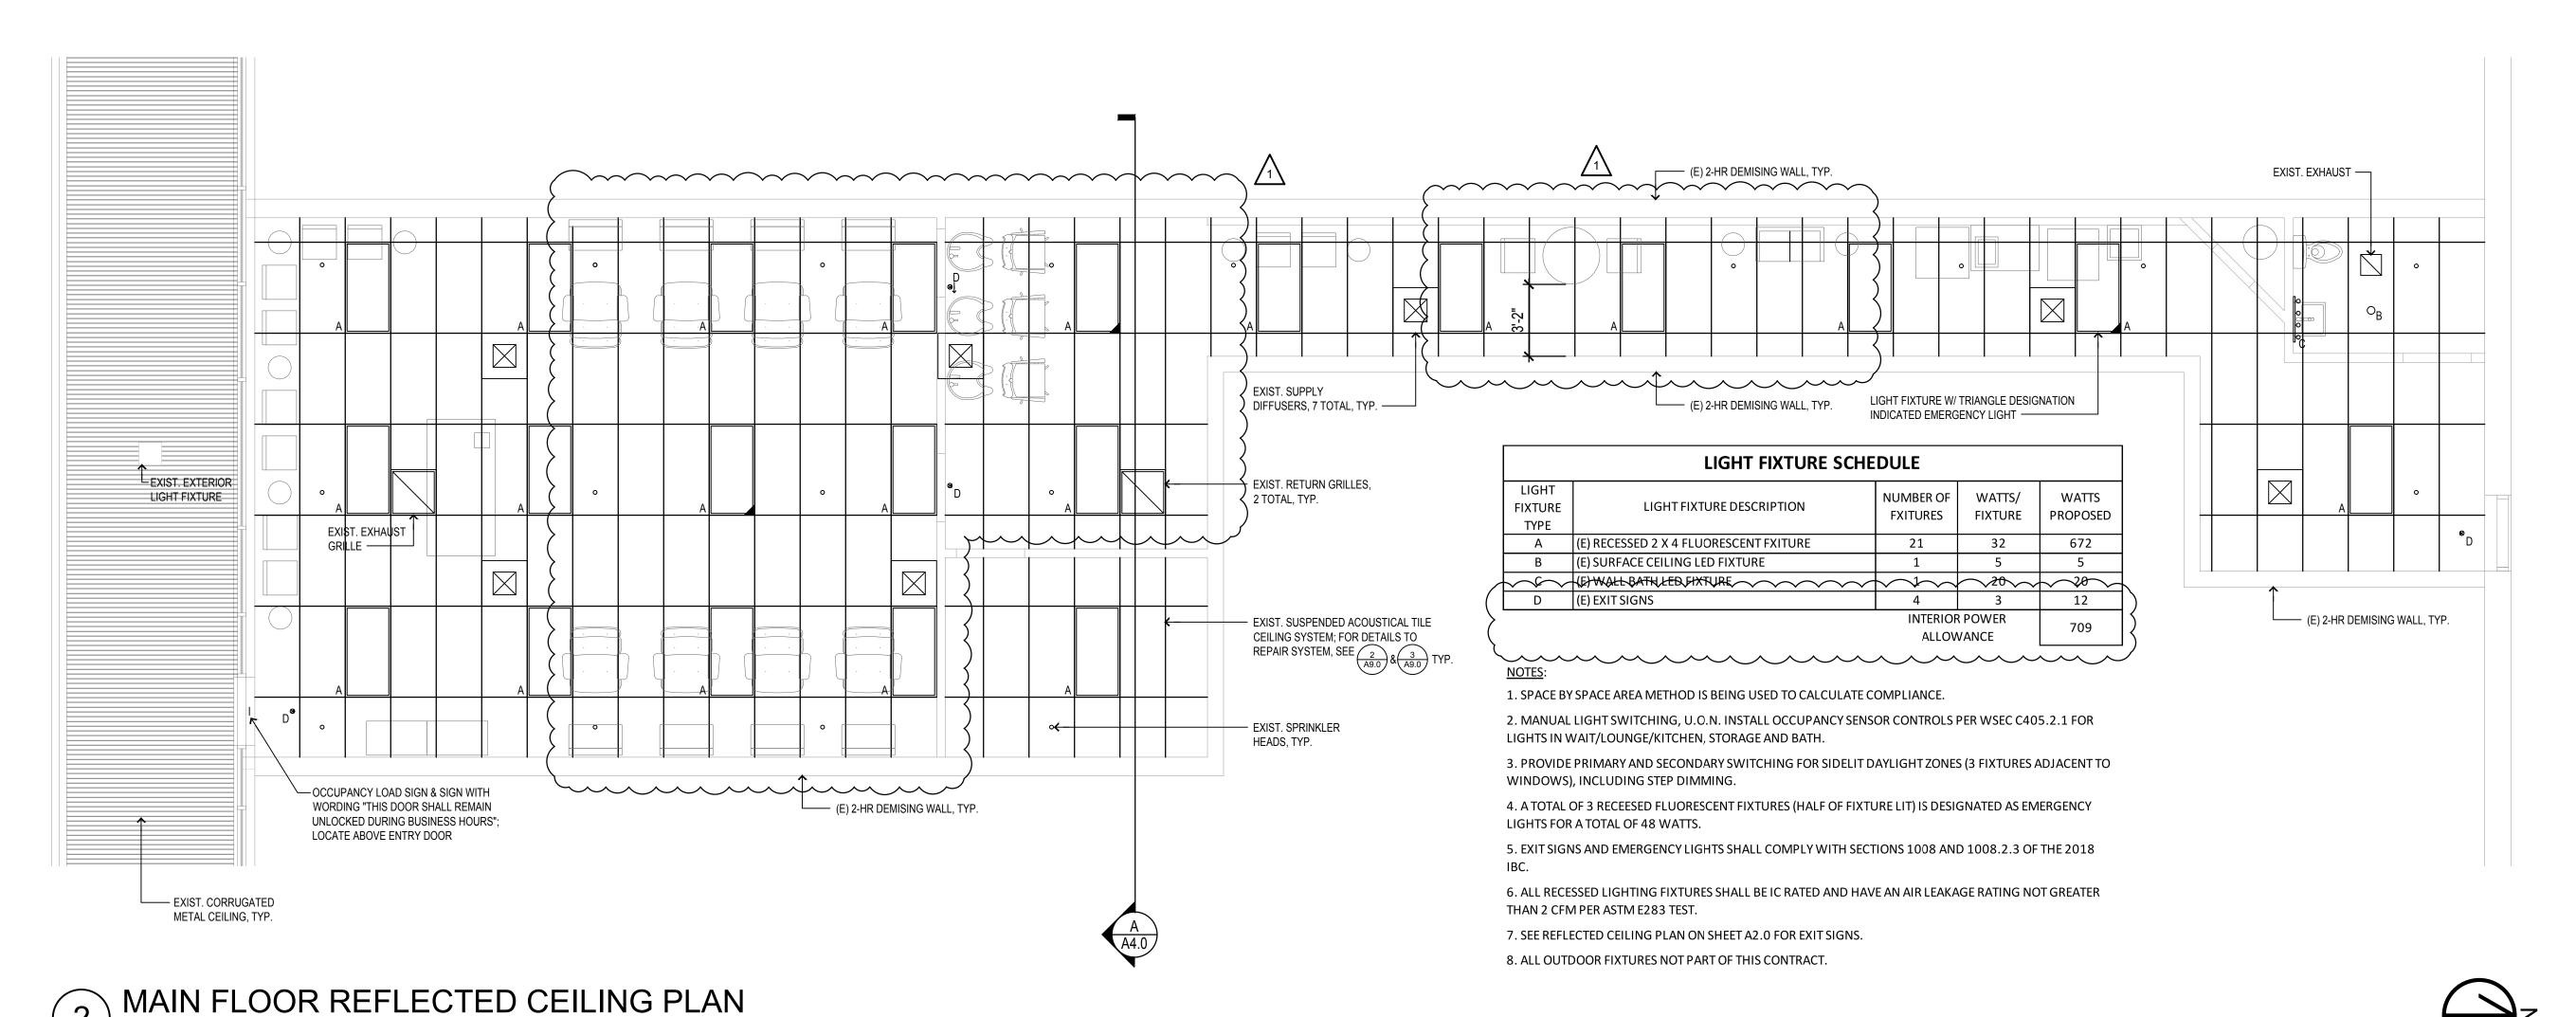

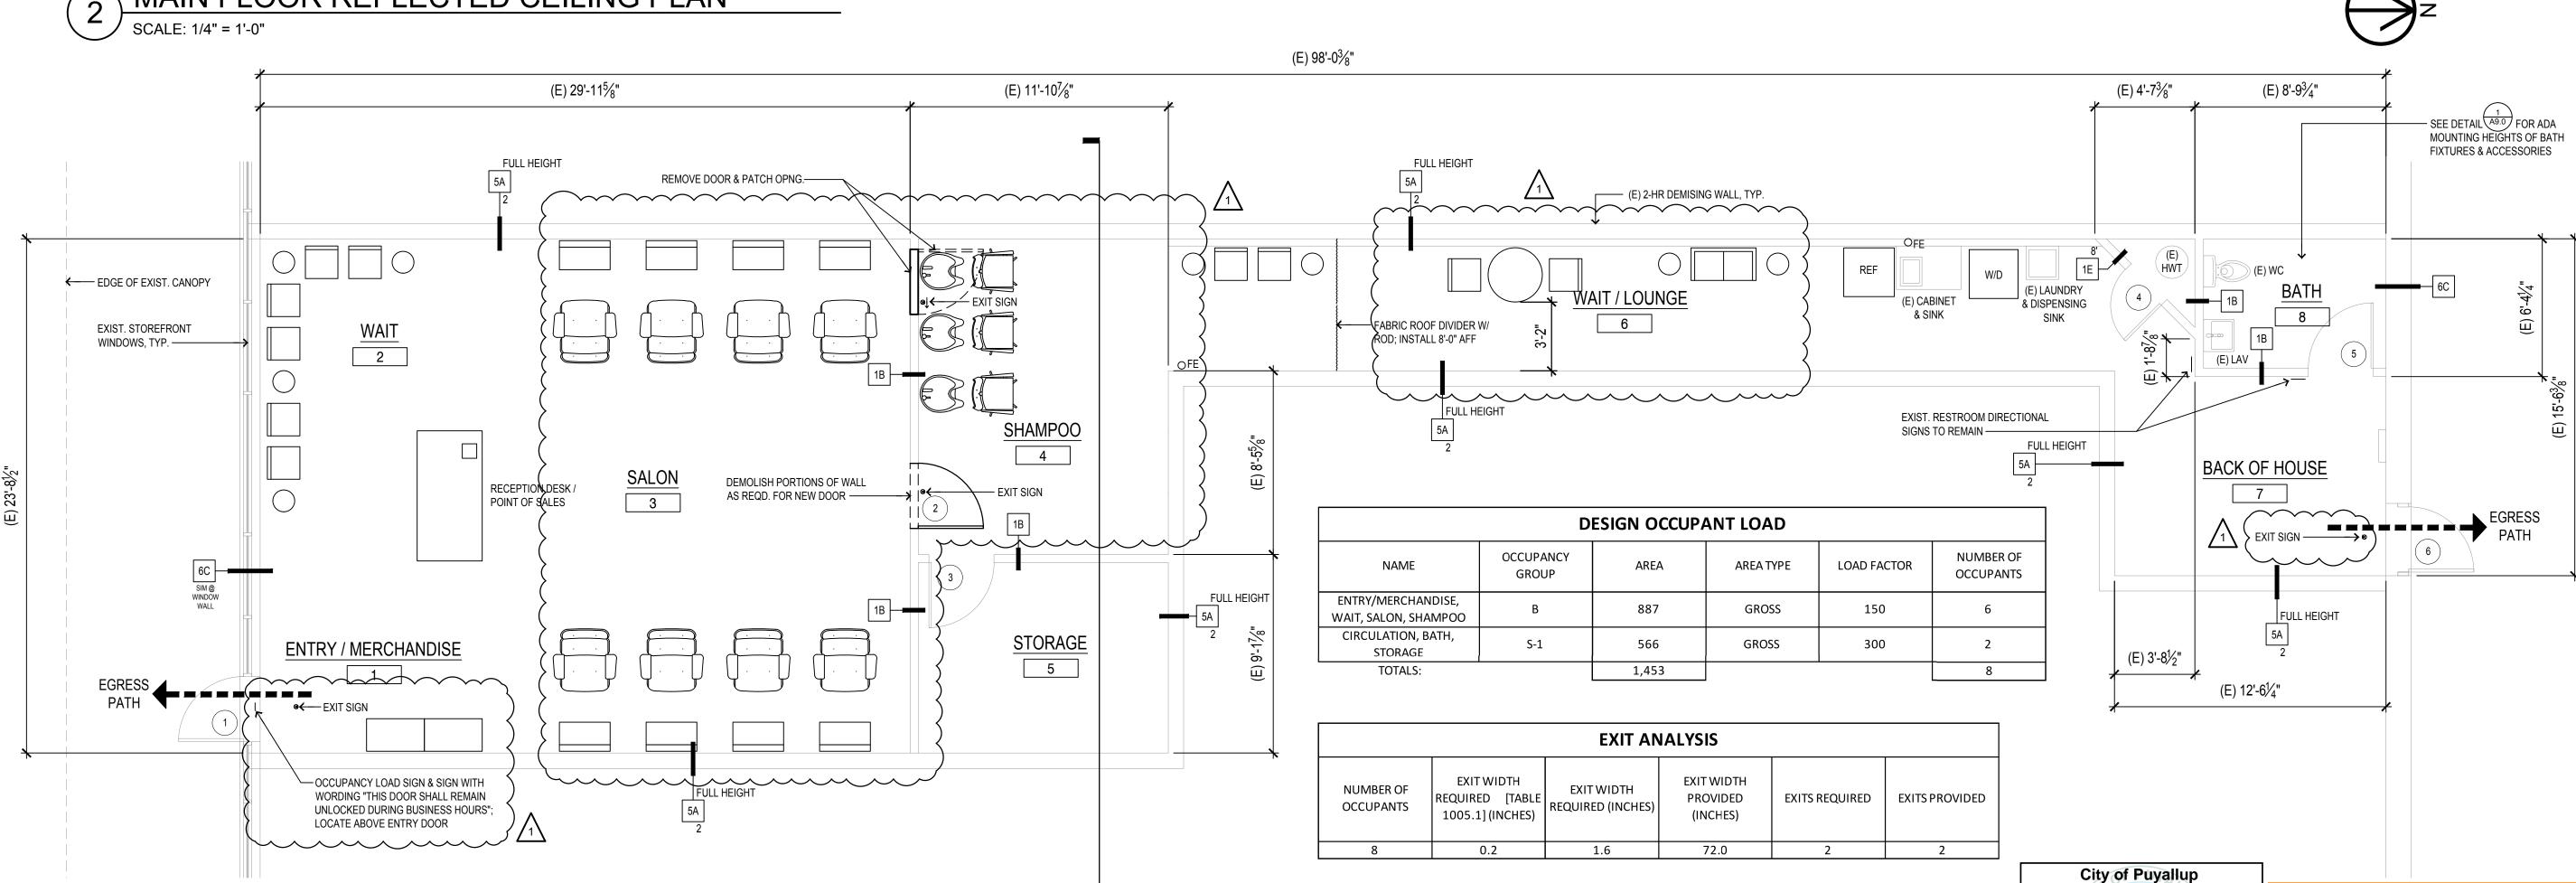

EXIT DOOR KEY

EGRESS WIDTH

(INCHES)

0.80

0.80

OCCUPANCY

SERVED

B, S-1

B, S-1

EXIT NUMBER

MAIN FLOOR PLAN

SCALE: 1/4" = 1'-0"

WIDTH PROVIDED

(INCHES)

72

EXIT CAPACITY

360

180



TENANT IMPROVEMENT

CLIPS

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PROJECT NO 22032

DATE 23 SEPTEMBER 2022

DESIGN

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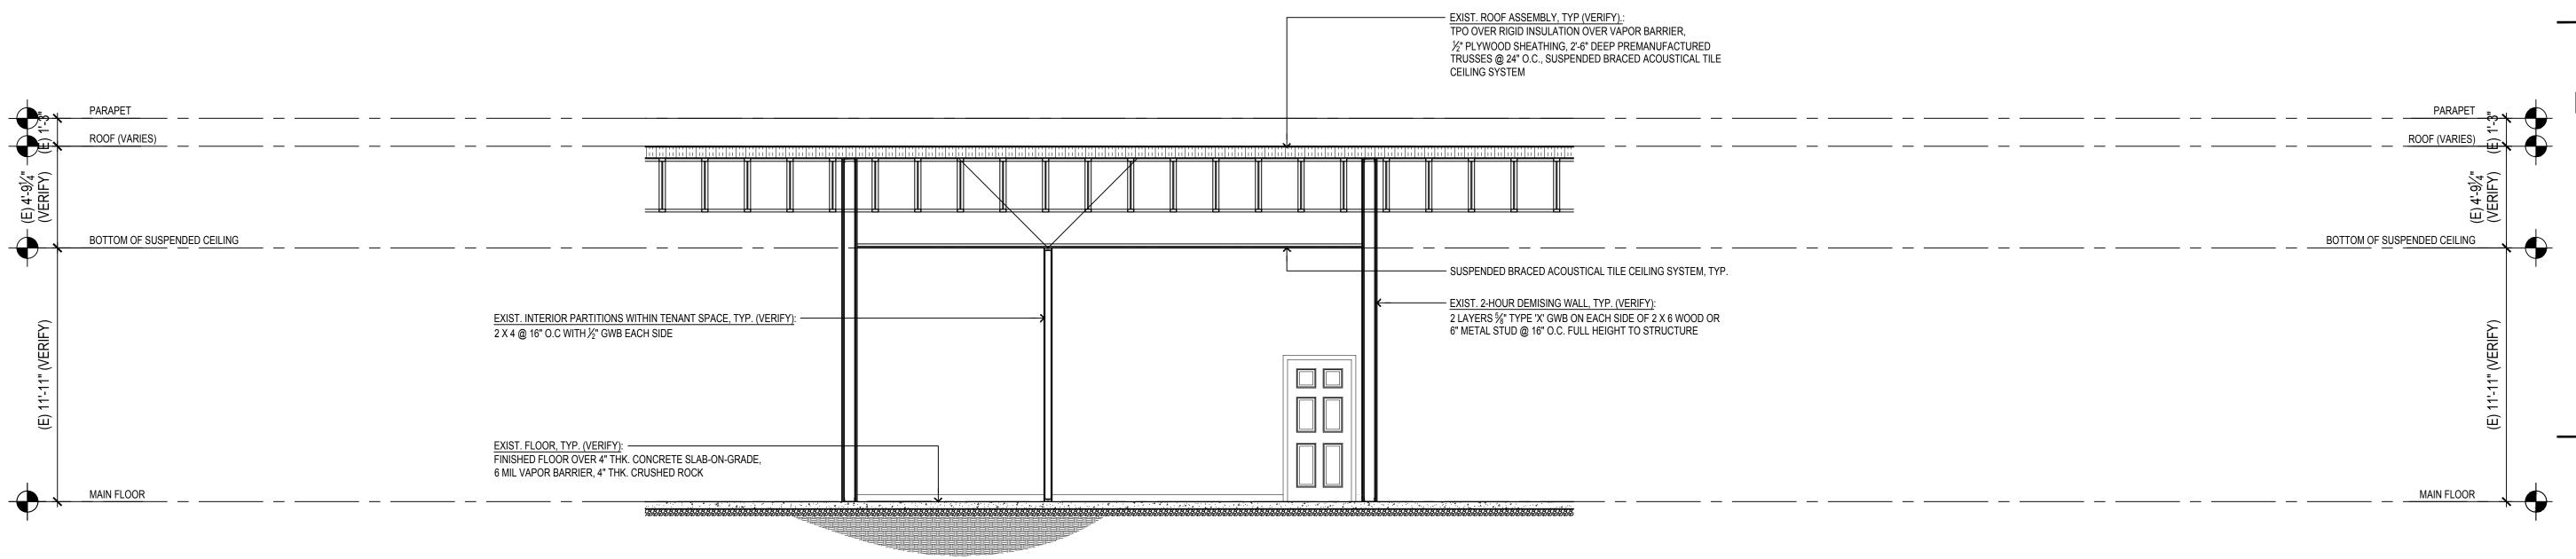
SHEET TITLE
BUILDING

City of Puyallup
Development & Permitting Services
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Building Planning
Engineering Public Works
Fire Traffic

A4.0


SECTION

PRCTI20221702




A BUILDING SECTION LOOKING SOUTH

SCALE: 1/4" = 1'-0"

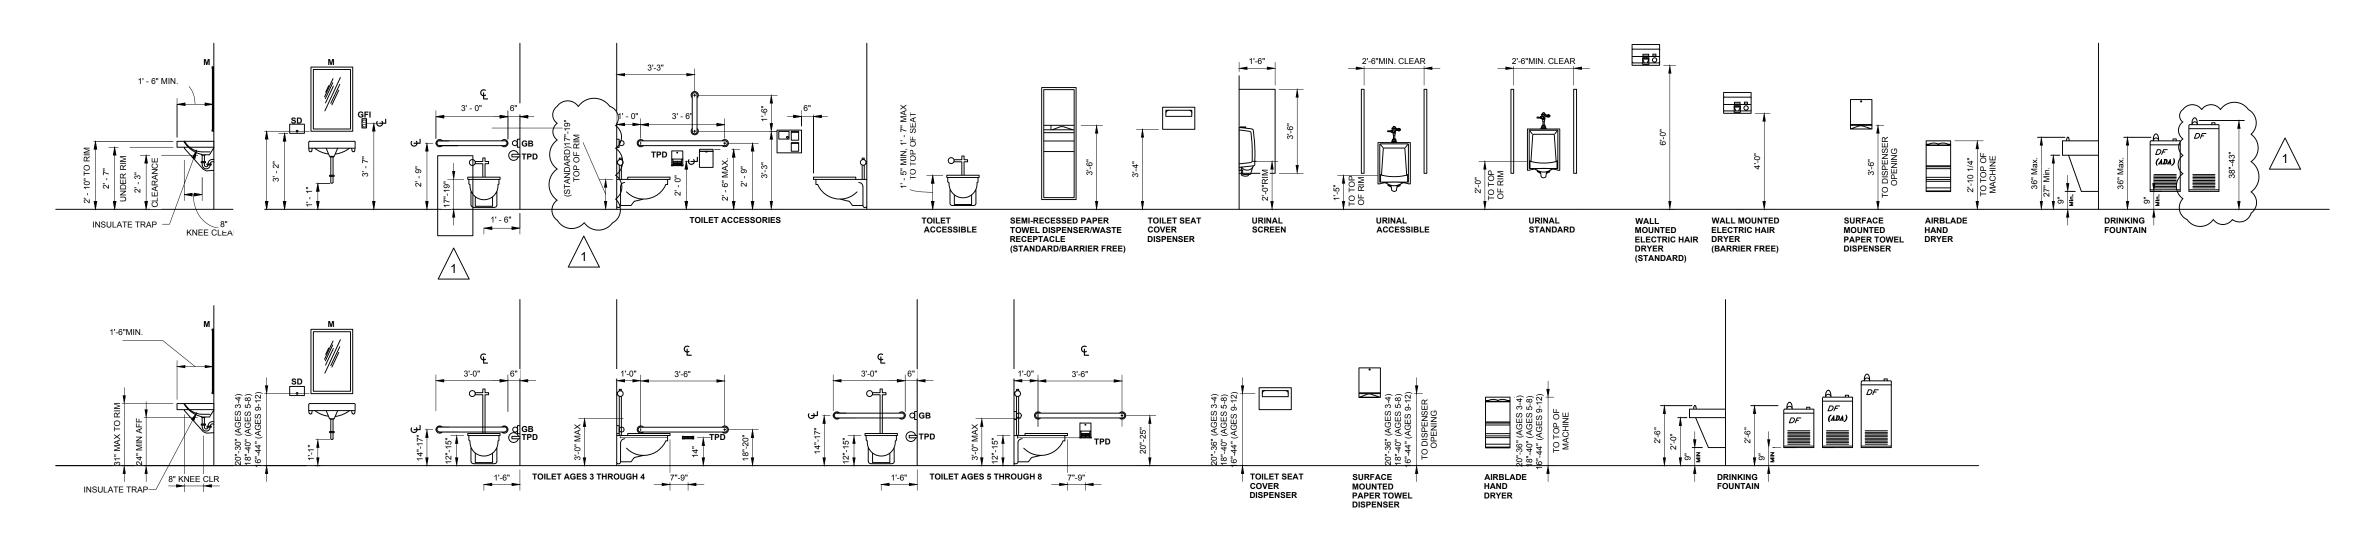


1 BATHROOM FIXTURES & ACCESSORIES MOUNTING HEIGHTS SCALE: 1/4" = 1'-0"

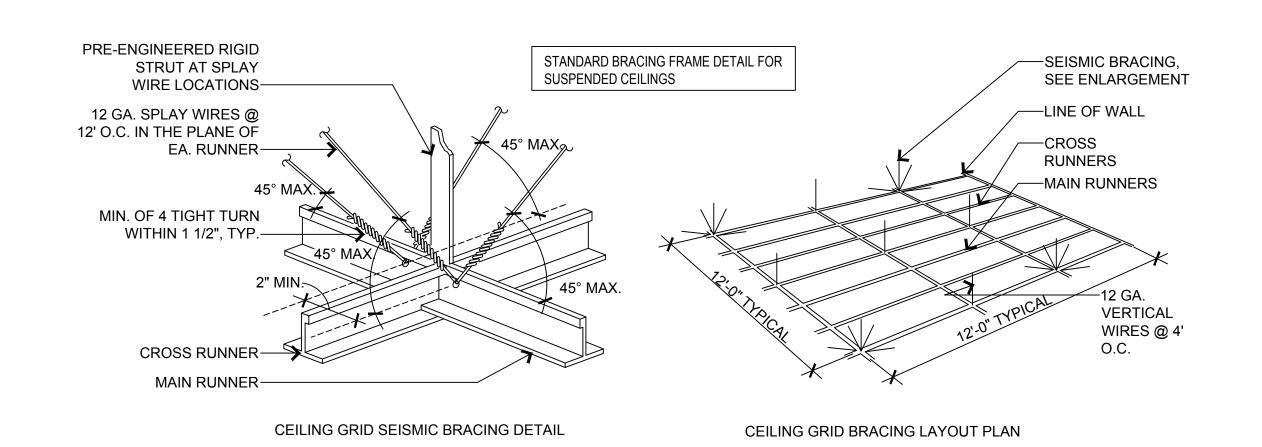


PLUMBING FIXTURE COUNT								
CLASS	OCCUPANCY	NUMBER OF OCCUPANTS IN CLASS	(URINALS	CLOSET 5, SEE SEC. 2.1)		AVS C. 422.1)	DRINKING FOUNTAIN (SEE SEC. 422.1 & IBC 2902.5.1.	SERVICE SINK (SEE SEC. 422.1)
			MALE	FEMALE	MALE	FEMALE	Exception 2)	
ENTRY/MERCHANDI SE, WAIT, SALON, SHAMPOO	В	6	0.06	0.12	0.00	0.03	0.02	1.00
CIRCULATION, BATHS & STORAGE	S-1	2	0.01	0.01	0.00	0.01	0.01	0.00
TOTAL REQUIRED:		0.20		0.03		0.03	1.00	
TOTAL PROVIDED:			1		1		0	1

2 SUSPENDED ACOUSTICAL FRAME BRACING, TYP. SCALE: 1 1/2" = 1'-0"

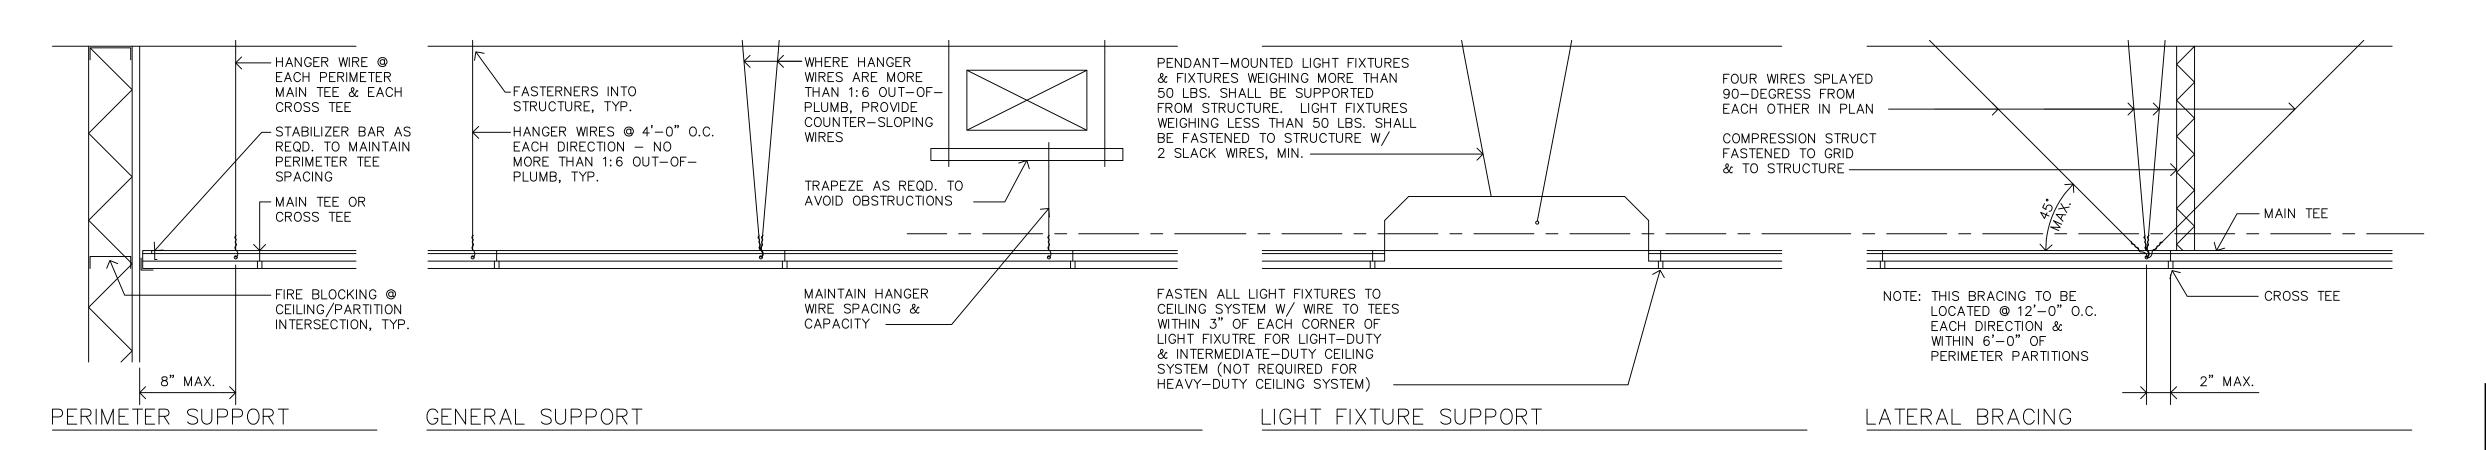

3 INSTALLATION OF SUSPENDED CEILING SYSTEMS, TYP. A SCALE: 1 1/2" = 1'-0"

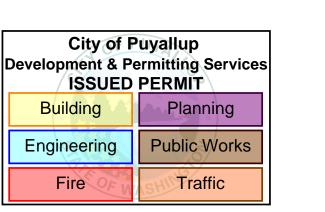

PRCTI20221702

freeman architects

PRCTI20221702

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IMPROVEMENT G

TENANT

CLIPS

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PROJECT N	0	22032
DATE		23 SEPTEMBER 2022
DESIGN		FF
DRAWN BY		FF
CHECKED		FF

BATHROOM FIXTURES &
ACCESSORIES MOUNTING
HEIGHTS; SUSPENDED
CEILING DETAILS; PLUMBING
FIXTURE COUNT

SHEET TITLE

A90



IMPROVEMENT

TENANT

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PROJECT NO 22032 DATE 23 SEPTEMBER 2022 DESIGN

FF

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SHEET TITLE

PARTITION TYPES

A9.1



PROVIDE WATER-RESISTANT GYPSUM BOARD, IN LIEU OF GYPSUM BOARD AS SHOWN, @ "WET" AREAS AS DESCRIBED UNDER THE SPECIFICATIONS.

PROVIDE BACKER BOARD, IN LIEU OF GYPSUM BOARD AS SHOWN, @ CERAMIC TILE AREAS AS DESCRIBED WITHIN THE DRAWINGS AND SPECIFICATIONS.

01. STUD SPACING 16" O.C. UNLESS OTHERWISE NOTED WITH A INTERIOR MODIFIER.

AS REQUIRED FOR THE TESTED ASSEMBLY.

03. FIRE-RATED SEALANT IS REQUIRED @ FIRE-RATED PARTITIONS WHERE PARTITION JAMB CONDITIONS INTERFACE W/ DISSIMILAR MATERIALS OR WHERE FIRE TAPING @

PARTITION TYPE - GENERAL NOTES

02. FIRE RATED SEALANT IS REQUIRED @ HEAD OF PARTITION OF FIRE-RATED WALLS

INTERFACE OF MATERIALS IS NOT PRACTICAL

PARTITION CONFIGURATIONS

-NO SCALE-

FULL HEIGHT STUDS TO

PARTITION

____ SCALE: 1-1/2" = 1'-0"

FULL HEIGHT GWB EACH SIDE

STRUCTURE


UNDERSIDE OF

CEILING WHERE

SHOWN

FLOOR LINE

STRUCTURE

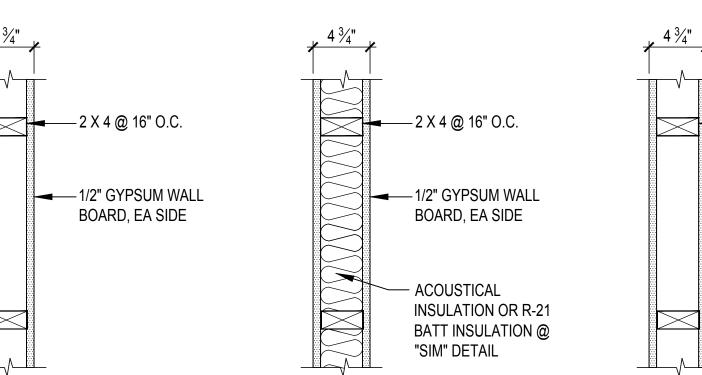

2 | PARTITION | SCALE: 1-1/2" = 1'-0"

— 2 X 4 @ 16" O.C. 5/8" TYPE "X" **GYPSUM WALL** BOARD, EA SIDE

EXISTING OR NEW WALL FULL

HEIGHT TO STRUCTURE

UNDERSIDE OF

CEILING WHERE

- SPLAY WIRES,SEE

1 2

A5.0 A5.0

SHOWN


FLOOR LINE

STUDS TO SUSPENDED CEILING,

GWB TO SUSPENDED CEILING

EACH SIDE

STRUCTURE

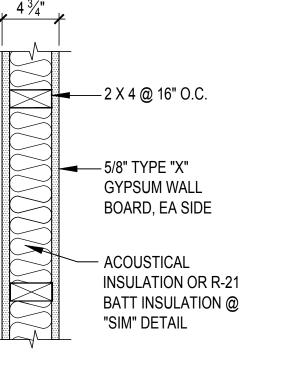

UNDERSIDE OF

STRUCTURE


CEILING WHERE

SHOWN

9'-0" AFF

_ FLOOR LINE

SOFFIT WALL TO STRUCTURE

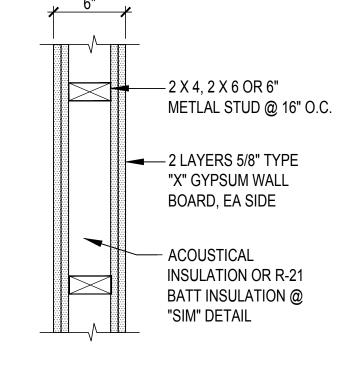


UNDERSIDE OF

STRUCTURE

FLOOR LINE

PARTIAL HEIGHT PARTITION

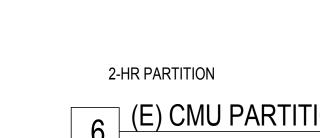



— 2 X 4 @ 16" O.C.

── 5/8" TYPE "X" GYPSUM

SHEATHING (VERIFY)

_ WALL BOARD

– WOOD SIDING

-----1⁄2" PLYWOOD

UNDERSIDE OF


STRUCTURE

_ _ BOTTOM OF

RAFTER

_ FLOOR LINE


1-HR PARTITION: GA FILE NO. WP 3615 SCALE: 1-1/2" = 1'-0"

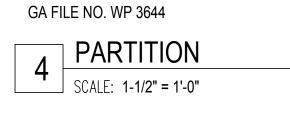


1-HR PARTITION:





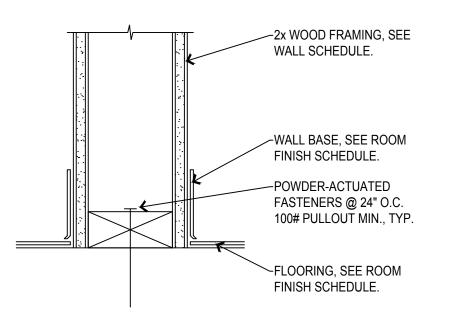




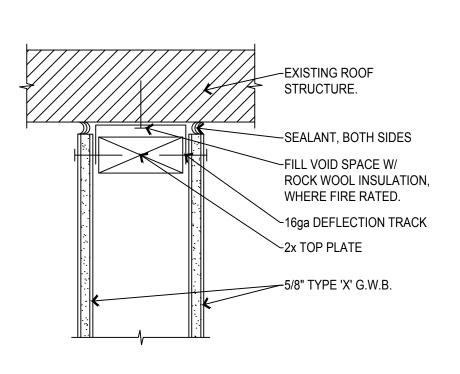


SLIP TRACK DETAIL SCALE: 3"=1'-0"

City of Puyallup **Development & Permitting Services ISSUED PERMIT** Building Planning **Public Works** Engineering Traffic

PRCTI20221702

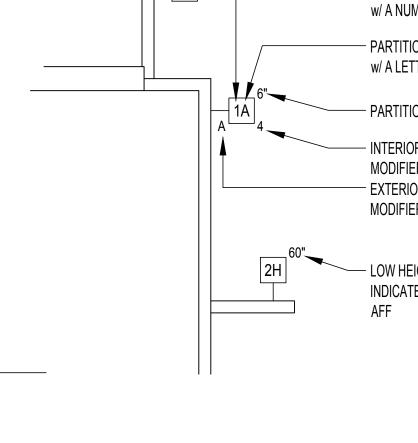

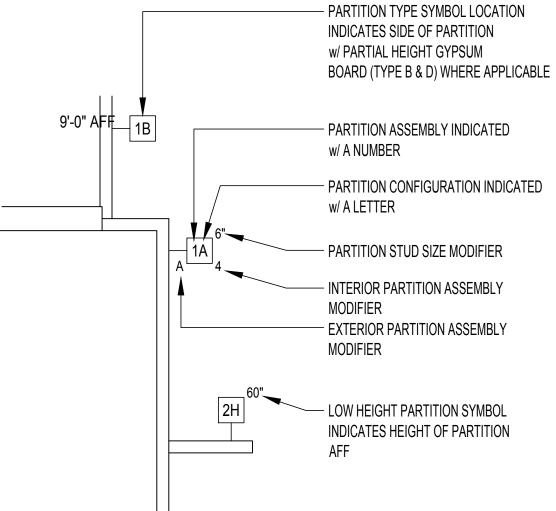

EXIST. 8" CMU, FILLED

BLEND OF GRAVEL &

WITH STD. 60/40

AGRGREGATES

PUMICE

(VERIFY)

2HR PARTITION: GA FILE NO. WP 4136 SCALE: 1-1/2" = 1'-0"

6 (E) CMU PARTITION SCALE: 1-1/2" = 1'-0"

	ROOM FINISH SCHEDULE										
ROOM NO.	ROOM NAME	FLC	OR	BA	SE	WA	LLS		CEILING		REMARKS
NOOWING.	ROOMINAME	MAT'L	FINISH	MAT'L	FINISH	MAT'L	FINISH	MAT'L	FINISH	HEIGHT	HEIMHING
1	ENTRY/MERCHANDISE	SLVT	FAC	R	FAC	GWB	PT	SACT	FAC	(E) 11'-11"	
2	WAIT	SLVT	FAC	R	FAC	GWB	PT	SACT	FAC	(E) 11'-11"	
3	SALON	SLVT	FAC	R	FAC	GWB	PT	SACT	FAC	(E) 11'-11"	
4	SHAMPOO	SLVT	FAC	R	FAC	GWB	PT	SACT	FAC	(E) 11'-11"	
5	STORAGE	(E) VT	FAC	R	FAC	WD	PT	SACT	FAC	(E) 11'-11"	
6	WAIT/LOUNGE 1	(E) VCT	FAC	R	FAC	GWB	PT	SACT	FAC	(E) 11'-11"	
7	BACK OF HOUSE	(E) VCT	FAC	R	FAC	GWB	PT	SACT	FAC	(E) 11'-11"	
8	ВАТН	(E) VCT	FAC	R	FAC	GWB	PT	SACT	FAC	(E) 11'-11"	

ABBREVIATIONS	

FACTORY FAC GWB GYPSUM WALLBOARD HDWD HARDWOOD

MAT'L MATERIAL PAINT

RUBBER SACT SUSPENDED ACOUSTICAL TILE CEILING STRIP LUXURY VINYL TILE

SLVT VINYL COMPOSITION TILE VCT

VINYL TILE

DOOR SCHEDULE									
	ODENING SIZE	DOOR			FIRE	LI EACTOR	AREA	DEMANUS	
DOOK NOIVIBER	DOOR NUMBER OPENING SIZE DOOR DOOR GLASS (HR) U-FAC	U-FACTOR	(SF)	REMARKS					
1	(E) 3'-0" X 7'-0"	А	AL/GL	TEMP		035	21.00	~~~~^	
2	(E) 3'-6" X 6'-8"	В	WD				}	RELOCATE TO NEW LOCATION 1	
3	(E) 3'-0" X 6'-8"	В	WD						
4	(E) 2'-4" X 6'-8"	В	WD						
5	(E) 3'-0" X 6'-8"	В	WD						
6	(E) 3'-0" X 7'-0"	С	WD			0.35	64.00		
	TOTAL 85.00								


NOTES:
1. VERIFY OPERATION OF DOORS WITH PLANS.


WOOD


2. INSULATE ALL DOOR HEADERS WITH A MINIMUM OF R-10 BATT INSULATION. 3. WHERE NOT DIMENSIONED ON DRAWINGS, LOCATE DOORS CENTERED IN THE ROOM OR 4" FROM CORNER OR CABINET.

ALUMINUM GLASS MAT'L MATERIAL SQUARE FEET TEMP TEMPERED OR SAFETY WD

DOOR TYPES:

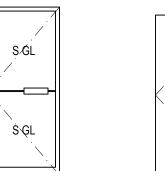

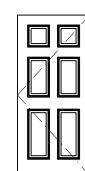

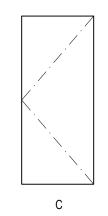

PRCTI20221702

PO BOX 19296 SEATTLE, WA 98109-1296 T 206.399.3071 E FREEMANF@FREEMANFONG.COM

TENANT IMPROVEMENT

709 RIVER ROAD PUYALLUP, WA 98371


TENANT: JI HE CHEONG 6301 DISCOVERY ST E FIFE, WA 98424 T 206.858.1020 EMAIL SEATTLE010600@YAHOO.COM

GENERAL CONTRACTOR

KEYSTONE NW INC 13510 N CREEK DRIVE, SUITE K207 MILL CREEK, WA 98012-2095

CONTACT: EUGENE KIM T 425.879.6628 EMAIL EUGENEKIMKEYLAND@HOTMAIL.COM CONTRACTOR LICENSE # KEYSTNR1826JC UBI # 604-189-027

PERMIT SET

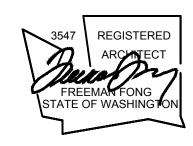

	ISSUE/RE	EVISIONS
NO	DATE	REV
1	29 DEC 2022	COP CORR CYCLE #01
PROJECT N	0	2203

DATE

DESIGN

DRAWN BY

CHECKED

SHEET TITLE


23 SEPTEMBER 2022

ROOM FINISH & DOOR SCHEDULES


A10.0

City of Puyallup
Development & Permitting Services
ISSUED PERMIT Planning Building Public Works Engineering Traffic

PRCTI20221702

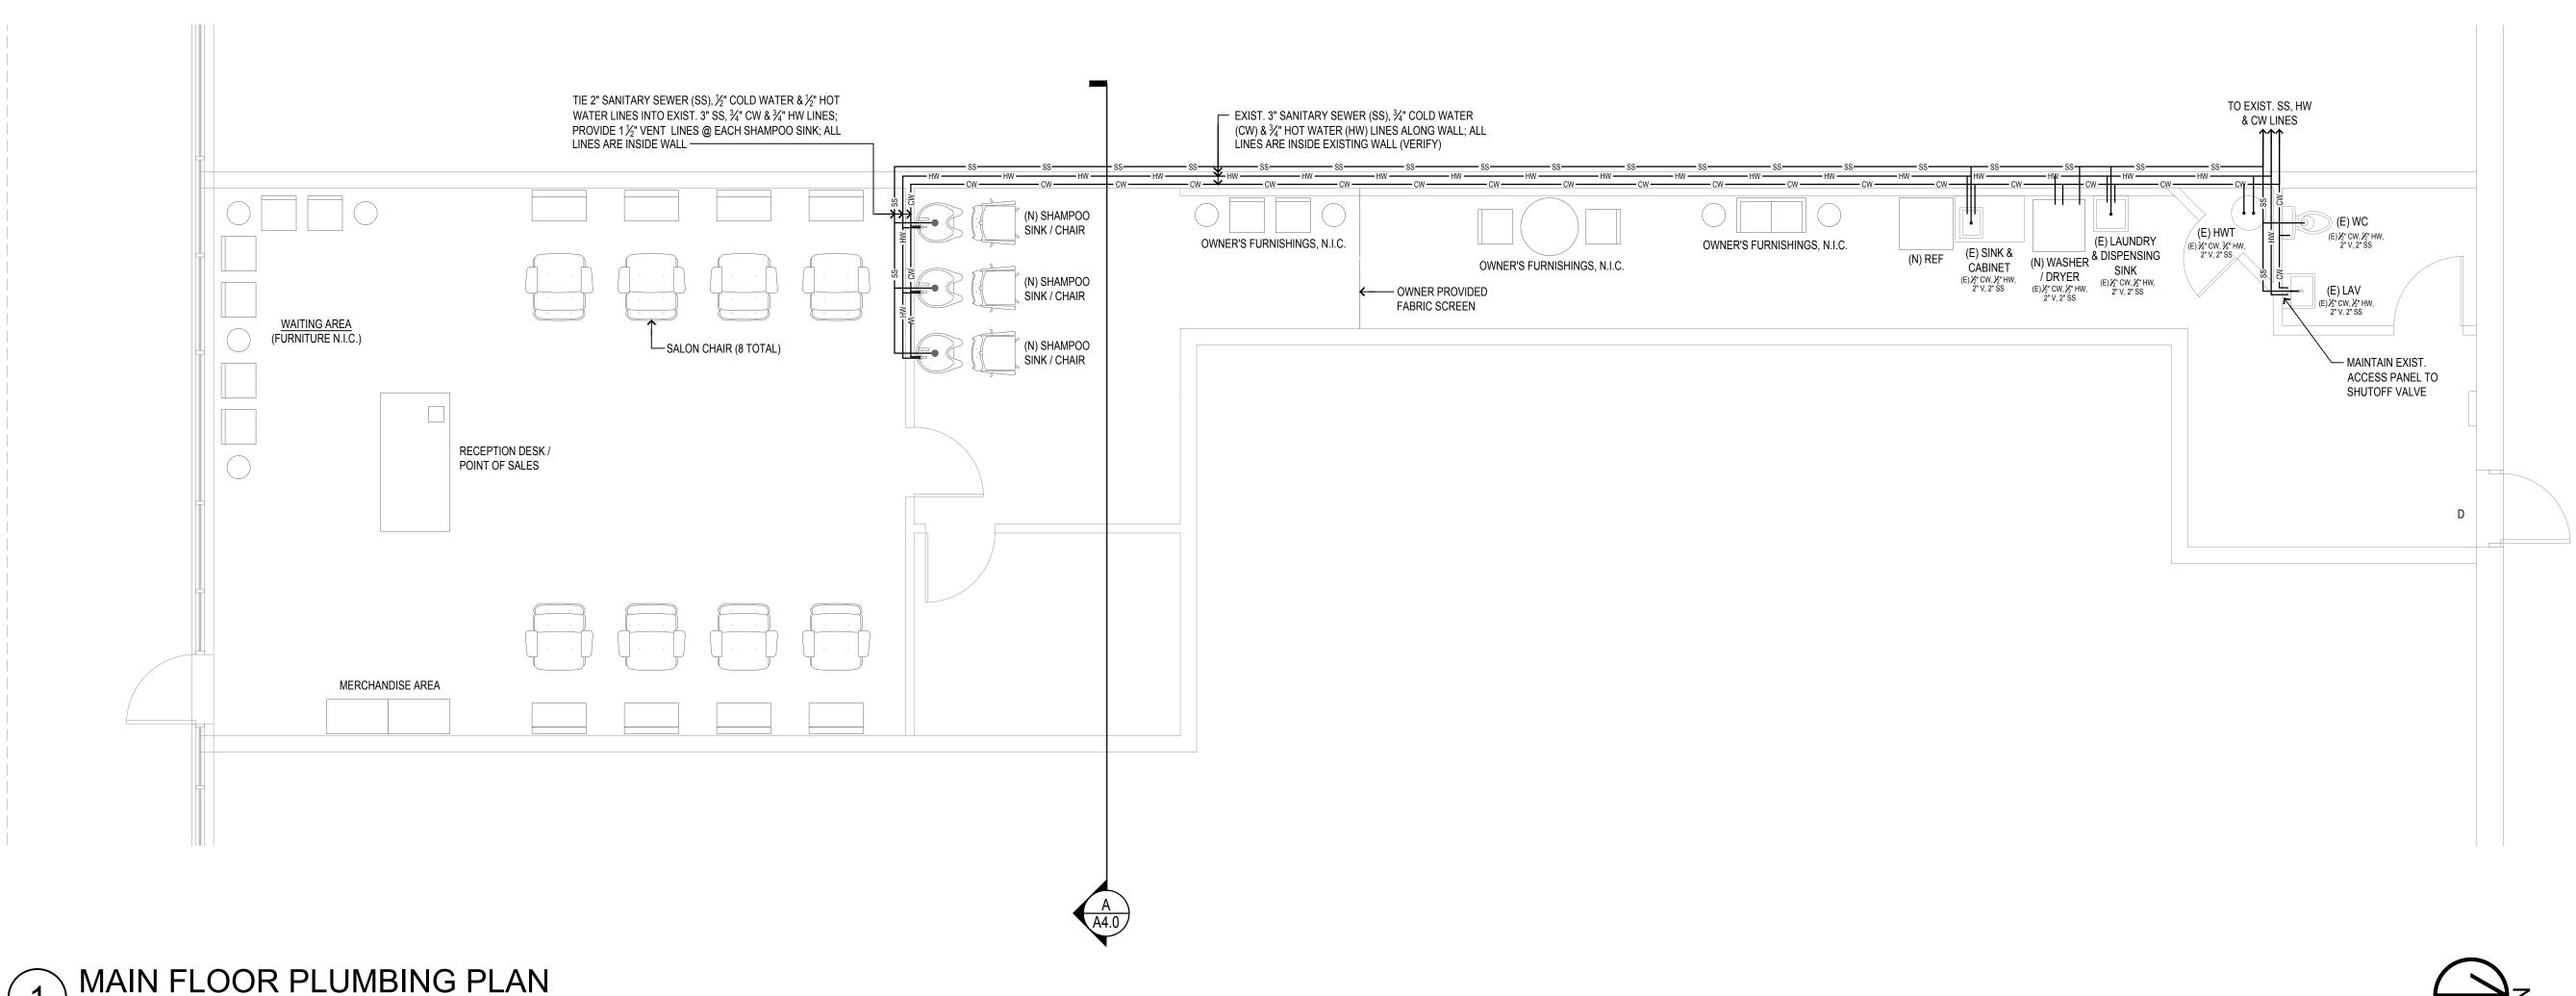

SCALE: 1/4" = 1'-0"

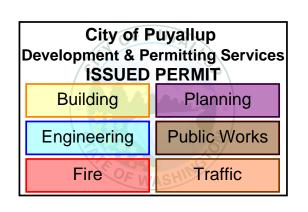

PRCTI20221702



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PO BOX 19296 SEATTLE, WA 98109-1296 T 206.399.3071 E FREEMANF@FREEMANFONG.COM

TENANT
IMPROVEMENT

G

CLIPS

709 RIVER ROAD PUYALLUP, WA 98371

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FIFE, WA 98424
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ISSUE/REVISIONS

'	NO	DATE	REV
	1	29 DEC 2022	COP CORR CYCLE #01
	PROJECT N	0	2203
·	DATE		23 SEPTEMBER 202
·	DESIGN		F
•	DRAWN BY		F

MAIN FLOOR
PLUMBING PLAN

CHECKED

P2.0