A 236-Unit Apartment Development Puyallup, Washington

Timberlane Partners

LIST OF DRAWINGS

- Cover Sheet
- Building A Building Floor Plans
- Building A Building Floor Plans
- Building B Building Floor Plans
- Buildings C & G Building Floor Plans
- Building D Building Floor Plans
- A10 Buildings E & F Building Floor Plans A11 Buildings E & F - Building Floor Plans
- A12 Building H Building Floor Plans
- A13 Trash & Recycling Enclosures Elevations
- A14 High Quality Material Calculations
- A15 Materials and Color Scheme Legend
- A16 Ground Level Transparency Calculations
- Building A Elevations and Perspectives
- Building B Elevations and Perspectives
- Building C Elevations and Perspectives Building C - Elevations and Perspectives
- Building D Elevations and Perspectives
- Building D Elevations and Perspectives Building E - Elevations and Perspectives
- Building F Elevations and Perspectives
- Building G Elevations and Perspectives
- P10 Building G Elevations and Perspectives Building H - Elevations and Perspectives
- P13 Clubhouse Elevations and Perspectives







Bradley Heights Apartments

Timberlane Partners

Cover Sheet

3/28/2023 APT/HDM Drawn By: 2306








PARKING:

SITE ADDRESS: 202 27th Ave SE, Puyallup, WA PARCEL #: 419036006 SITE AREA: 339,107 SF (7.785 Acres) ZONE: RM-CORE MIN SETBACKS: Front: 10' Rear: 0' Interior: 0' 50' Max **BUILDING HEIGHT:** DENSITY: Min 16 units per acre (125 units) no Max density LOT COVERAGE: Max 90% LANDSCAPE AREA: Min 10% of net lot area (33,910 SF) 10% of net lot area (33,910 SF) OPEN SPACE: 38,500 SF provided PRIVATE OPEN SPACE: 60 SF per ground floor unit 10' x 6' per upper story unit

PARKING SUMMARY		
Parking Stalls Required	354	,
Standard Stalls	199	
Compact Stalls	143	41.5%
Parallel Stalls	0	
Carport Stalls	0	
Attached Garage Stalls	0	
Detached Garage Stalls	0	
Accessible Standard Stalls	12	
Accessible Van Stalls	0	
Accessible Parallel Stalls	0	
Accessible Carport Stalls	0	
Accessible Garage Stalls	0	
Tandem Stalls	0	
Tandem Garage Stalls	0	
Subtotal	354	1.50 Stalls / D.U.
Aprons	0	
Total Parking Stalls Provided	354	1.50 Stalls / D.U.


JMMARY		
41.5%		

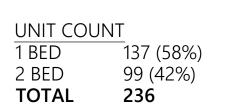

OPEN SPACE __9,000 SF 4,500 SF 25,000 SF 38,500 SF

EASEMENTS There are no existing easements on site

SETBACKS NORTH/FRONT: 10 FT setback to buildings
WEST/SIDE: 0 FT Building setback - 6 FT landscape buffer
SOUTH/REAR: 0 FT Building setback - 6 FT landscape buffer
EAST/SIDE: 25 FT Building setback - 15 ft landscape buffer

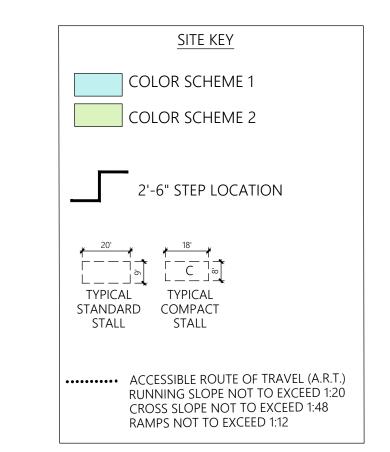



1.5 PARKING SPACES PER UNIT

ARCHITECTS

Bradley Heights Apartments


Timberlane Partners

Site Plan

236 UNITS

	Date:	3/31/202
,	Drawn By:	APT/HDN
,	Job No.:	230



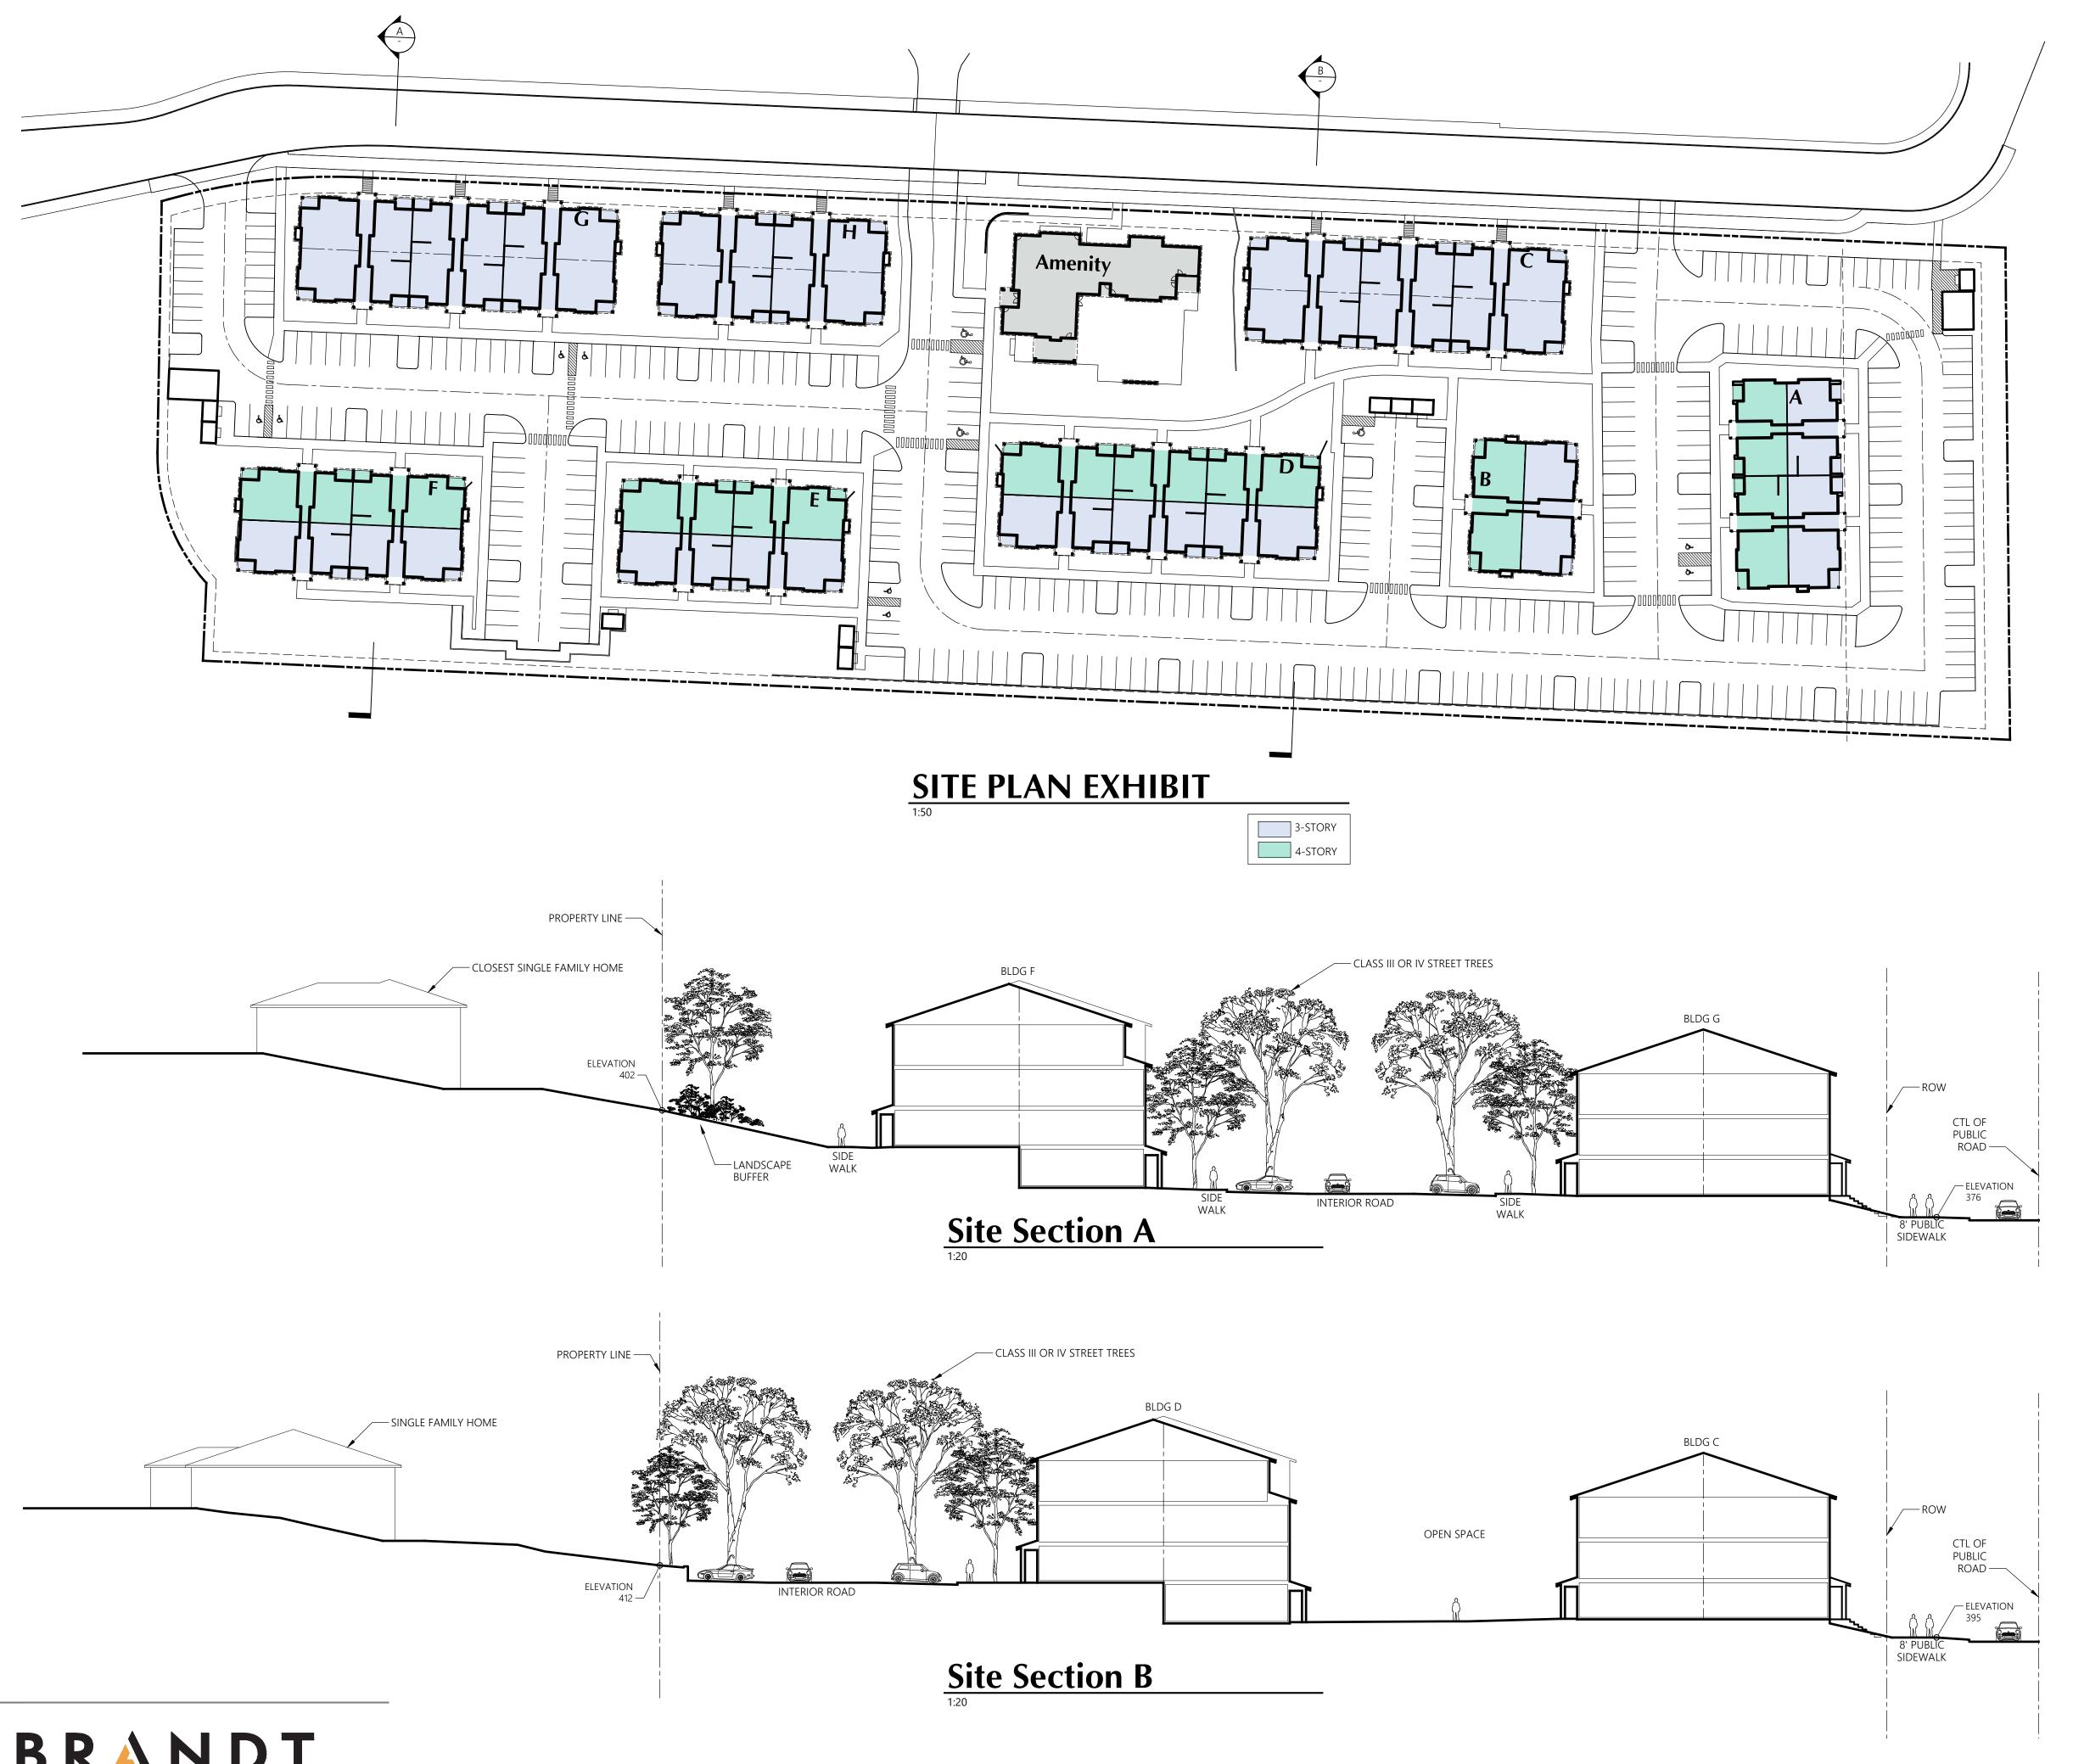



ARCHITECTS


Bradley Heights Apartments
Puyallup, Washington

Timberlane Partners

Site Diagrams

Date:	03/31/2023
Drawn By:	APT/HDM
Job No.:	2306



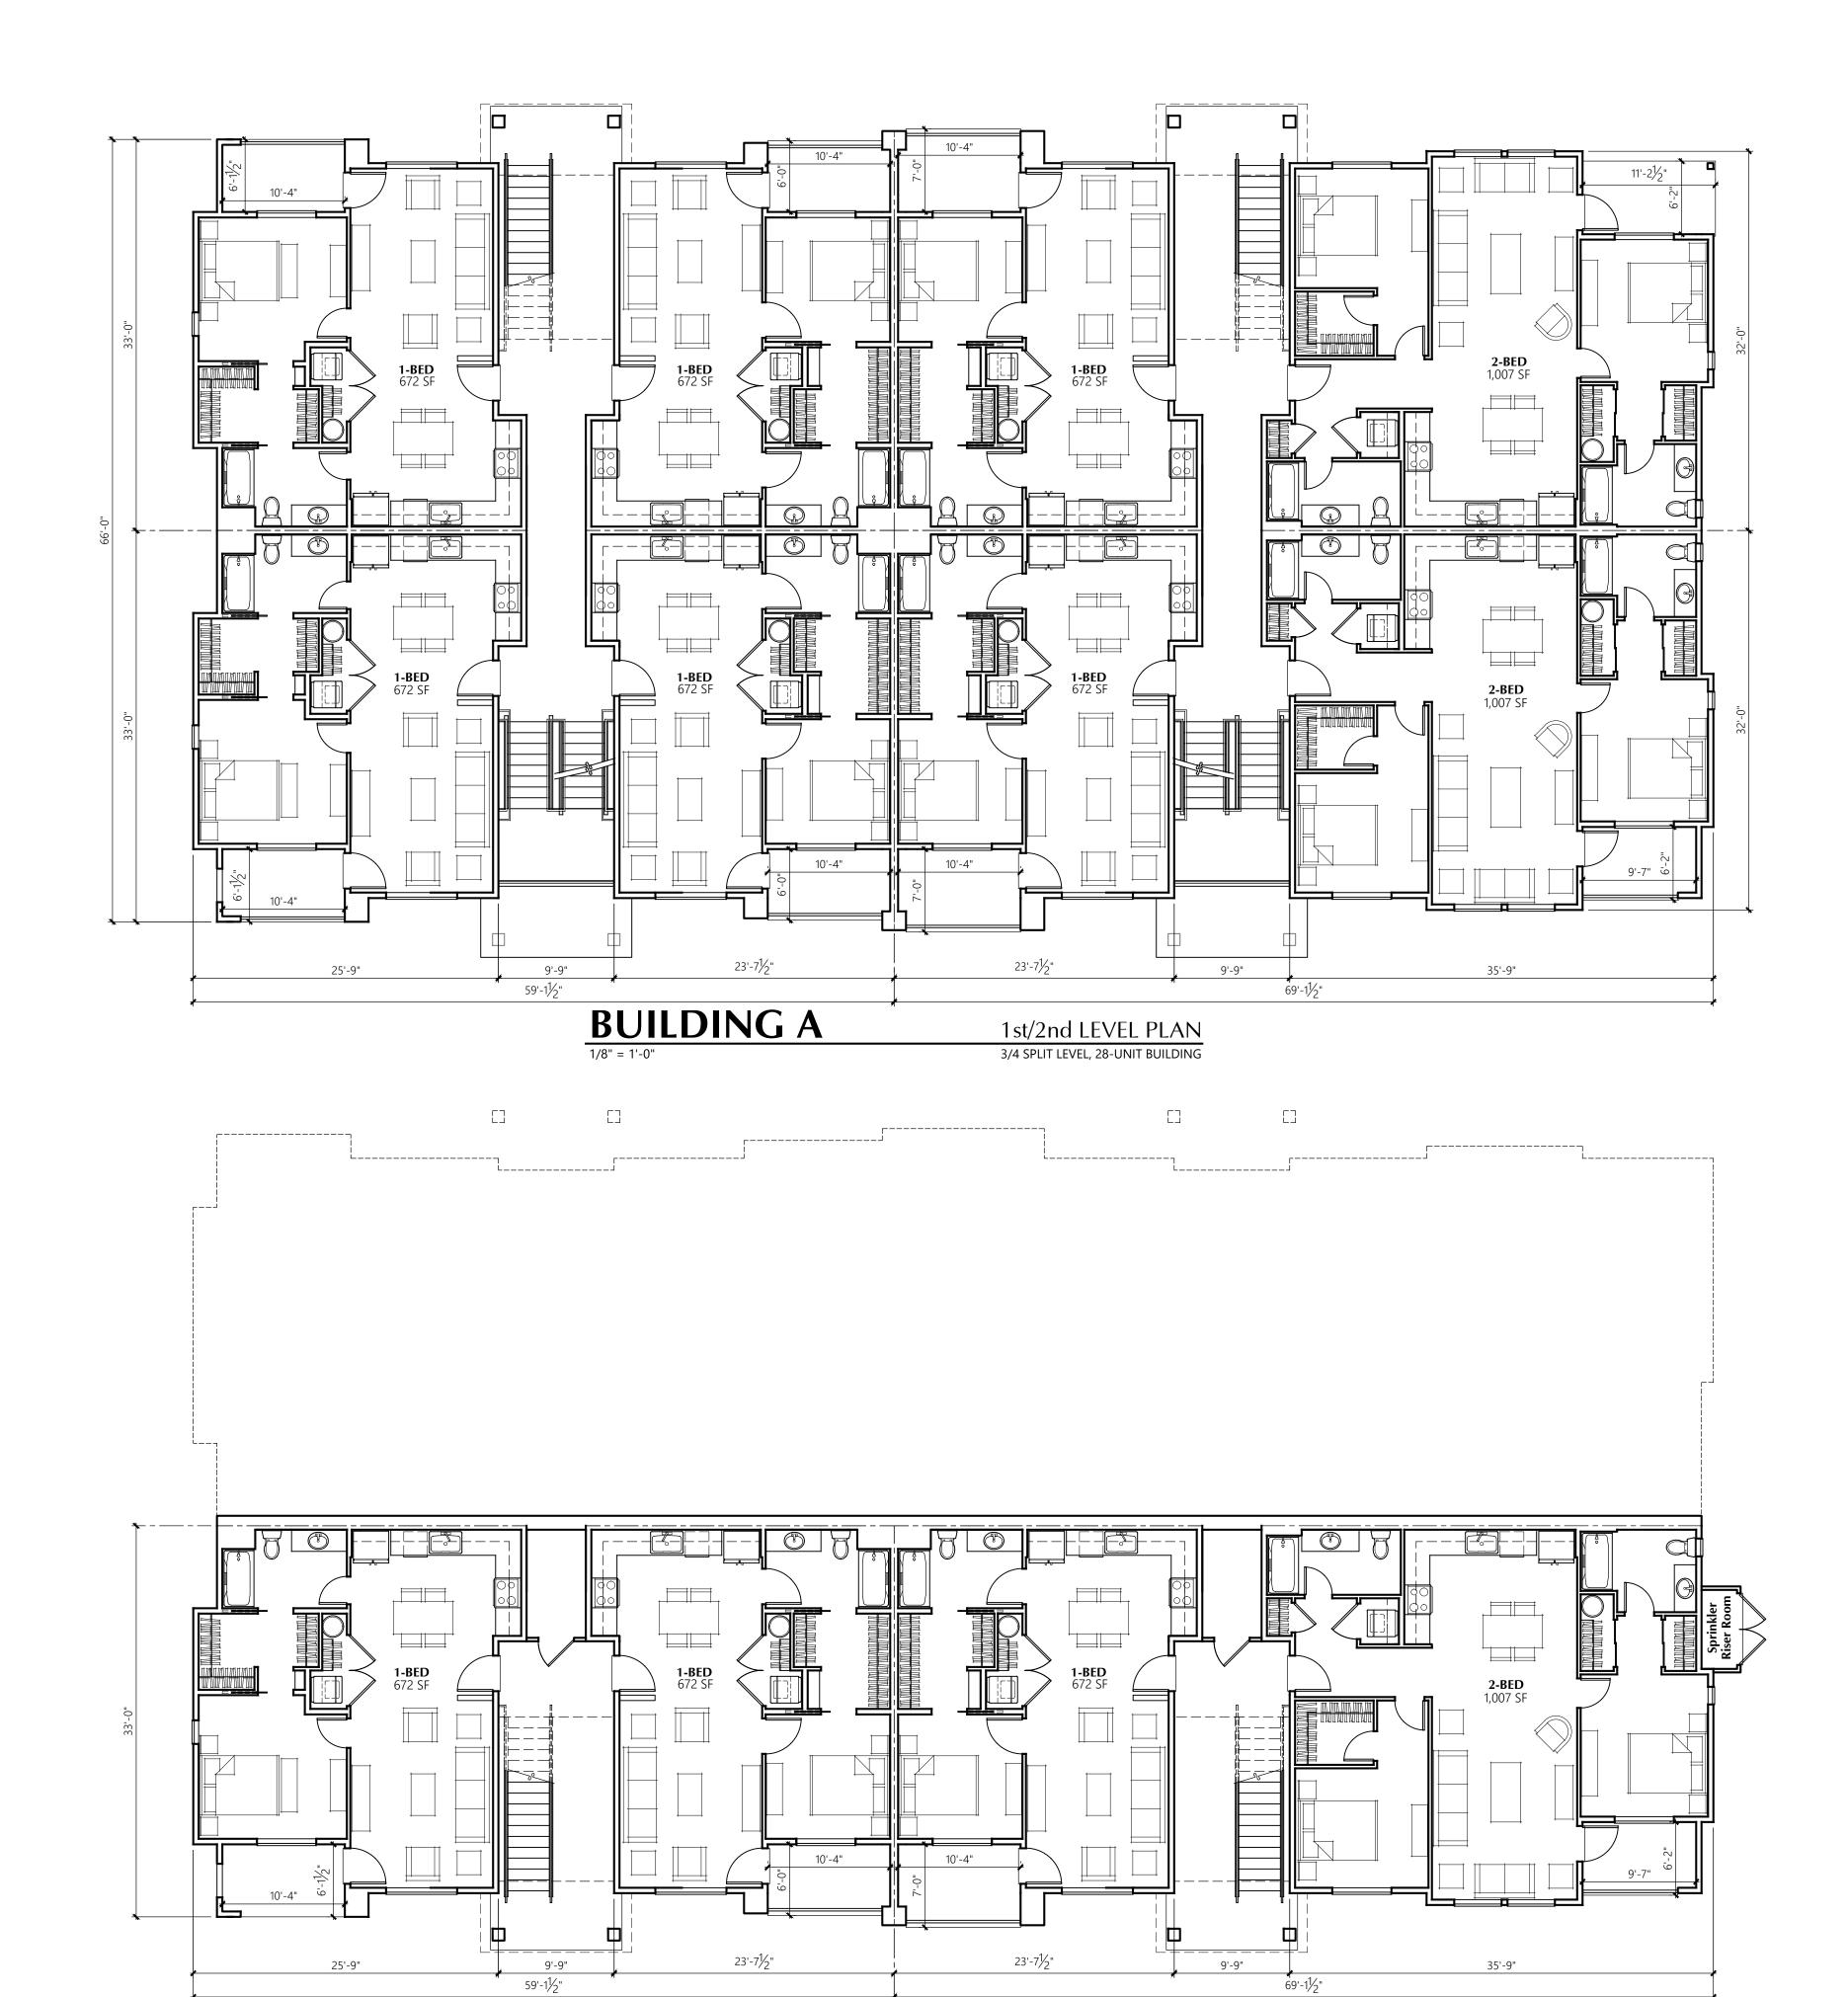



Timberlane Partners

Building A Building Floor Plans

1st LEVEL PLAN


3/4 SPLIT LEVEL, 28-UNIT BUILDING


2-6-2023 APT/HDM Drawn By: 2306

A4 Sheet No.:

BUILDING A

1/8" = 1'-0"

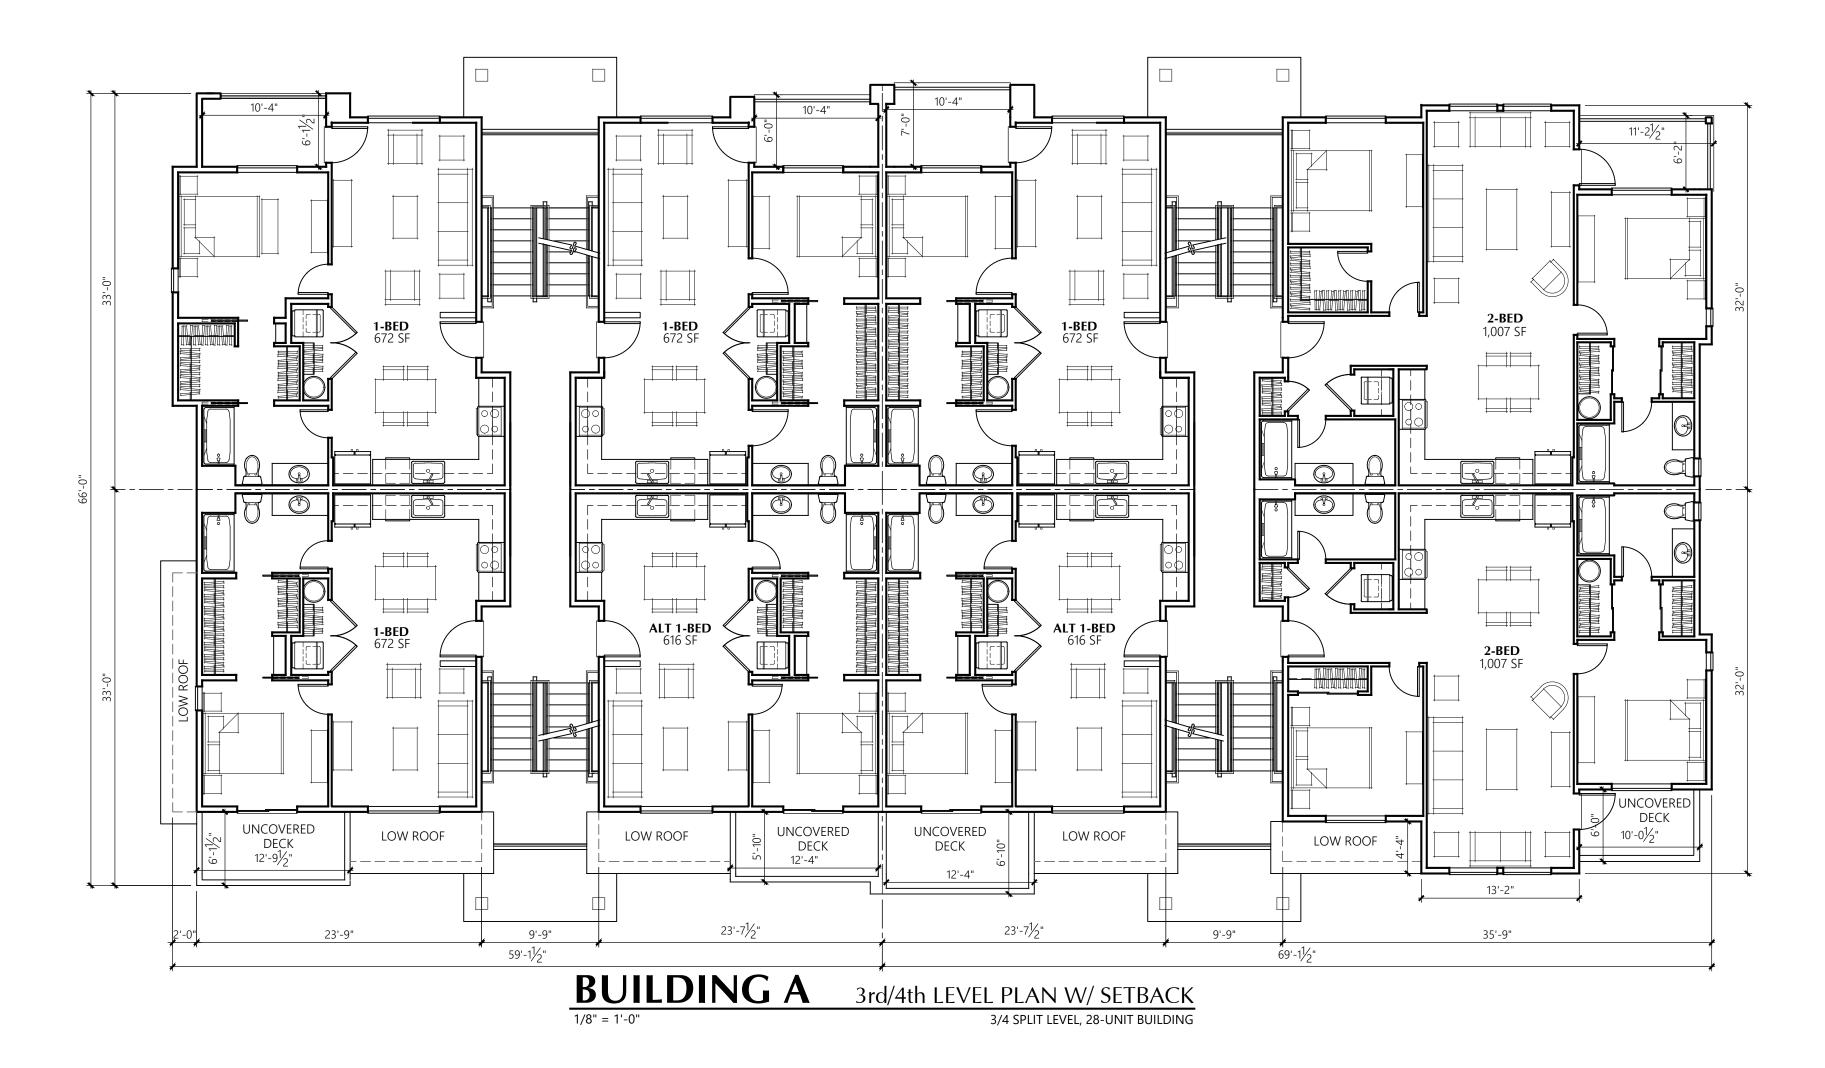

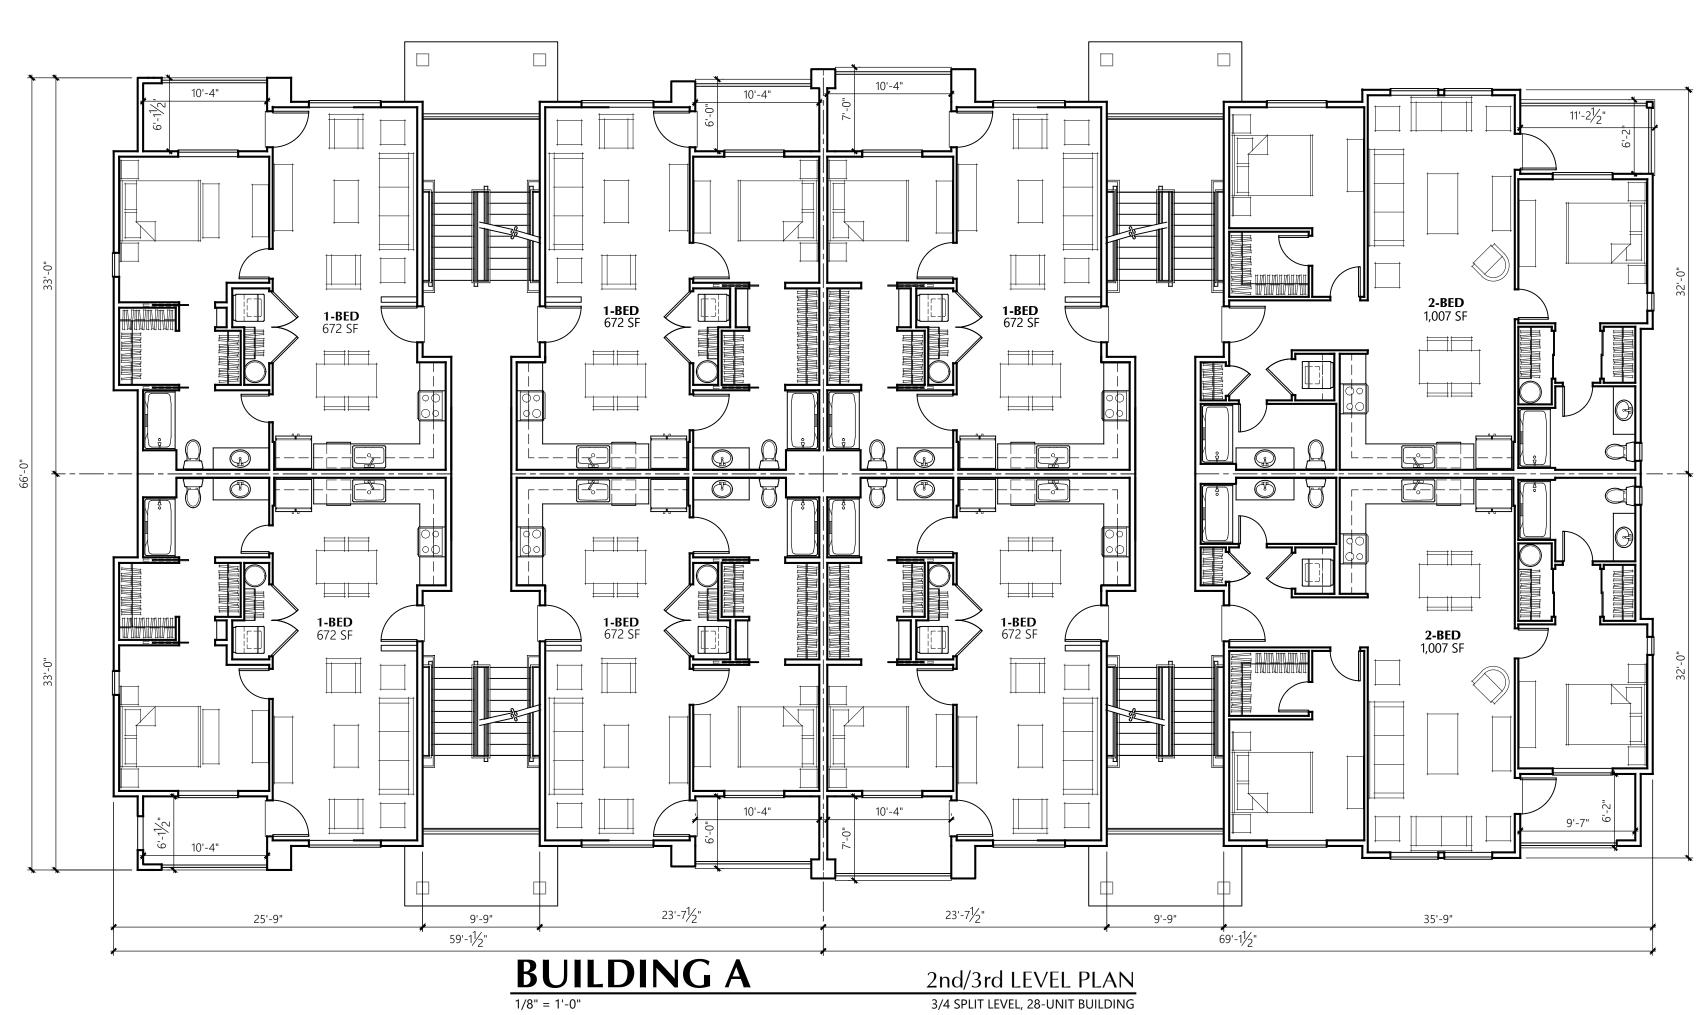





Timberlane Partners


Building A Building Floor Plans

2-6-2023 APT/HDM Drawn By: 2306

A5 Sheet No.:

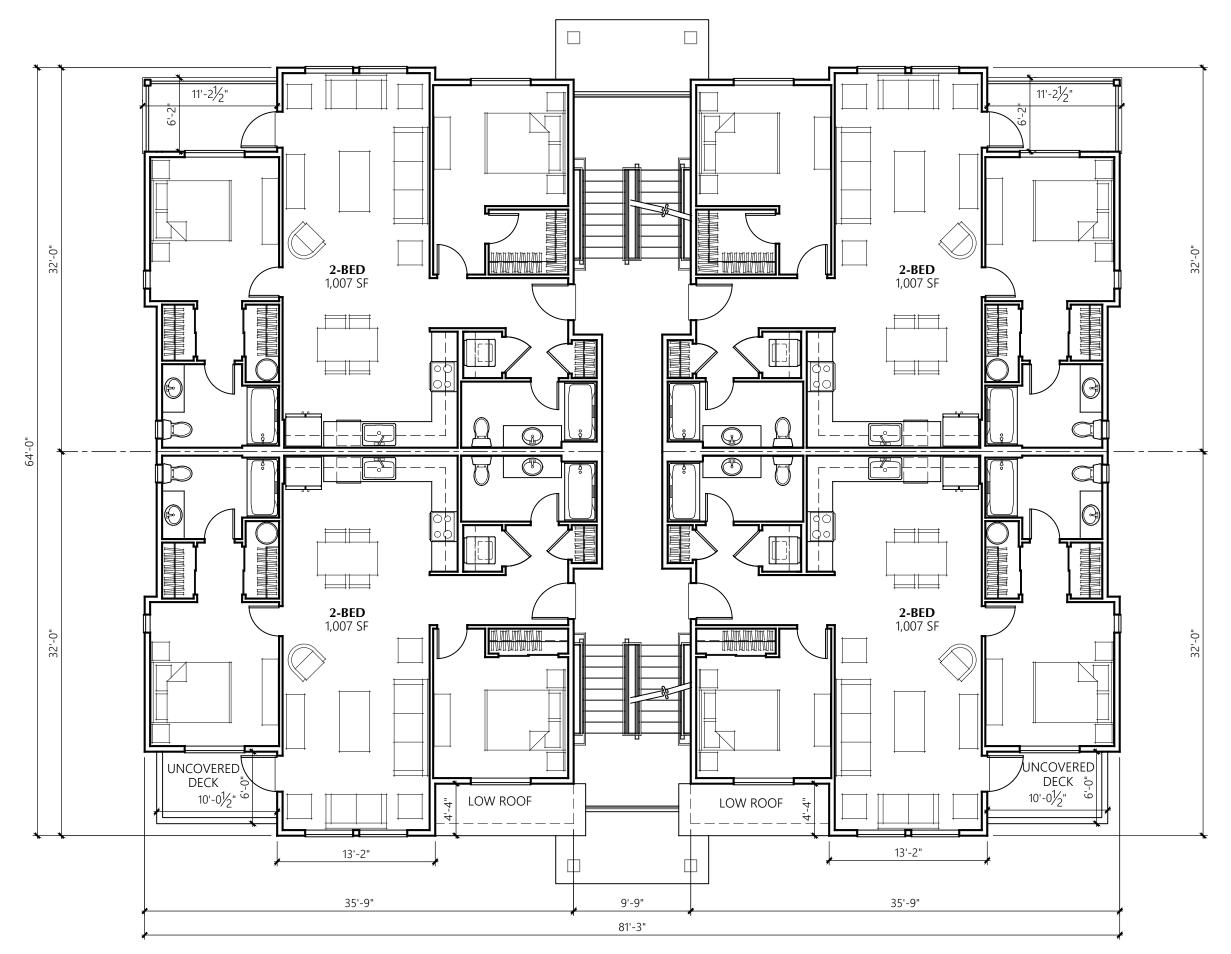

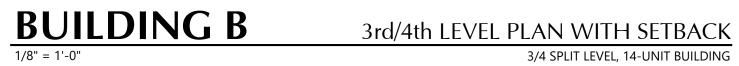

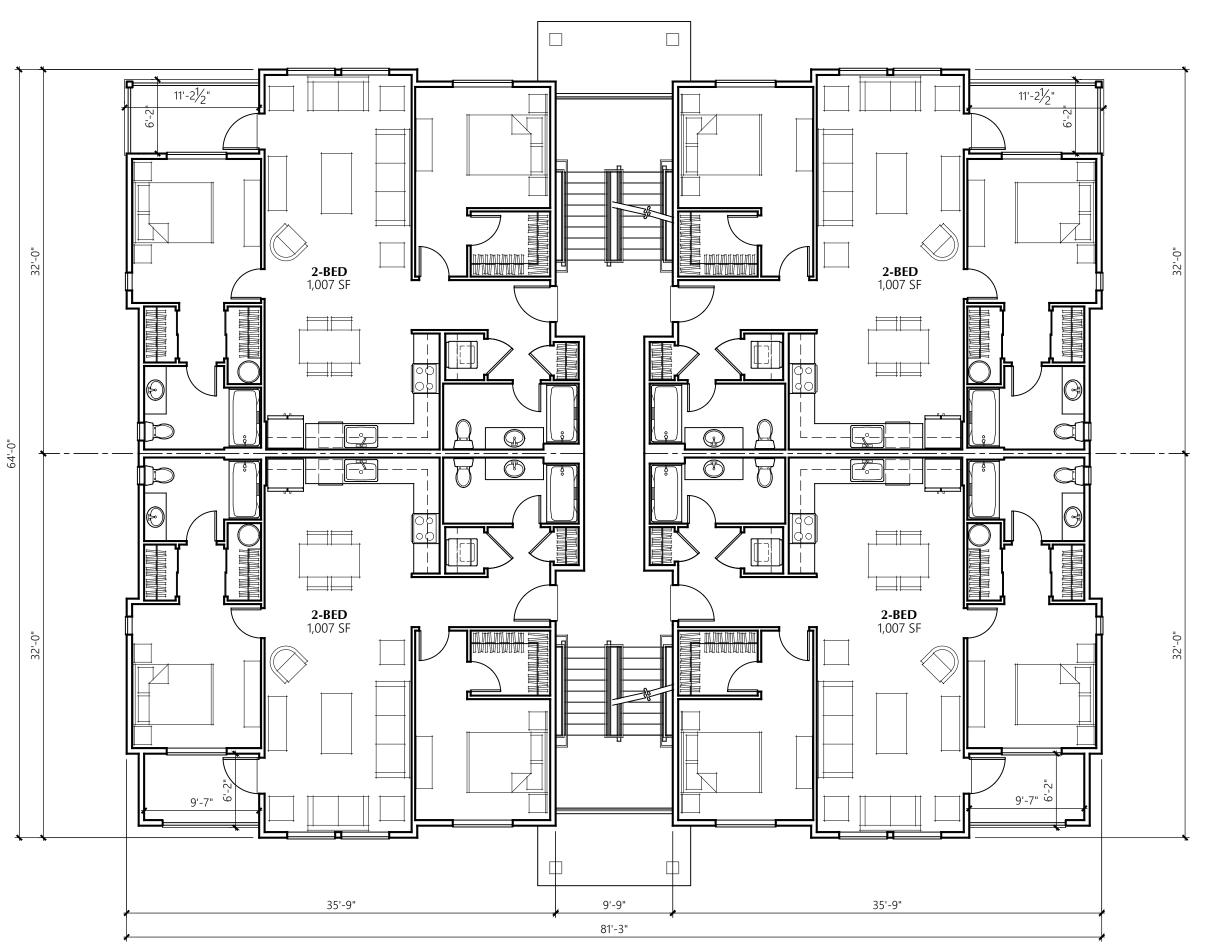

BUILDING B

Timberlane Partners

2nd/3rd LEVEL PLAN

3/4 SPLIT LEVEL, 14-UNIT BUILDING

2-6-2023 APT/HDM Drawn By: 2306

1st LEVEL PLAN

3/4 SPLIT LEVEL, 14-UNIT BUILDING

1st/2nd LEVEL PLAN

3/4 SPLIT LEVEL, 14-UNIT BUILDING

A6 Sheet No.:


9'-7" 🖒






BUILDING B

BUILDING B

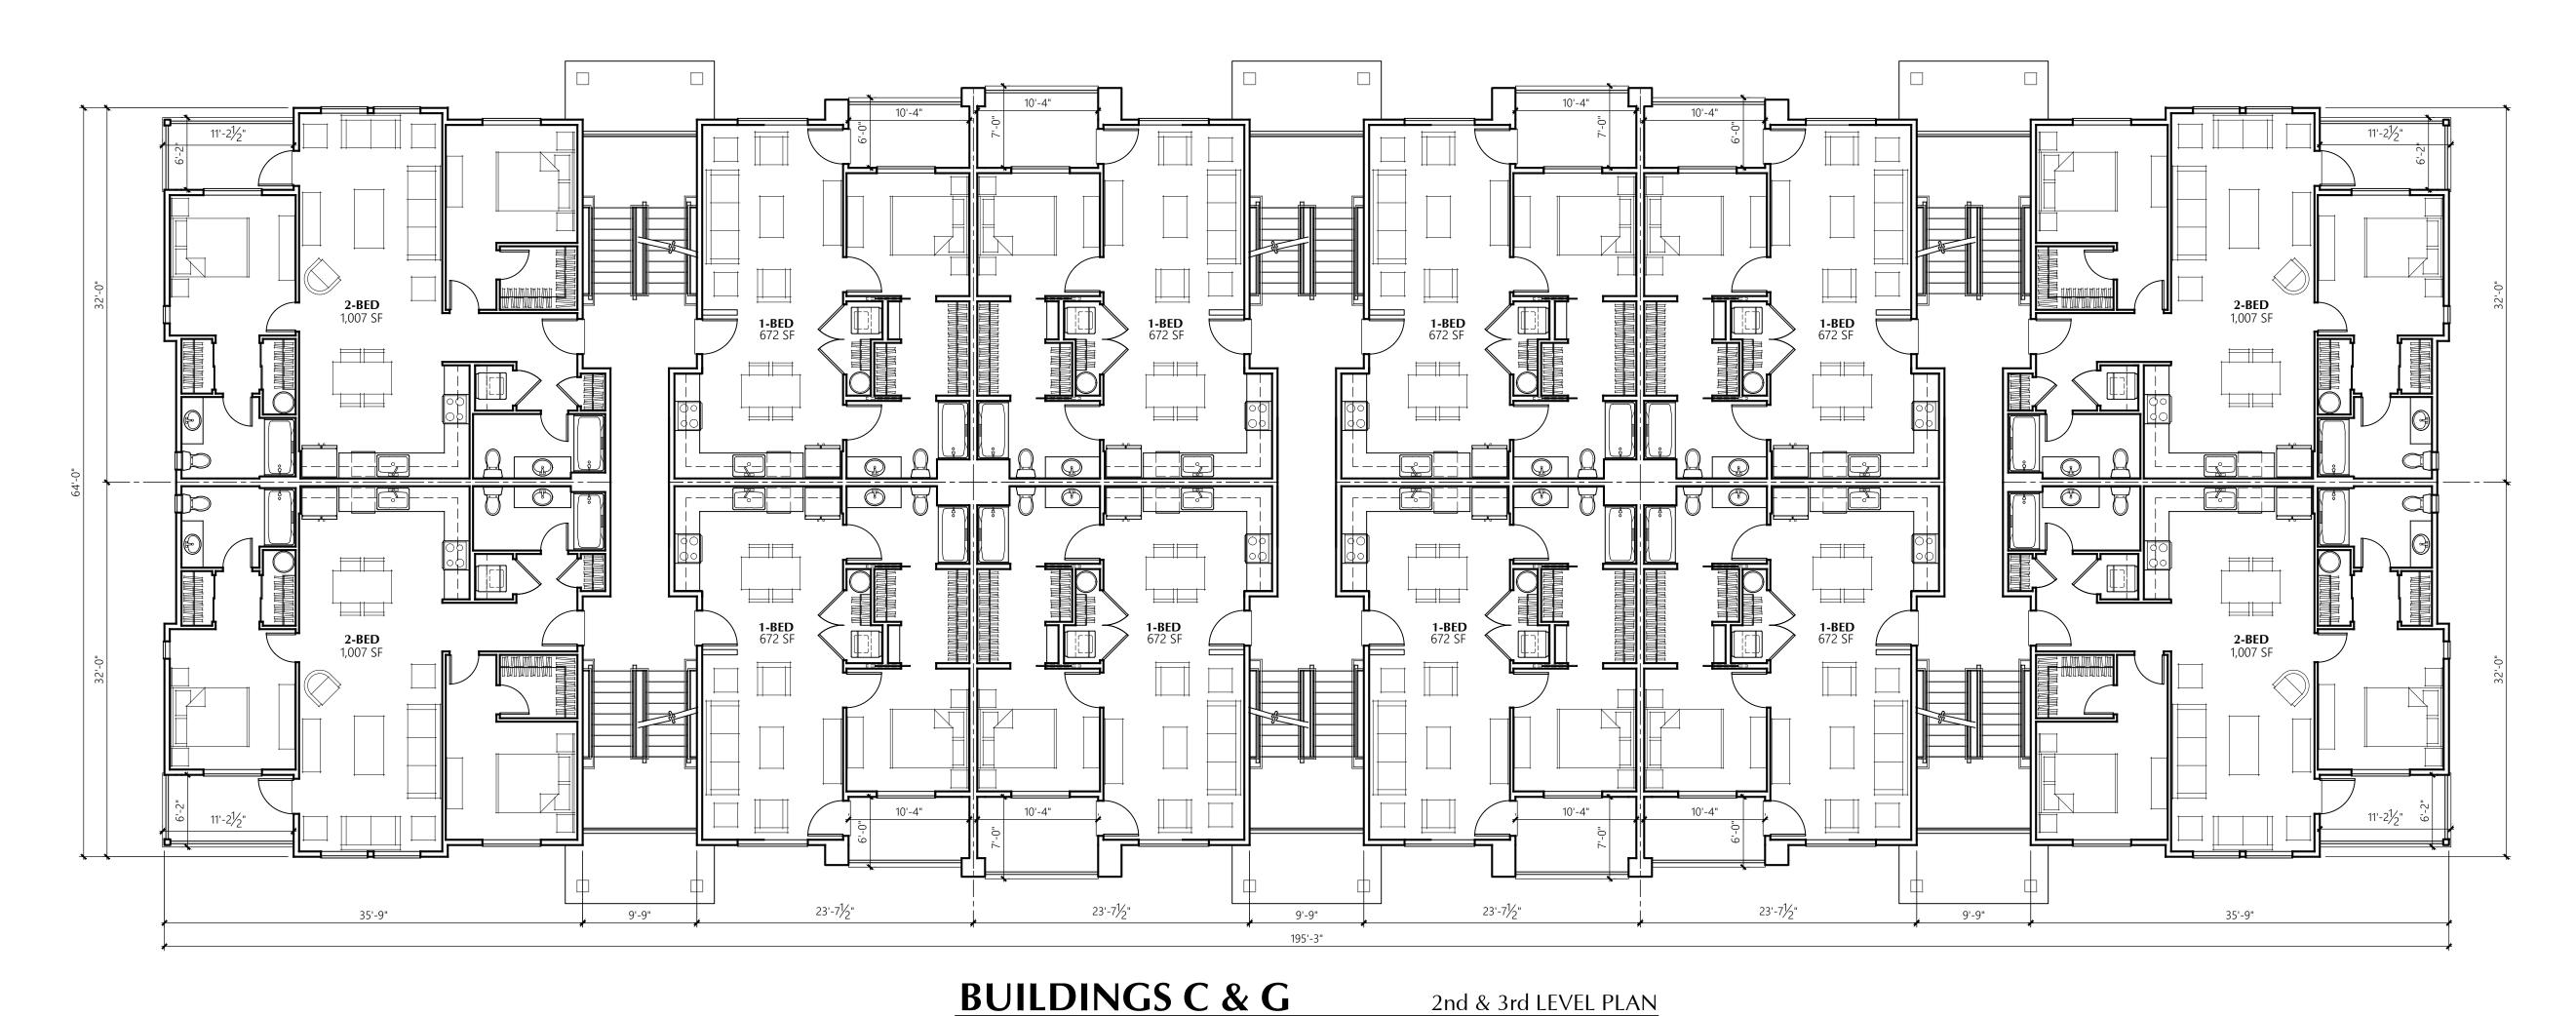

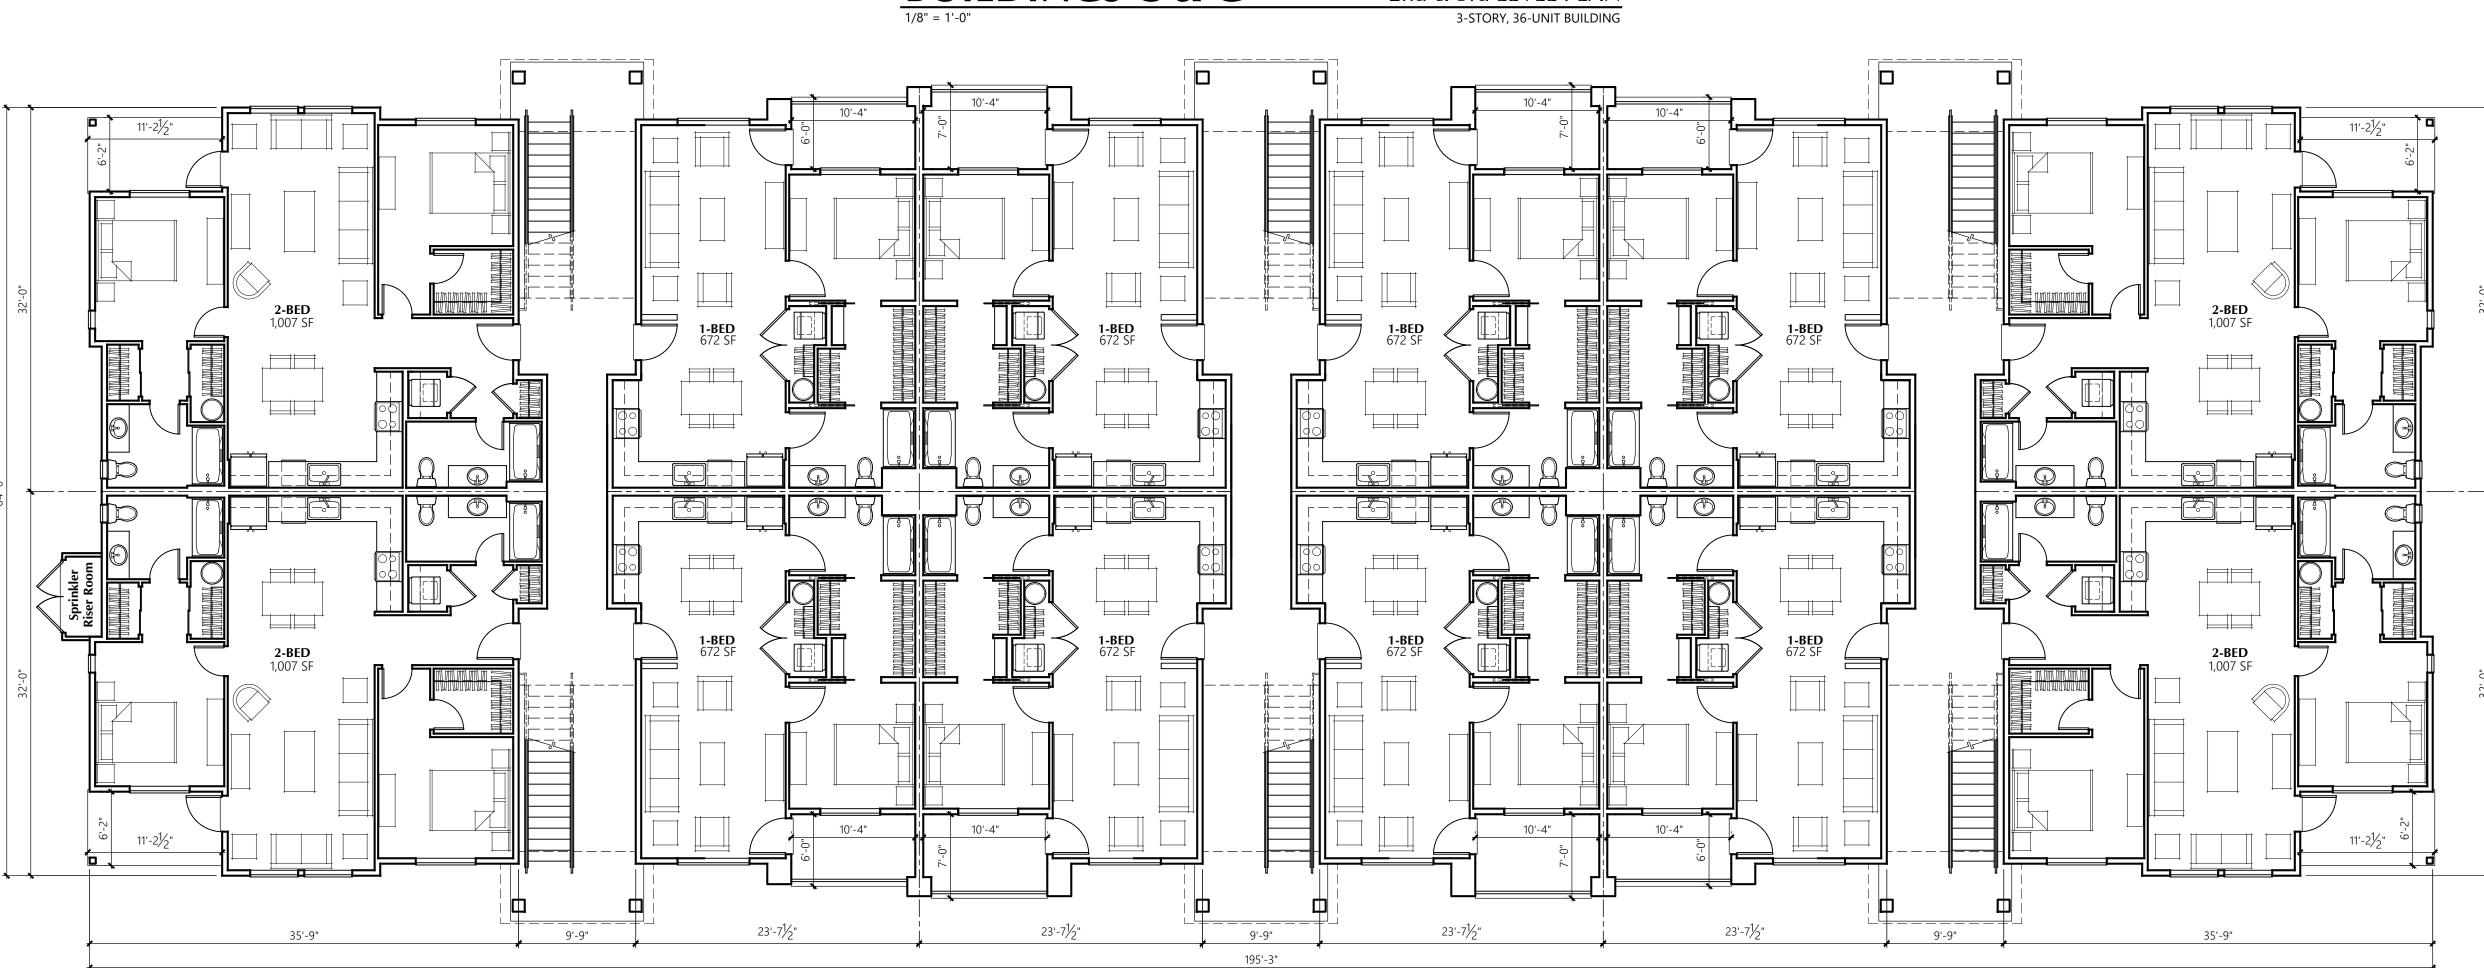



Puyallup, Washington

Timberlane Partners


BUILDINGS C & G

Buildings C & G **Building Floor Plans**

2nd LEVEL PLAN 3-STORY, 36-UNIT BUILDING

> 2-6-2023 APT/HDM Drawn By: 2306

A7 Sheet No.:

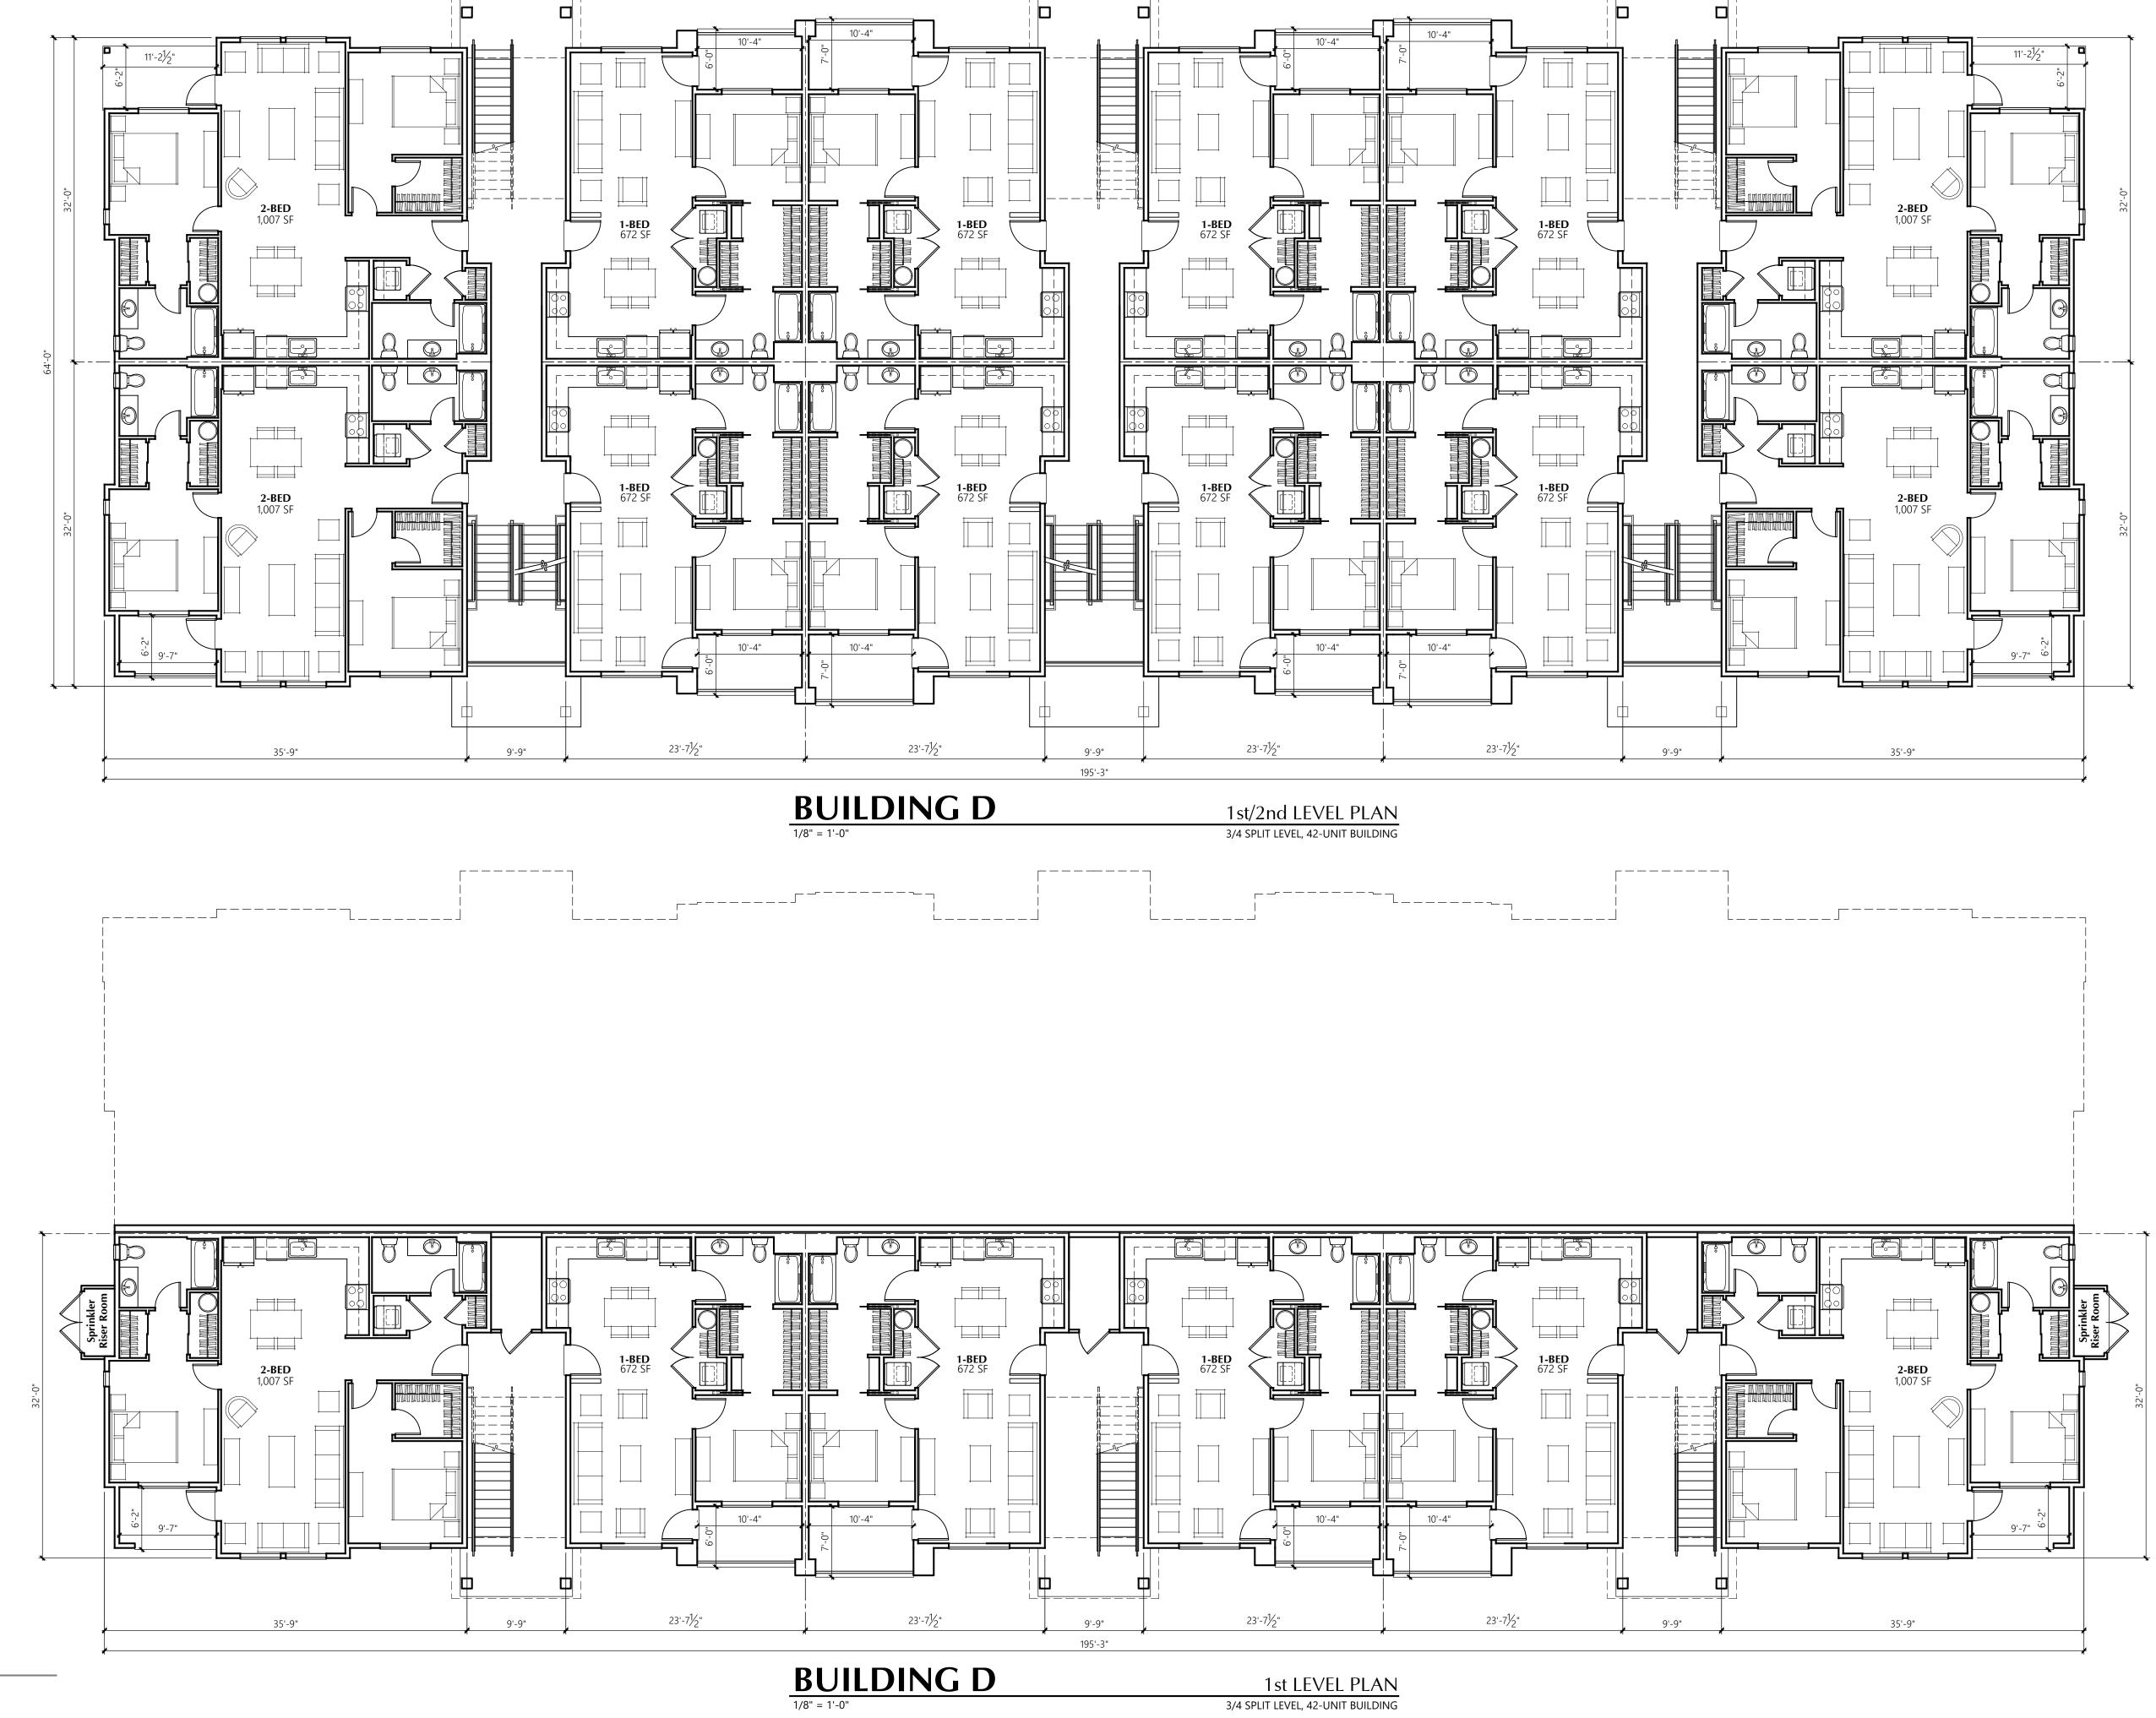




Timberlane Partners

Building D Building Floor Plans


2-6-2023 APT/HDM Drawn By: 2306

A8 Sheet No.:

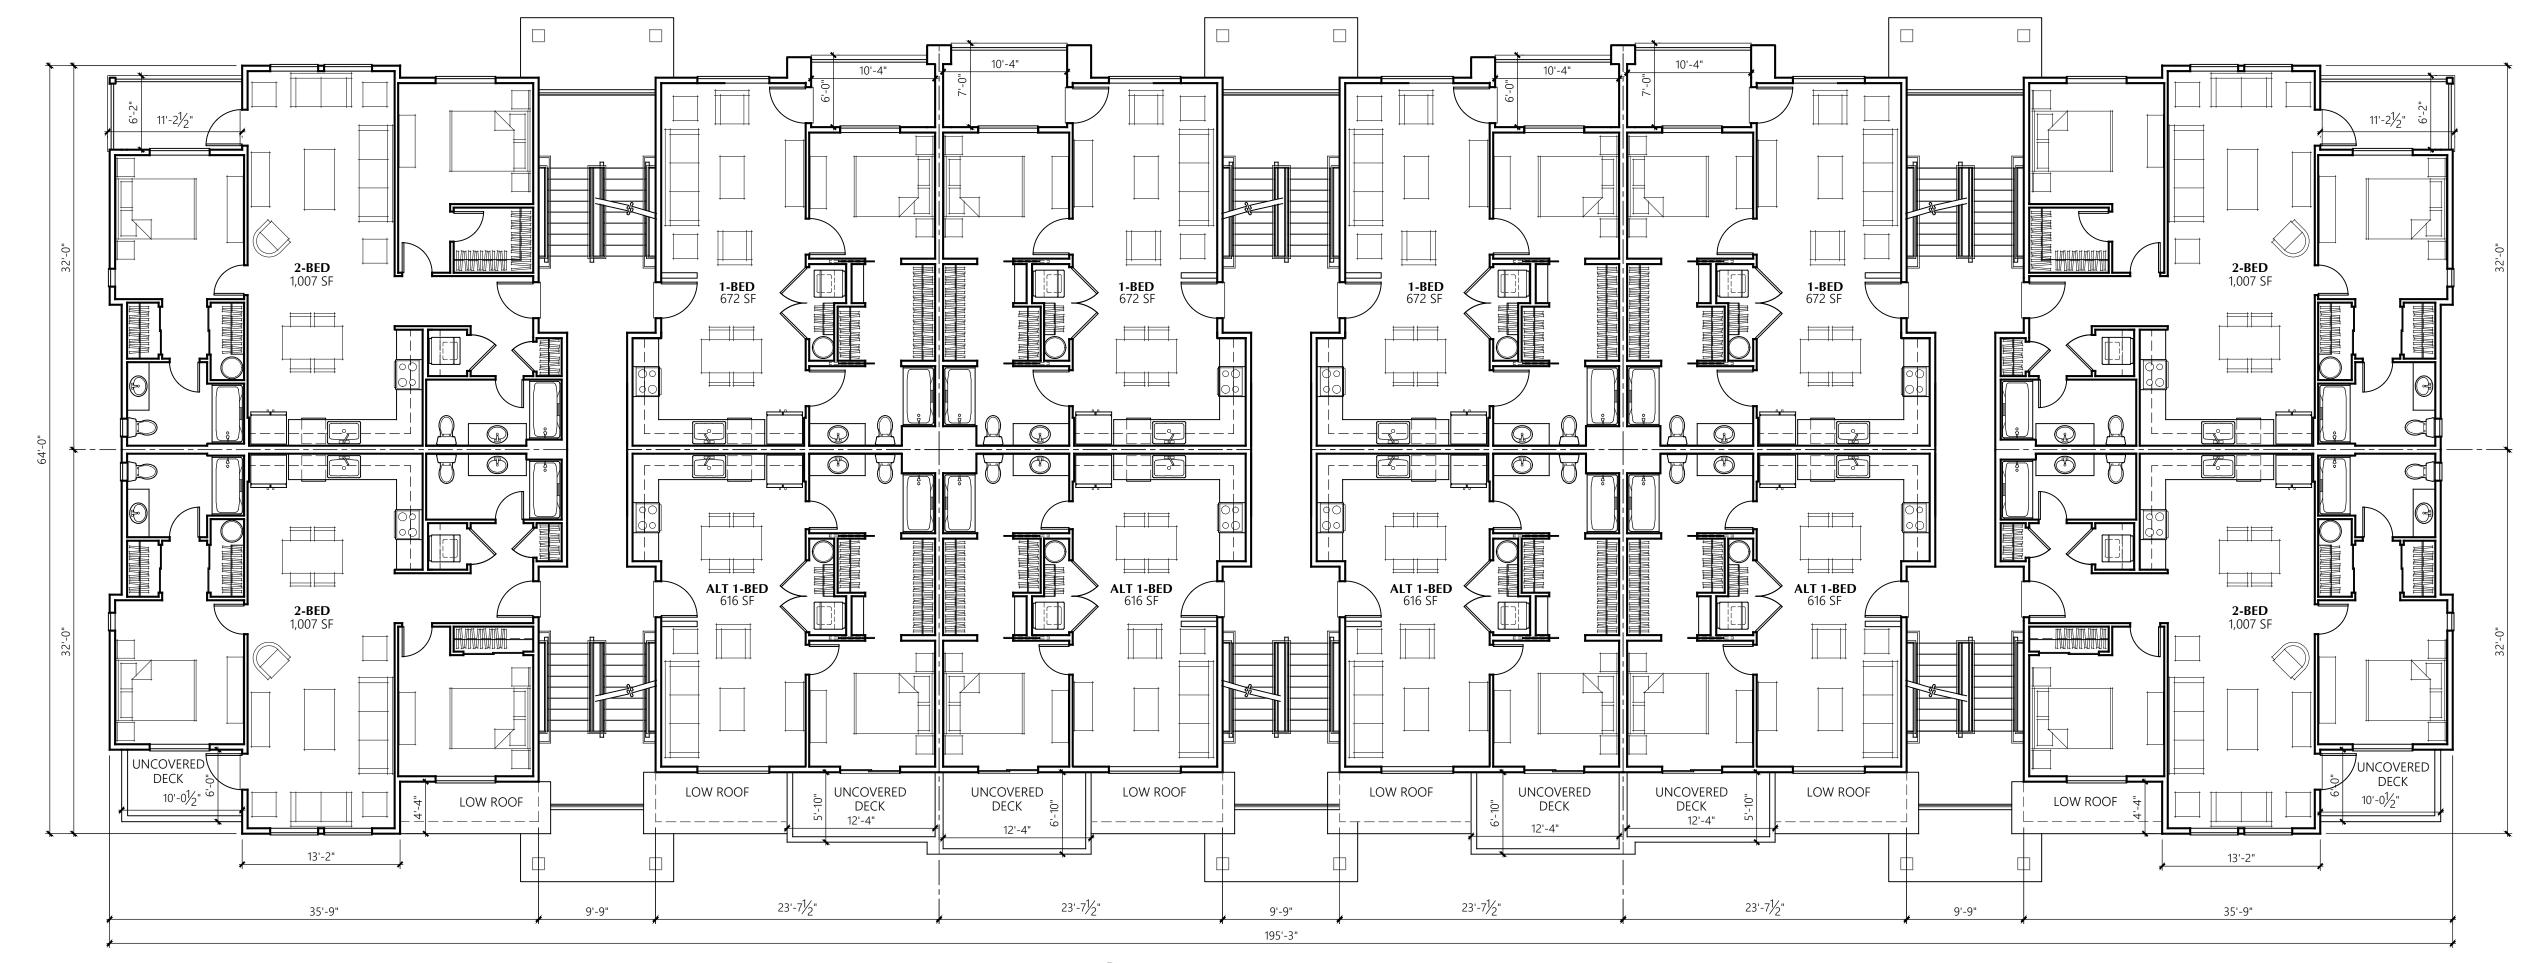

BUILDING D

3rd/4th LEVEL PLAN W/ SETBACK 3/4 SPLIT LEVEL, 42-UNIT BUILDING

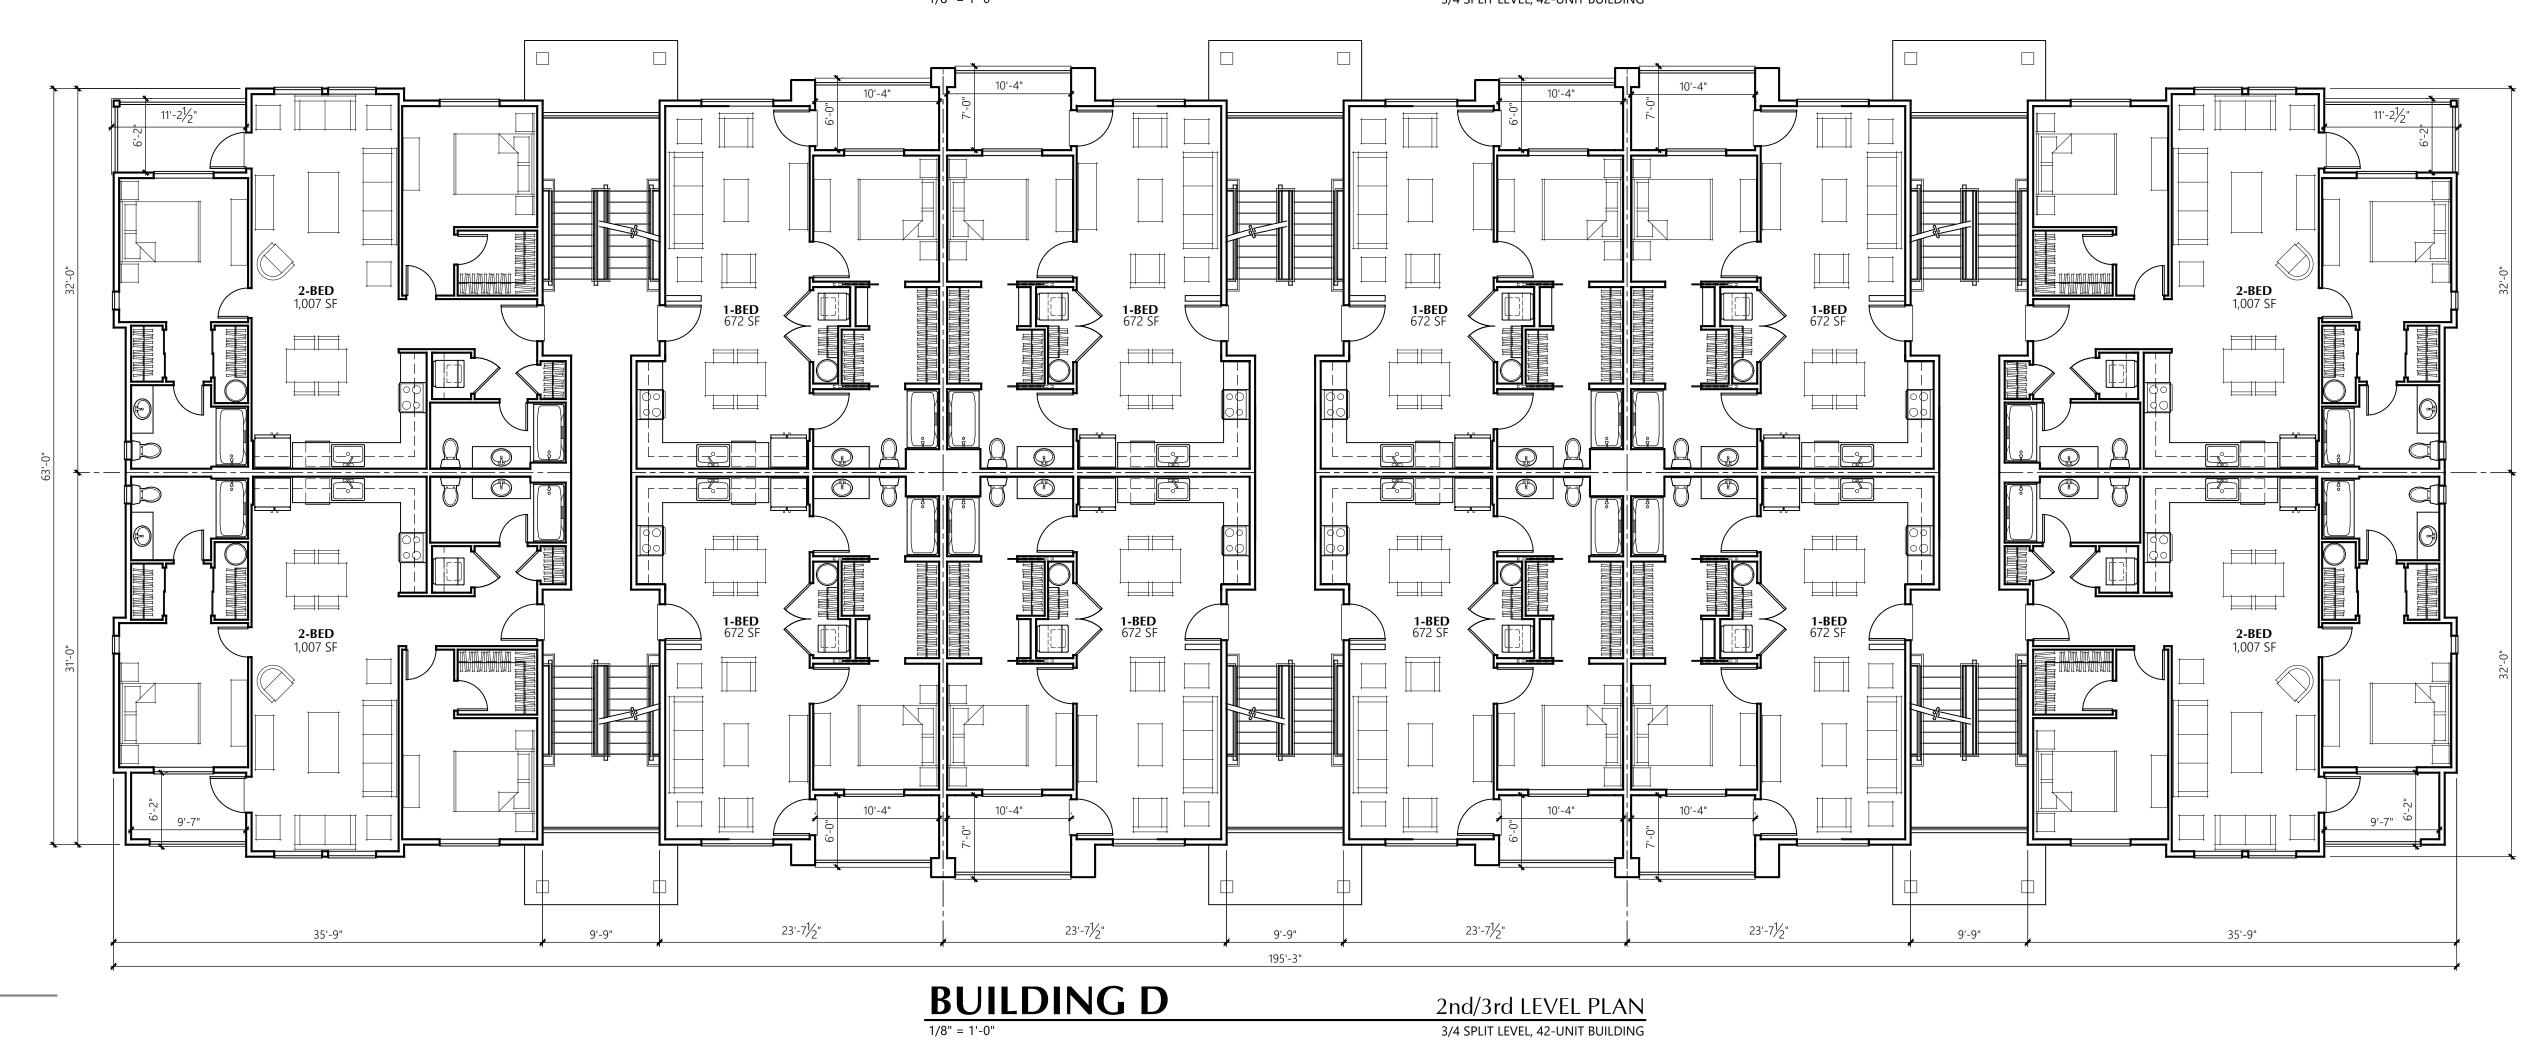

MILBRANDT


ARCHITECTS

Bradley Heights Apartments


Timberlane Partners

Building D Building Floor Plans

2-6-2023 APT/HDM Drawn By: 2306 **A9** Sheet No.:

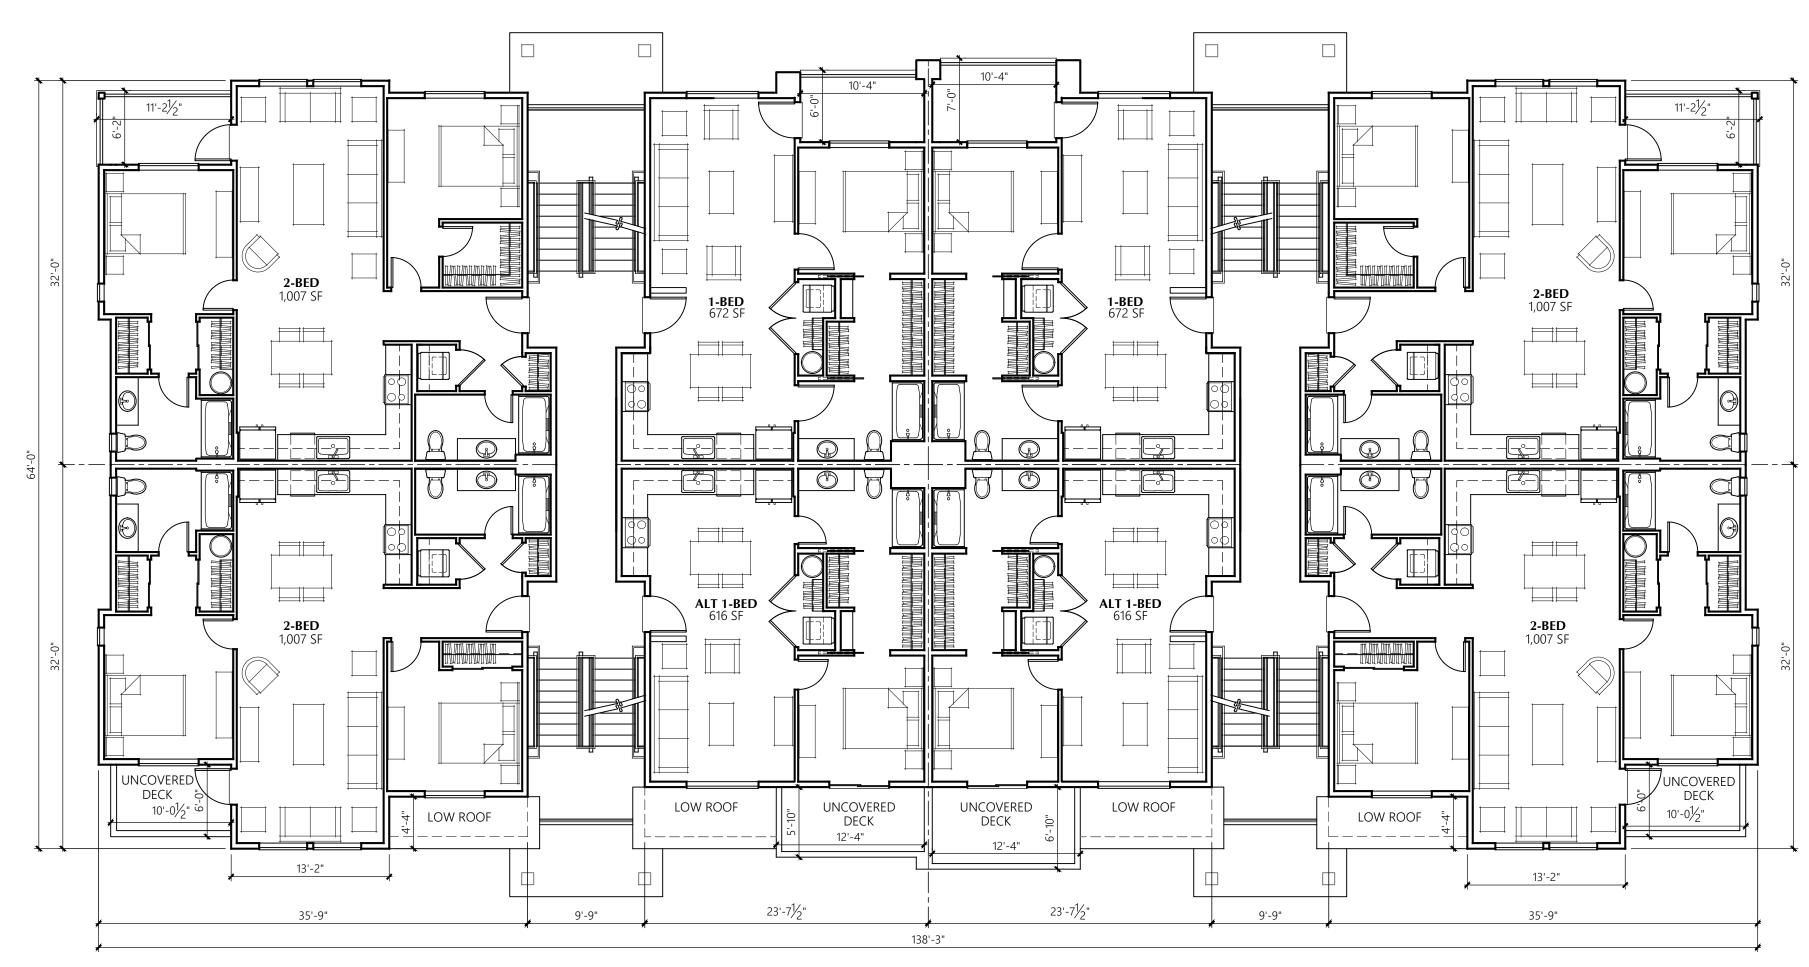

BUILDINGS E & F 3rd/4th LEVEL PLAN W/ SETBACK 3/4 SPLIT LEVEL, 28-UNIT BUILDING

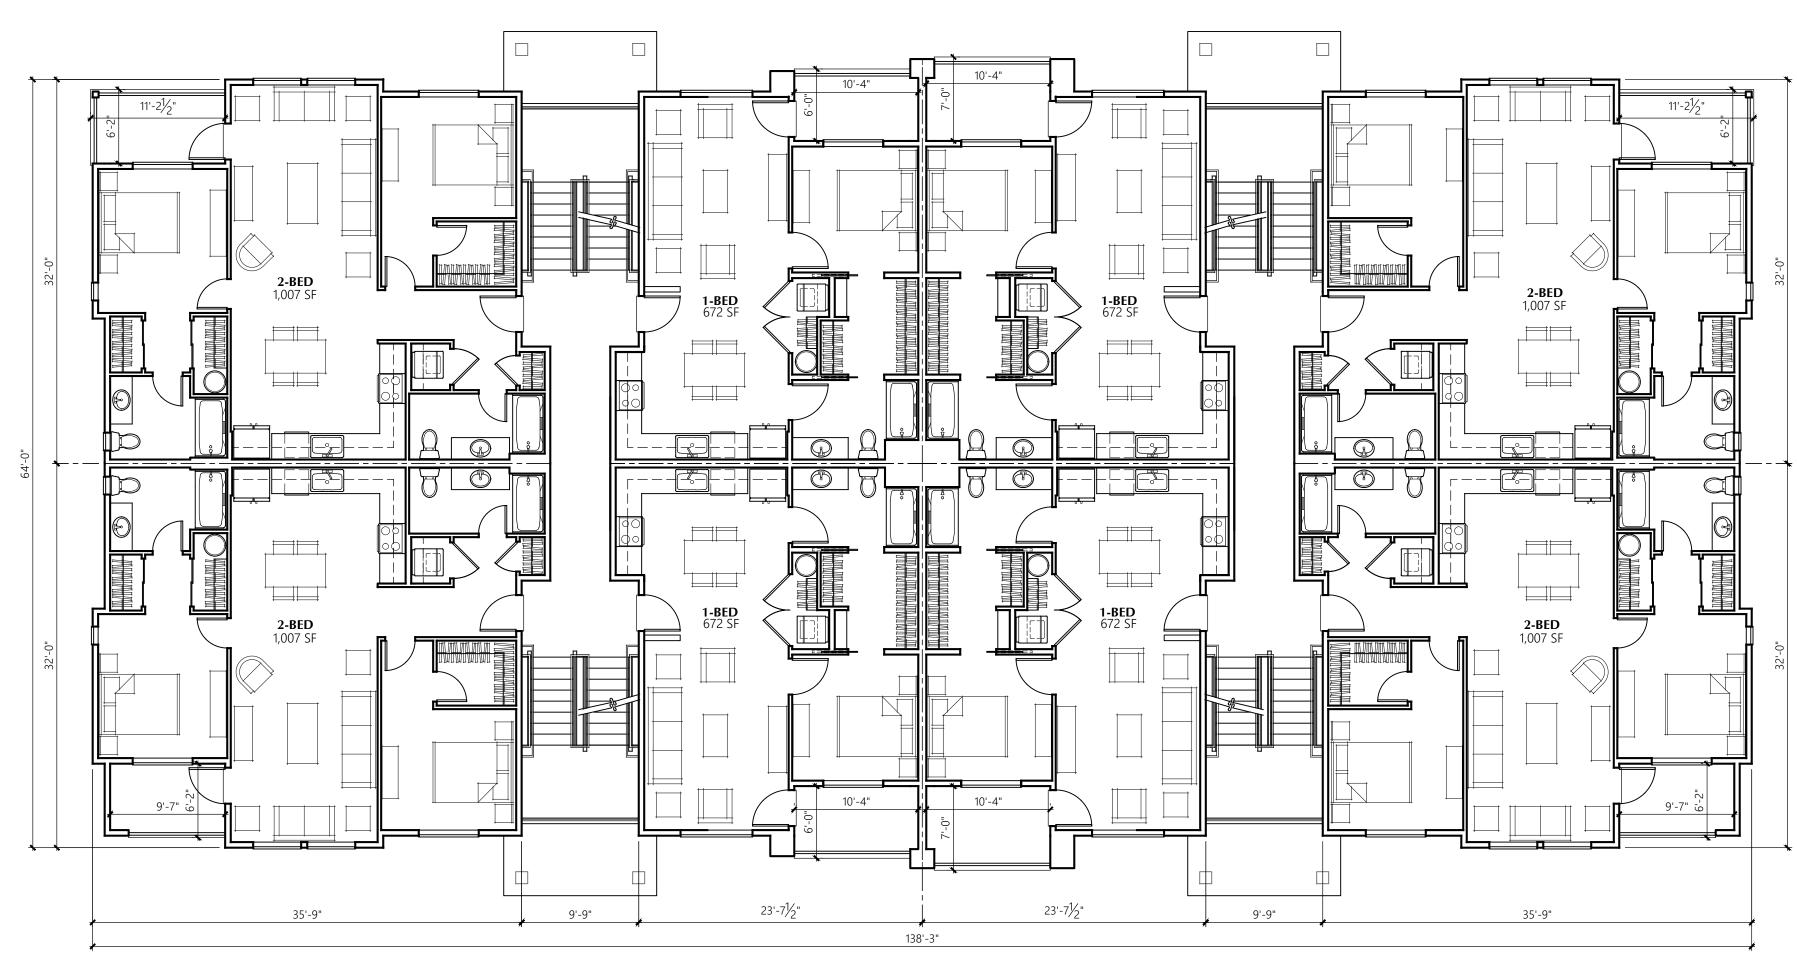

BUILDINGS E & F

1/8" = 1'-0"

2nd/3rd LEVEL PLAN
3/4 SPLIT LEVEL, 28-UNIT BUILDING

MILBRANDT ARCHITECTS


Bradley Heights Apartments


Timberlane Partners

Buildings E & F **Building Floor Plans**

2-6-2023 APT/HDM Drawn By: 2306

A10 Sheet No.:

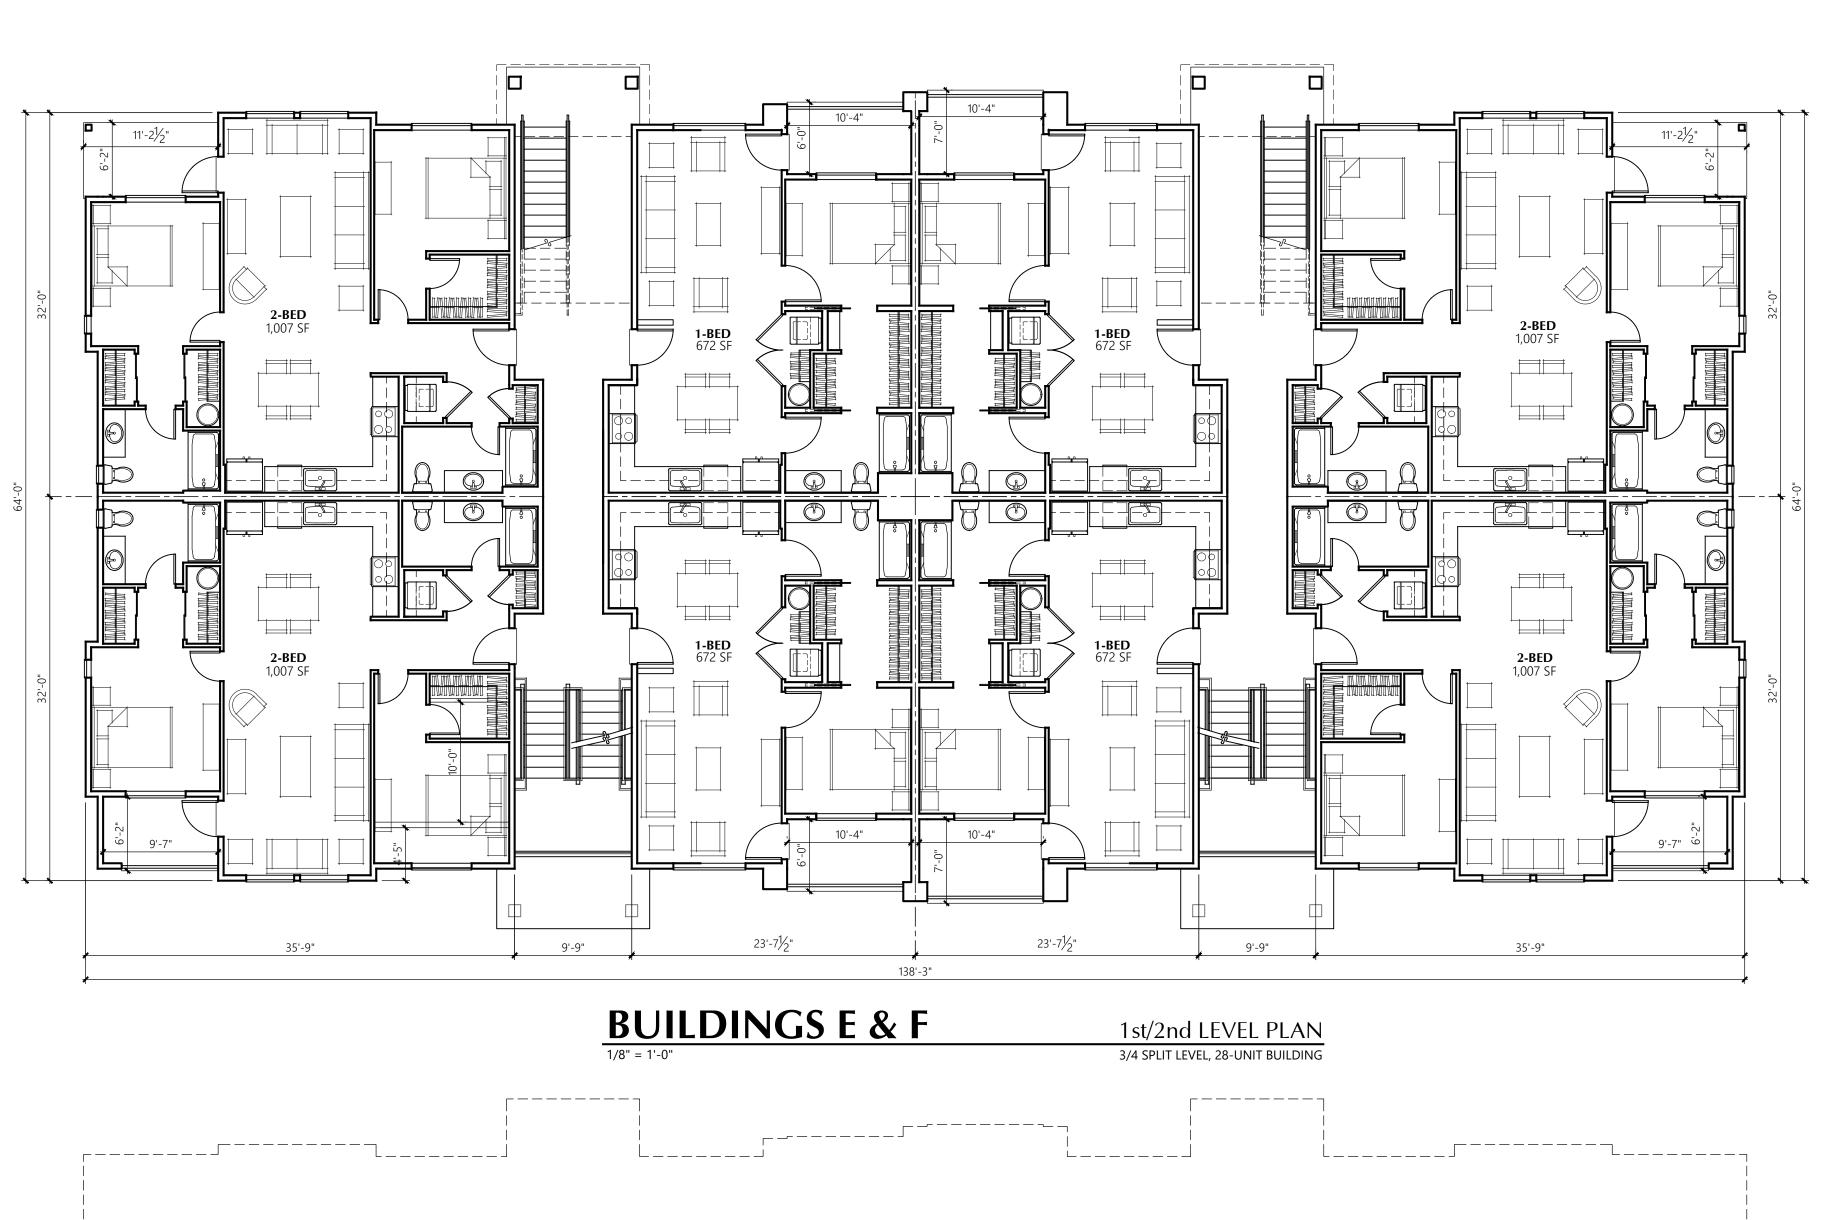

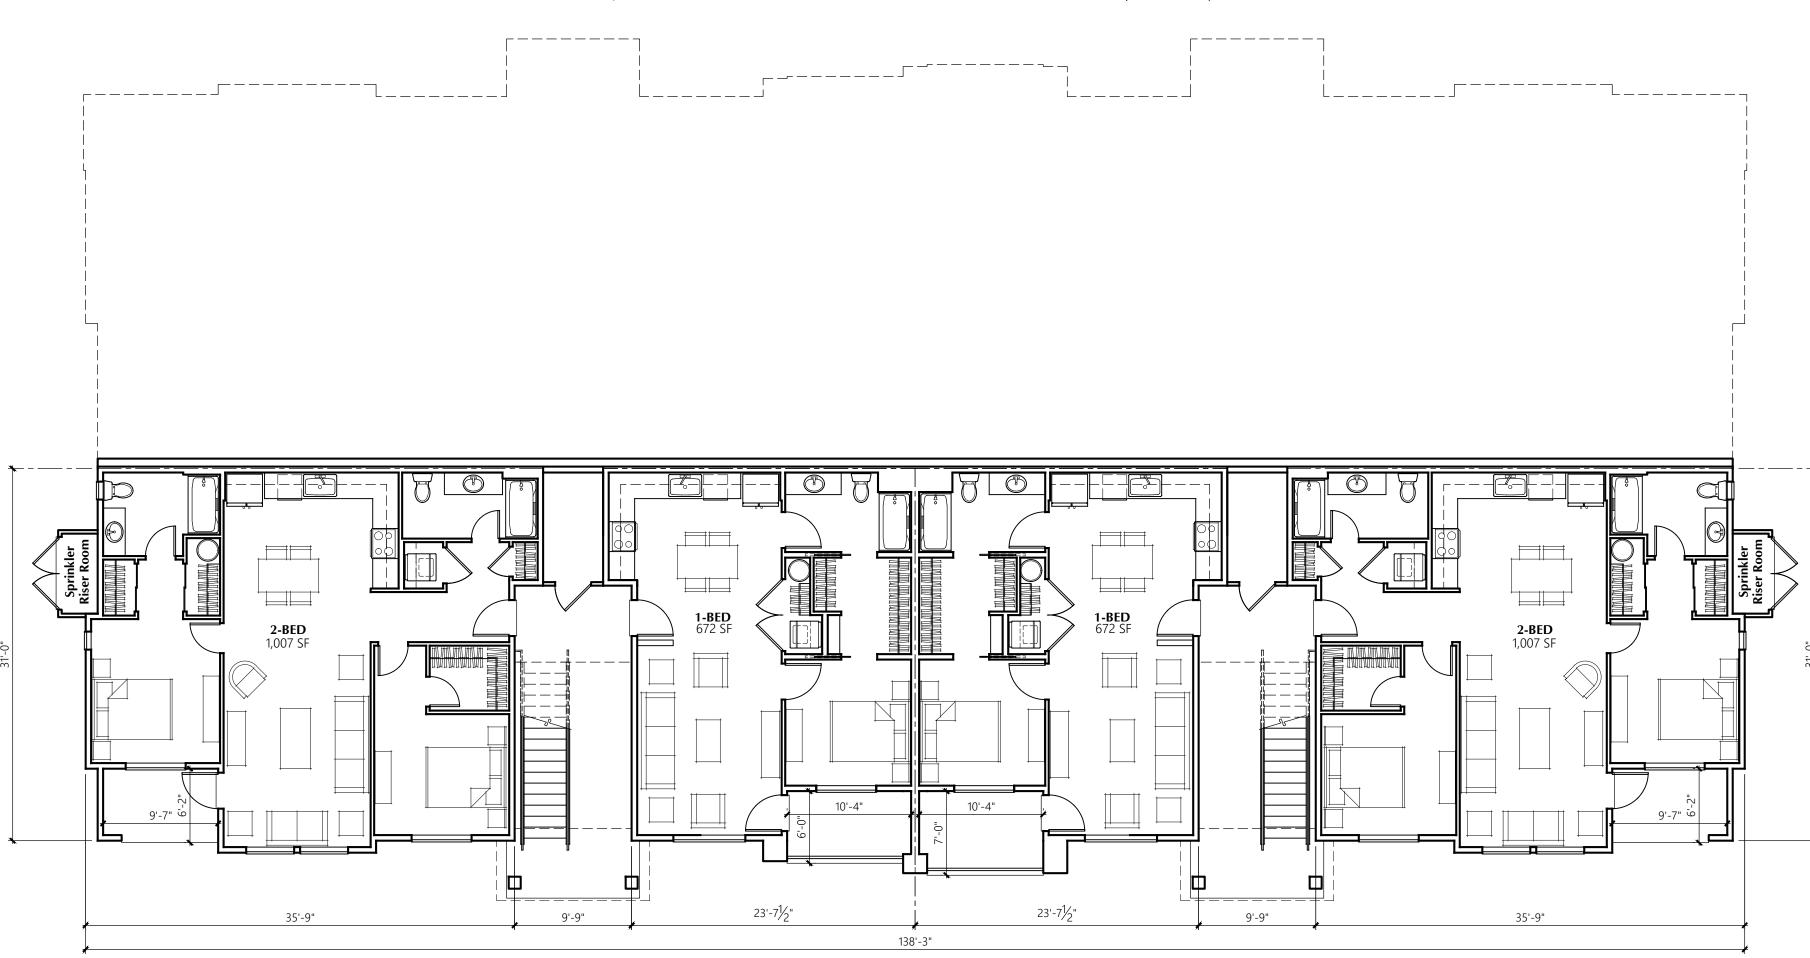

BUILDINGS E & F

1/8" = 1'-0"

MILBRANDT ARCHITECTS

Bradley Heights Apartments

Timberlane Partners


Buildings E & F **Building Floor Plans**

1st LEVEL PLAN

3/4 SPLIT LEVEL, 28-UNIT BUILDING

2-6-2023 APT/HDM Drawn By: 2306

A11 Sheet No.:

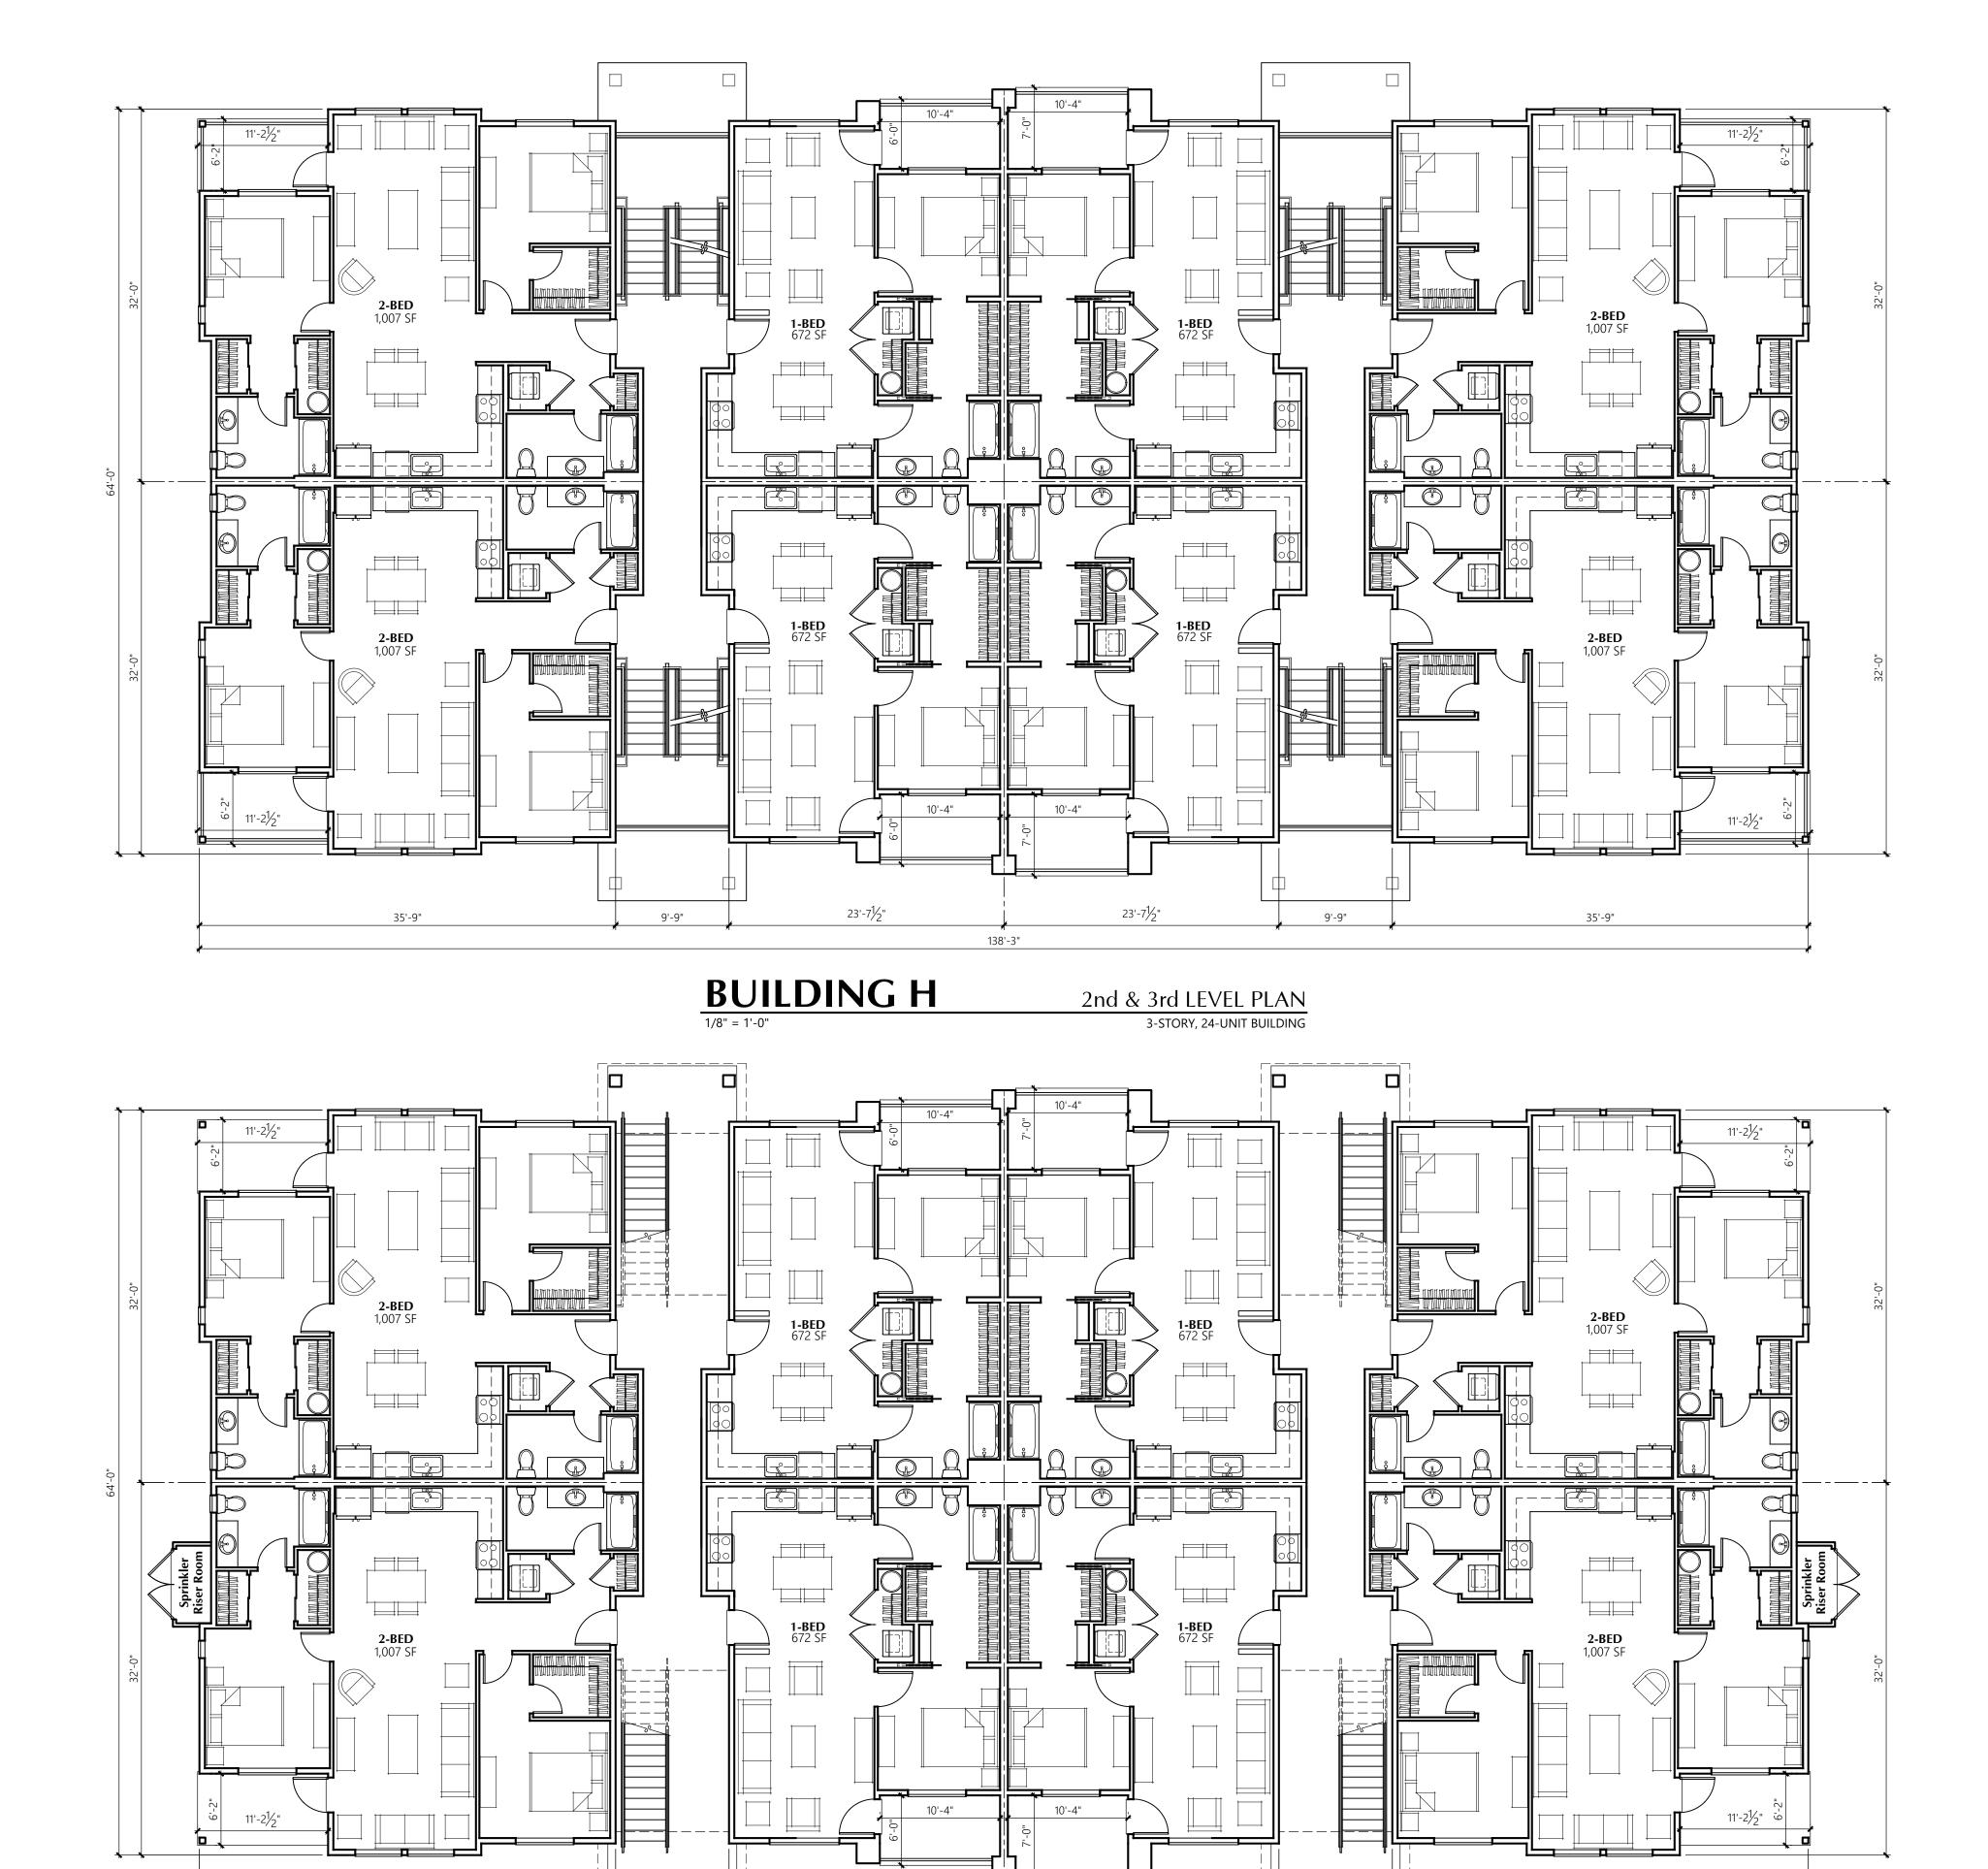



Timberlane Partners

9'-9"

35'-9"

Building H Building Floor Plans

23'-7¹/₂"

1st LEVEL PLAN 3-STORY, 24-UNIT BUILDING


23'-71/2"


BUILDING H
1/8" = 1'-0"


2-6-2023 APT/HDM Drawn By: 2306


35'-9"

A12 Sheet No.:

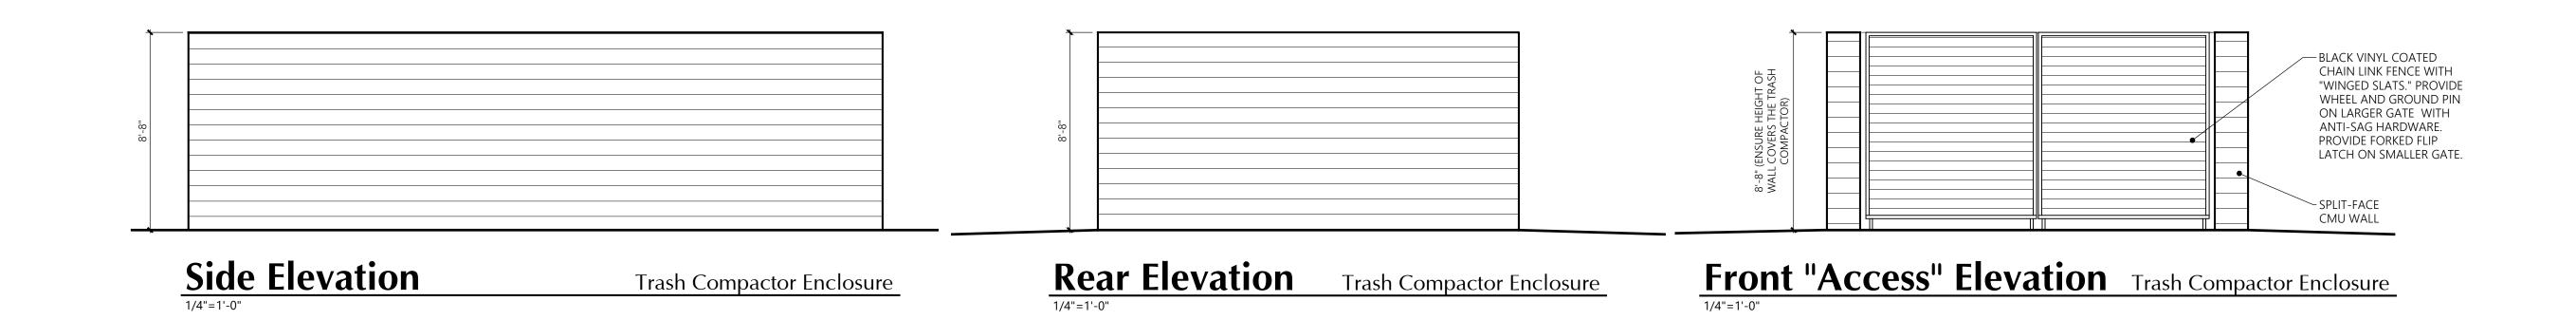

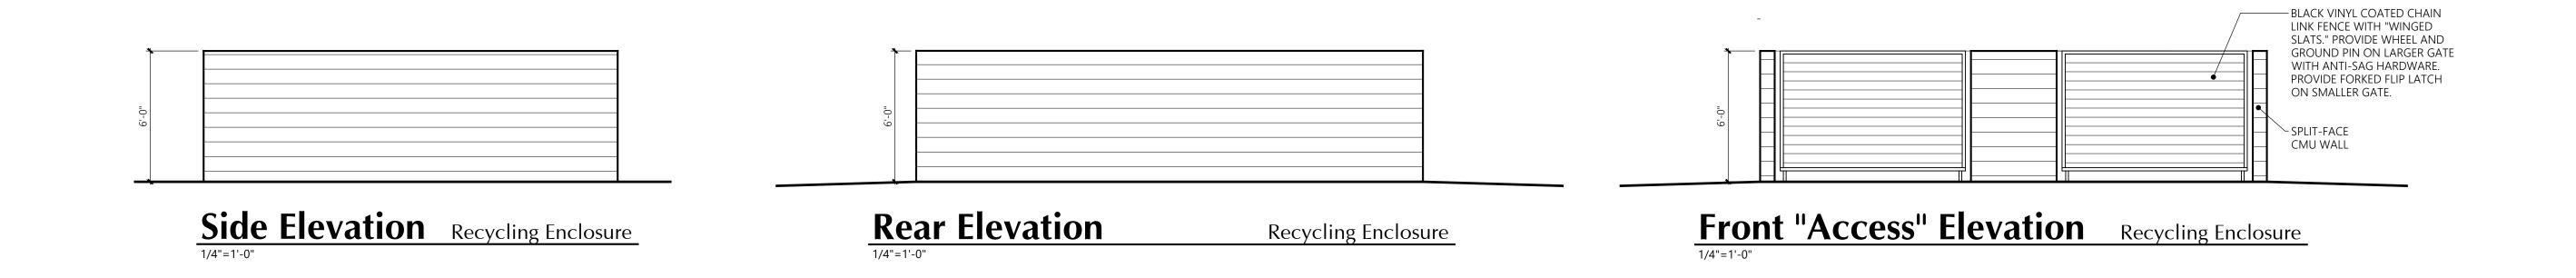

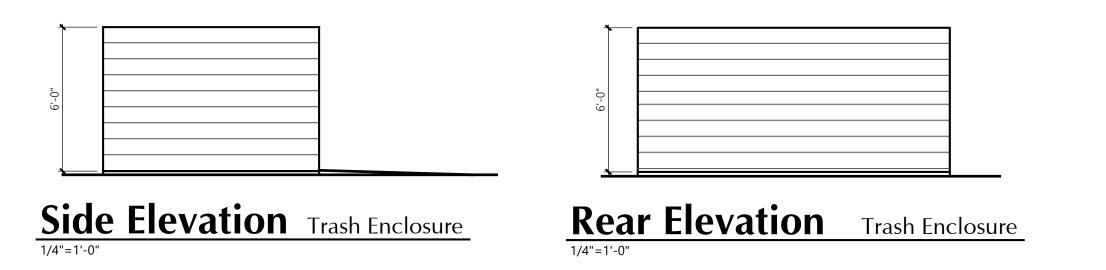

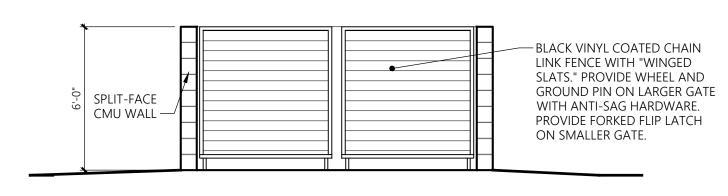

Front "Access" Elevation Trash Enclosure



Timberlane Partners

Trash & Recycling Enclosures **Elevations**

3-28-2023
SV
2306

A13









ARCHITECTS

Bradley Heights Apartments Puyallup, Washington

Timberlane Partners

High Quality Material Diagrams Clubhouse and Buldings C, G, & H

3-28-2023 Date: APT/HDM Drawn By: 2306 Job No.:

A14 Sheet No.:

Color Scheme 1





Color Scheme 2




- (A) ACCENT TRIM & DOORS INKWELL SW 6992
- D BODY 3 FIBER CEMENT LAP SIDING PURE WHITE SW7005
- B BODY 1 FIBER CEMENT LAP SIDING NAVAL SW6244
 - E BODY 4 FIBER CEMENT LAP SIDING MARCH WIND SW7668
- (C) BODY 2 THRU-COLOR FIBER CEMENT PANEL SIDING EQUITONE PICTURA PG444 OR EQUIVELENT
- (F) BASE BRICK VENEER TUNDRABRICK - CHALK DUST OR EQUIVELENT



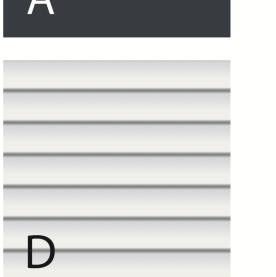


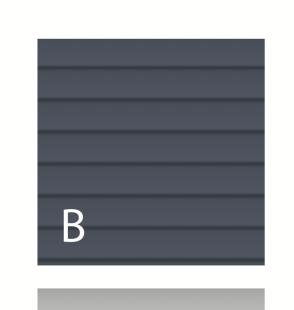


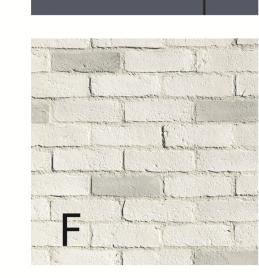


- A ACCENT TRIM & DOORS INKWELL SW6992
- D BODY 3 FIBER CEMENT LAP SIDING PURE WHITE SW7005
- B BODY 1 FIBER CEMENT LAP SIDING ROSEMARY SW6187
- E BODY 4 FIBER CEMENT LAP SIDING MARCH WIND SW7668
- (C) BODY 2 THRU-COLOR FIBER CEMENT PANEL SIDING EQUITONE NATURA N211 OR EQUIVELENT
- F BASE BRICK VENEER TUNDRABRICK - CHALK DUST OR EQUIVELENT



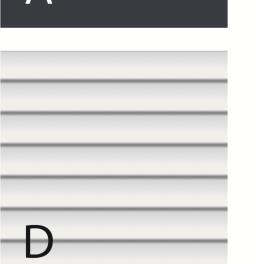

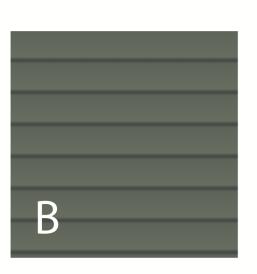



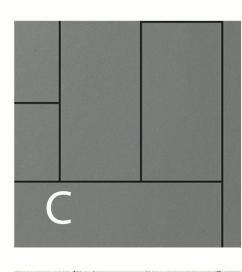



MILBRANDT

ARCHITECTS


Bradley Heights Apartments Puyallup, Washington


Timberlane Partners

Material & Color Scheme Legend

Date:	
Drawn By:	APT/HDN
Job No.:	230

A15

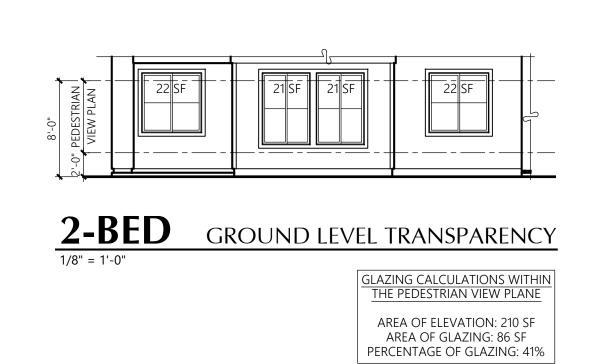

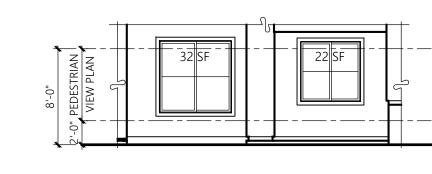

1-BED GROUND LEVEL TRANSPARENCY

GLAZING CALCULATIONS WITHIN THE PEDESTRIAN VIEW PLANE AREA OF ELEVATION: 142 SF AREA OF GLAZING: 54 SF PERCENTAGE OF GLAZING: 38%



CLUBHOUSE

1/8" = 1'-0"

GROUND LEVEL TRANSPARENCY

GLAZING CALCULATIONS WITHIN THE PEDESTRIAN VIEW PLANE AREA OF ELEVATION: 690 SF AREA OF GLAZING: 304 SF PERCENTAGE OF GLAZING: 44%



Bradley Heights Apartments

Puyallup, Washington

Timberlane Partners

Ground Level Transparency

Drawn By: Clubhouse, 1-Bed, and 2-Bed

3-28-2023 Date: APT/HDM 2306

A16 Sheet No.:











Timberlane Partners

Building A Elevations and Perspectives 2306

P1











Timberlane Partners

Building B Elevations and Perspectives 2306

P2







Timberlane Partners

Building C
Elevations and Perspectives

 Date:
 APT/HDM

 Job No.:
 2306

P3
Sheet No.:







Timberlane Partners

Building C Elevations and Perspectives 2306

P4 Sheet No.:







Timberlane Partners

Building D

2306

P5 Sheet No.:





Timberlane Partners

Building D Elevations and Perspectives 2306

P6 Sheet No.:

PERSPECTIVE FROM

SOUTH-WEST CORNER











ARCHITECTS

Bradley Heights Apartments

Timberlane Partners Puyallup, Washington

Building E Elevations and Perspectives 2306

P7 Sheet No.:











Date:	
Drawn By:	APT/HDM
Job No.:	2306







ARCHITECTS

Bradley Heights Apartments
Puyallup, Washington

Timberlane Partners

Building G
Elevations and Perspectives

Date:

Drawn By: APT/HDM

Job No.: 2306

P9 Sheet No.:









Timberlane Partners

Building G
Elevations and Perspectives


 Date:
 APT/HDM

 Job No.:
 2306

P10 Sheet No.:





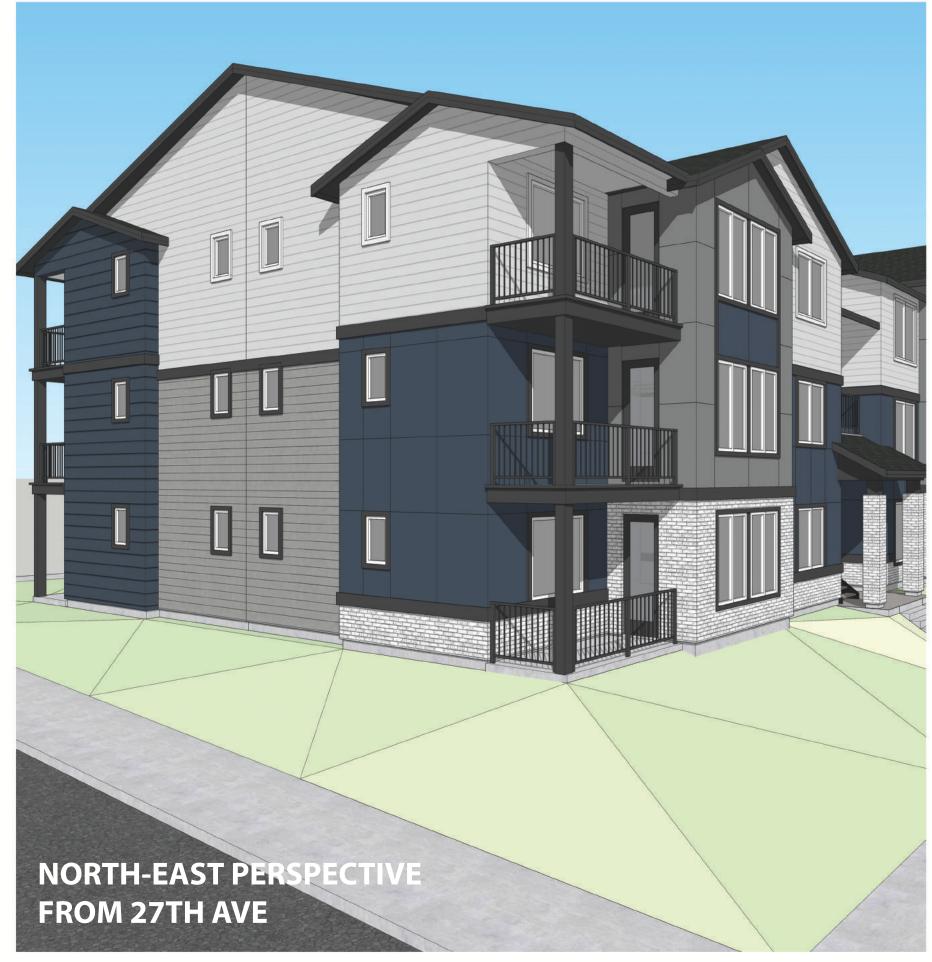





ARCHITECTS

Bradley Heights Apartments

Puyallup, Washington

Building H Elevations and Perspectives 2306

P11







Timberlane Partners

Clubhouse **Elevations and Perspectives** 2306

P12





Puyallup, Washington

Timberlane Partners

Clubhouse
Elevations and Perspectives

 Date:
 APT/HDM

 Job No.:
 2306

P13
Sheet No.:

NORTH-EAST PERSPECTIVE

FROM 27TH AVE









Timberlane Partners

Clubhouse **Elevations and Perspectives** 2306

P14




PLANT SCHEDULE			
TREES	BOTANICAL / COMMON NAME	SIZE	QTY
(·)	Acer circinatum Vine Maple or similar native	1" Cal. Min. Well Formed	
	Acer palmatum 'Bloodgood' Bloodgood Japanese Maple or similar Japanese Maple	1" Cal. Min. Well Formed	
· · · · · · · · · · · · · · · · · · ·	Acer platanoides 'Crimson Sentry' Crimson Sentry Norway Maple or similar	1" Cal. Min. Well Formed	
	Cercidiphyllum japonicum 'Red Fox' Red Fox Katsura Tree or similar	1" Cal. Min. Well Formed	
	Laegerstromia indica 'Tuscorora' Tuscan (Red) Crape Myrtle	1" Cal. Min. Well Formed	
	Chamaecyparis nootkatensis 'Pendula' Weeping Nootka Cypress or similar weeping conifer	6` Ht. Min. Full/ Compact	
CONTRACTOR OF THE PARTY OF THE	Chamaecyparis obtusa Hinoki False Cypress or similar	6` Ht. Min. Full/ Compact	
	Ginkgo biloba 'Autumn Gold' TM Autumn Gold Maidenhair Tree or similar canopy tree	1.5" Cal.	

\odot	Oxydendrum arboreum Sourwood Tree or similar	1.5" Cal. Min. Well Formed	
\odot	Picea glauca 'Pendula' Weeping White Spruce or similar weeping, columnar conifer	6` Ht. Min. Full/ Compact	
The state of the s	Picea omorika Serbian Spruce or similar	6` Ht. Min. Full/ Compact	
	Pinus contorta Shore Pine or similar native conifer	6` Ht. Min. Full/ Compact	
	Rhamnus purshiana Cascara or similar native tree	1" Cal. Min. Well Formed	
$\overline{}$	Thuja occidentalis 'Smaragd' Emerald Green Arborvitae or similar screening shrub 4' O.C.	6` Ht. Min. Full/ Compact	
0	Tsuga mertensiana Mountain Hemlock or similar native conifer	6` Ht. Min. Full/ Compact	
	Park Bench - Owner's Choice - commercial grade	6' long	9

POTENTIAL OPEN SPACE USES:

- 1. PICKLEBALL COURTS
- 2. BARBEQUE AREAS
- 3. QUIET GAZEBO / GARDEN SPACES
- 4. OPEN GRASSY PLAY AREAS
- 5. DOG PARK
- 6. GATHERING SPACE




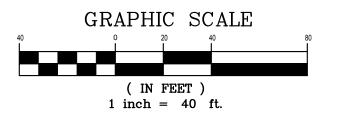

LANDSCAPE AREAS KEAY MAP




BUILDING LANDSACPING: 4' WIDTH SHRUB/GROUNDCOVER **BUFFER AND LAWN**

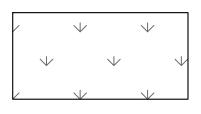


OPEN SPACE LANDSCAPING: LAWN SEED MIX



PARKING LOT LANDSCAPING: TYPE IV ISLANDS

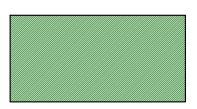

PERIMETER LANDSCAPING

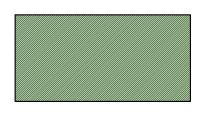

STREET TREES: STREET TREES AND LAWN




Landscape Architecture 253.460.6067

ARTMEN EY HEIGHTS
202 27TH A
PUYALLUP, 1

F. REVISED SITE LAYOUT

E. REVISED PER CITY COMMENTS

DRAWING ISSUED FOR: **AGENCY REVIEW DATE:** MARCH 31, 2023

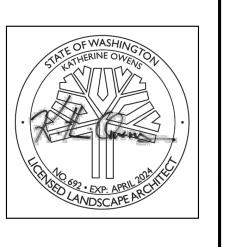

21140

1:1

1:40

21140LSF KLO KLO ARCH

PROJECT NO: FILE NAME: DRAWN BY: CHECKED BY: X-REFS:

PLOT SCALE: DRAWING SCALES:

DRAWING CONTENTS

CONCEPTUAL LANDSCAPE PLANTING PLAN, **NOTES & DETAILS**

DRAWING NO.:

1 OF 3

ORIG. SHEET SIZE 22X34

GENERAL LANDSCAPE NOTES

- 1. Contractor is responsible for obtaining all necessary permits from the appropriate agency prior to commencing work. Contractor shall contact Line Locators (811) a min. of 48 hours prior to any digging or trenching. If there are any discrepancies with existing lines and landscaping, it is the contractor's responsibility to contact the landscape architect and request a site visit to address the conflicts. Contractor shall comply and conform to any and all local and state codes for work, schedules and any other project related requirements.
- 2. Contractor shall coordinate directly with the landscape architect for all landscape related issues, concerns, inspections and approvals. Contractor shall provide the landscape architect with a written request for a site visit to address any related items.
- 3. Scope of work shall include any and all specified and unspecified but related incidental work to achieve the design indicated on the landscape plans. All labor, materials, subcontractors, equipment, and related incidental items shall be supplied and installed to achieve a complete project, unless directed otherwise by the general contractor or landscape architect.
- 4. Contractor to verify all sub grades are set below required amendments to insure the finished grade will match what is intended by civil or drainage design. All sub grades and finished or final grades shall be graded to drain to the designed drainage system with positive drainage away from all
- 5. Grade Preparation BASED ON VEGETATIVE MANGAGEMENT STANDARDS REQUIREMENTS:
- a. Slopes used for grass plantings or turf shall be less than 3:1 or 33 percent. Otherwise plantings should not require mechanized mowing equipment.

Soil Preparation.

- a. Excavate soil Excavate existing soil to a depth of 24" (or equal to the root ball depth, whichever is greater) and width of 8' (or three times (3X) wider than the root ball or root mass, whichever is greater). Stockpile excavated soil on a tarp away from the street and storm water catch
- b. Prepare the planting strip -After excavating all materials from the planter strip, scarify and rip the sub-base (by mechanical means or hand tools) to a depth of 6" with multiple passes, 90 degrees to each Prior to planting the tree, re-compact the tree base where the street tree will be planted to avoid setting of the root ball. At this stage, if the tree is to be planted when the planter strip is backfilled with amended top soil, the contractor/installer should measure the depth of the root bal I to determine when to place the tree in the pit during the backfilling process. If the root ball or root mass (in the case of bare root trees) is less than 24", the street tree shall be planted in a manner in which the root flare is level with or at least 1" above grade at the time of finished planting. This may require the root ball be placed on a compacted sub-base of the compost amended top soil as backfilling is occurring,
- c. Install root barrier panels at this stage the contractor/installer shall place 24" deep root barrier panels (UB-24) along the edge of the sidewalk and curb line for a total of eight feet (8') of lineal protection along either side of the planting area. The panels shall be installed perpendicular to the edge of paved surface in accordance with the manufacturer's standards for a 'linear' application; the root barrier panels shall not be installed in the planting pit as a 'surround' application, unless specified on the final landscape plans. The top of the root barrier panel shall be installed such that ½" of the root barrier is above the finished grade.
- d. Compost amended top soils required The top soil shall be amended on site during installation with compost to achieve a 40 percent by volume top soil mix in the right-of-way planter strip. Imported top soil may be used by the contractor/installer if data 'cut sheets' are available from the supplier certifying compost amendment equaling 40 percent by volume using one of the approved compost sources below. Compost shall only be sourced from:
- Cascade Compost (also known as PREP/LRI) (available through Pierce County Recycling, Composting & Disposal, 10308 Sales Road, Tacoma, Washington 98499, or retail/wholesale landscape material suppliers) Tagro Compost Mix - available through City of Tacoma, 2201 Portland Avenue, Gate 6, Tacoma, WA, 98421, or retail/wholesale
- landscape material suppliers)
- Cedar Grove Compost (available through Cedar Grove Compost, 17825 Cedar Grove Road S.E., Maple Valley, 98038, or retail/wholesale landscape material suppliers)
- e. Install and amend top soils To avoid stratified layers, first place seven inches (7") of approved top soil in the prepared/scarified planting strip area and mechanically till in five inches (5") of approved compost; follow this procedure twice to achieve the total 24" top soil depth. Finished grade of top soil should be 1/2" below the edge of sidewalk to allow the root barrier panel to be properly installed above finished grade.
- f. Install tree stakes and finish mulch Placement of four inches (4") of wood chip mulch, water basin rings, tree staking and temporary irrigation bags (where required) shall follow city standard #01.02.07.\


Mulching of Newly Planted or Replanted Areas.


and minimizing erosion.


- In a planter strip which already exists and a new street tree shall be installed, the following procedures shall be followed to achieve a top soil mix with 40 percent compost by volume
- a. Mulches must be applied to the following depths: a minimum 4 (four) inches over bare soil, and two inches where plant materials will
- b. Mulches must include organic materials, organic compost mulch material or wood chips over a properly cleaned, amended and graded
- c. Nonporous materials, such as plastic sheeting, shall not be used in any area of the landscape because of down-slope erosion and
- potential soil contamination from herbicide washing. d. Mulch should be applied regularly to and maintained in all planting areas to assist soils in retaining moisture, reducing weed growth,
- Contractor shall field layout all plant material and contact the landscape architect for a site visit to approve the layout. Any field modifications shall be done by the landscape architect prior to planting.
- Contractor shall immediately notify the landscape architect of any poor drainage condition in landscape areas. No standing water shall be permitted in any landscape areas - either on the surface or below the topsoil. The landscape architect shall coordinate the drainage solution with the general contractor and civil engineer. Once the concerns have been remedied planting shall commence.
- All groundcover to be planted in a triangular spacing formation, equal in all directions to the centers of the groundcovers in distances indicated in the legend. Contractor shall verify all quantities of groundcovers by area calculations and spacing requirements.
- 10. Landscaping is to be per plan. Plant substitutions due to availability or otherwise will be allowed only with landscape architect, owner and agency approval. Any substitutions will be with material of similar size, growth characteristics, and quality.
- 11. All trees must be staked as necessary so as to maintain material in a healthy, vigorous growing condition.
- 12. Landscaping shall be installed in a professional workmanlike manner that is consistent and accepted throughout the industry. All landscape and irrigation work shall be performed by experienced persons familiar with scope of project.
- 13. All landscape material and labor is to be guaranteed for a period of one full year from the time of completion.
- 14. When planting 'Balled and Burlapped' product, remove all burlap, string & wire from any B&B plant material, cut and remove jute strings. Gently


place in tact Rootbal into planting pit. If rootball breaks or is not solid - the plant is unacceptable and shall be replaced.

- 15. Street trees shall have caliper size of at least 1" measure per American Association of Nurserymen Standards for Deciduous Trees Plant sizes:
- 5' Minimum height for Evergreen trees; 2 Gal. Min. for shrubs.
- 16. Street trees shall be high branching with canopy that starts at least 6' above finish grade.
- 17. All plant I.D. tags are to remain on the plant material until final inspection has been completed. Once approved all plant I.D. tags shall be removed and discarded appropriately.
- 18. Trees shall be cared for in accordance with the American National Standards Institute (ANSI) standard practices for trees, shrubs and other woody plant maintenance (ANSI 300) in order to allow them to reach there mature height and form.
- 19. Pruning of street trees shall be performed per the ANSI 300 standards so as to maintain the natural form of the tree, encourage vigorous growth to a mature spread and height, and avoid weakening the tree to create a hazard. Street trees shall not be topped pollarded, or otherwise pruned in a manner contrary to these goals, unless there is no practicable alternative that would preserve essential utility services.
- 20. Plant material selected is drought tolerant or native species. The project proponent shall be responsible for maintaining and watering all plant material throughout the first growing season and in times of drought. A Permanent Irrigation system will be designed upon approval of preliminary landscape plan.
- 21. All landscaping strips and islands internal to the site as paved areas/parking lots shall be designed and installed using a minimum of 1.5 (18) of top soil depth; Subsoils below the topsoil layer shall be scarified at least 6 inches with some incorporation of the upper material to avoid stratified layers.
- 22. A minimum of eight (8) inches of top soil, containing ten percent dry weight in planting beds, and 5% organic mater content in turf areas, and a pH from 6.0 to 8.0 or matching the pH of the original undisturbed soil. The topsoil layer shall have a minimum depth of eight (8) inches except where tree roots limit the depth of incorporation of amendments needed to meet the criteria. Subsoils below the topsoil layer should be scarified at least six (6) inches with some incorporation of the upper material to avoid the stratified layers, where feasible. Installation of the eight (8) inches of top soil, as described above, shall generally be achieved by placing five (5) (sub-base scarified four (4) inches) with a three (3) inch layer of compost tilled into the entire depth.

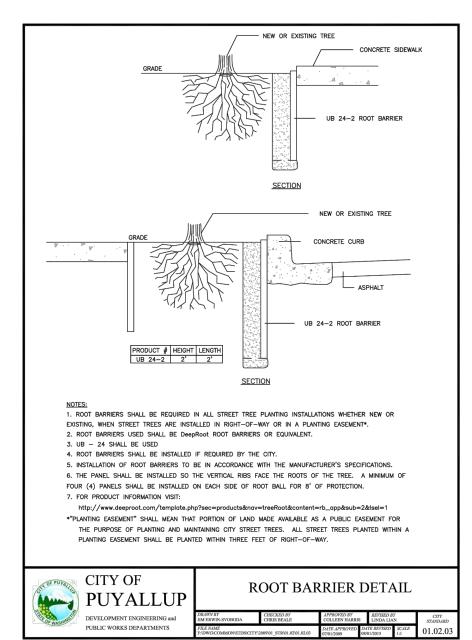

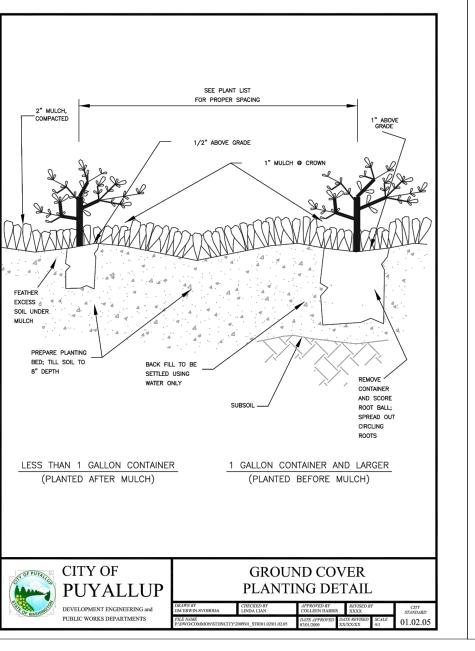

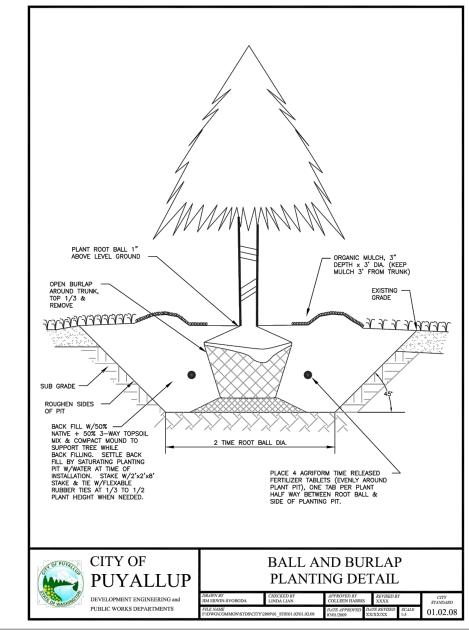

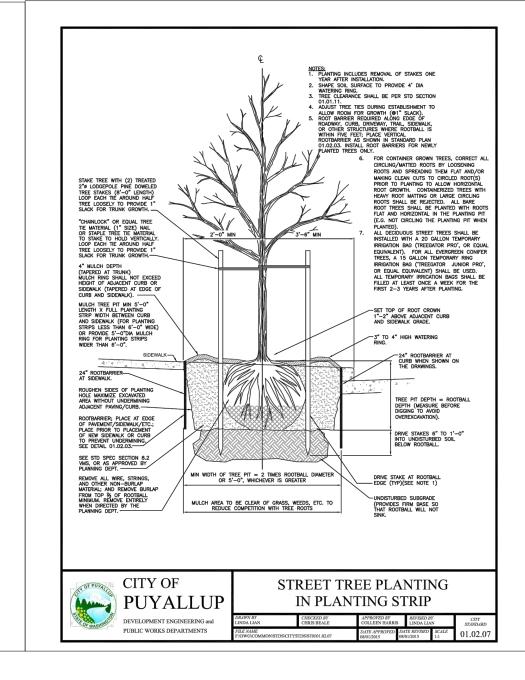



Aì AVF HEIGHT 2 27TH PUYALLUF ${\mathcal O}$

ADI

REVISIONS:

F. REVISED SITE LAYOUT

E. REVISED PER CITY COMMENTS

DRAWING ISSUED FOR:

AGENCY REVIEW

DATE: MARCH 31, 2023




PROJECT NO: 21140 FILE NAME: 21140LSF DRAWN BY: CHECKED BY: ARCH X-REFS: PLOT SCALE: DRAWING SCALES:

KLO


DRAWING CONTENTS

LANDSCAPE **NOTES & DETAILS**

DRAWING NO .:

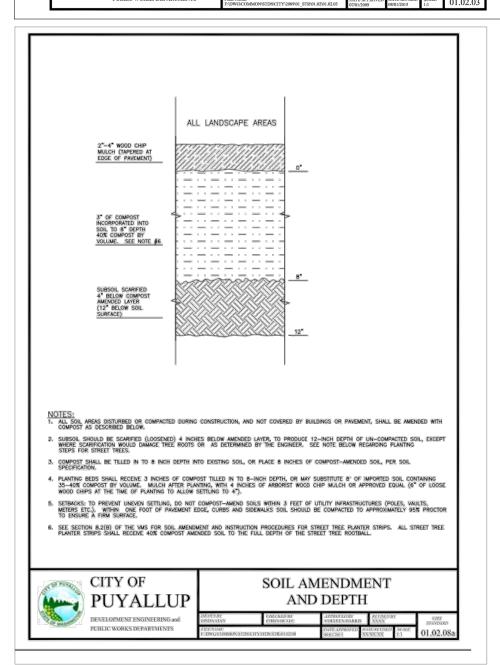

Know what's below. Call before you dig.

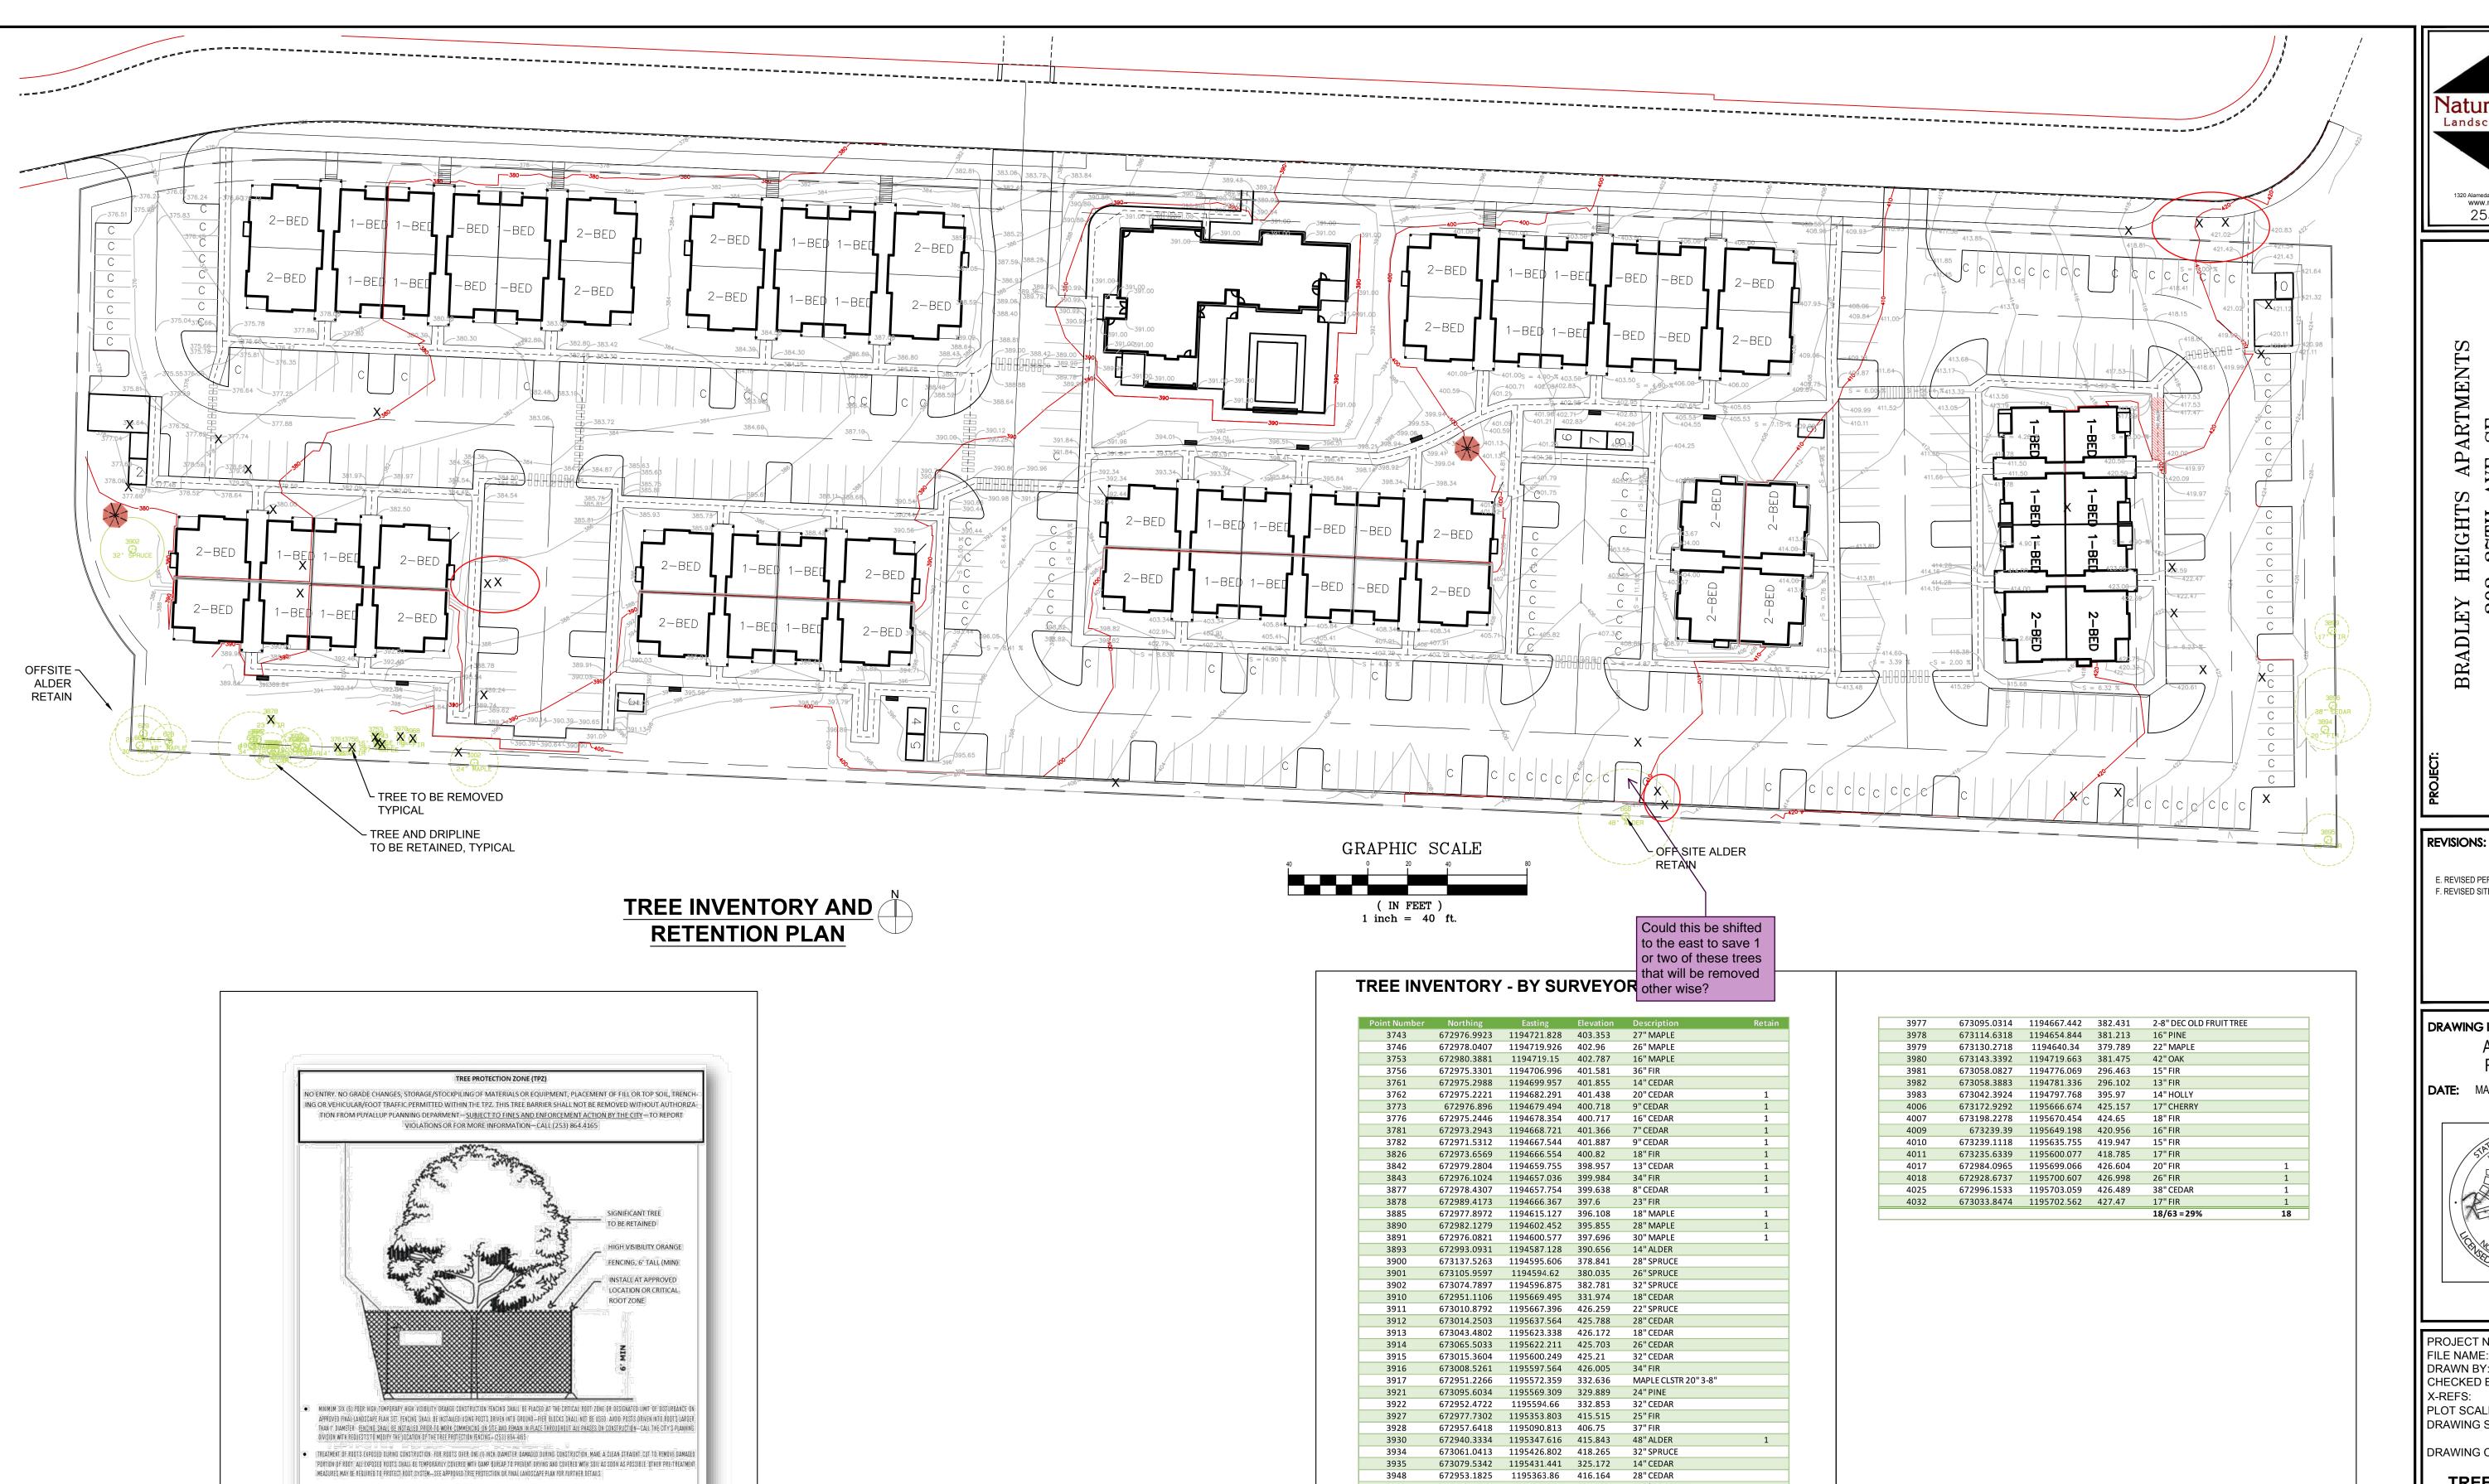

Know what's below.

Call before you dig.

NO STOCKPLING OF MATERIALS, VEHICULAR TRAFFIC PLACEMENT OF FOP SOIL OF FILL MATERIAL, STORAGE OF EQUIPMENT OR MACHINERY SHALL BE ALLOWED WITHIN THE LIMITS OF THE

THE ABOVE REFERENCED TPZ SIGNS SHALL BE PLACED EVERY IS FEET ALONG THE FENCING AND SHALL REMAIN IN PLACE THROUGHOUT ALL PHASES OF CONSTRUCTION

TREE PROTECTION FENCING DETAIL

(for public and private trees)

THE SUPERVISION OF THE ON-SITE: | ARBORIST WITH PRIOR WRITTEN APPROVAL BY THE SITY PLANNING DIVISION

ESTABLISHED FENCING, FENCING SHALL NOT BE MOVED OR REMOVED UNLESS APPROVED, BY THE CITY PLANNING DIVISION, WORK WHITIN PROTECTION FENCE SHALL BE ODNE MANUALLY UNDER

672946.9387 1195366.463 416.722 20"/12" CEDAR 672967.4054 1194768.746 405.67 24"MAPLE 3963 672972.6863 1194760.794 403.252 38"FIR 672979.5851 1194737.784 402.207 9"FIR 672980.6241 1194731.753 402.607 6"HOLLY 673001.4972 1194773.146 399.999 22"SPRUCE 673052.9679 1194680.974 386.639 6"HOLLY 3974 673066.5627 1194682.074 385.718 16"DEC 3976 673041.8863 1194650.426 387.428 24" FIR



ARTMEN EY HEIGHTS 202 27TH PUYALLUP

E. REVISED PER CITY COMMENTS F. REVISED SITE LAYOUT

DRAWING ISSUED FOR: **AGENCY REVIEW**

DATE: MARCH 31, 2023



PROJECT NO: 21140LSF FILE NAME: DRAWN BY: CHECKED BY: X-REFS: PLOT SCALE: DRAWING SCALES:

DRAWING CONTENTS

TREE INVENTORY AND RETENTION PLAN

KLO

ARCH

1:1

1:40

DRAWING NO.:

3 OF 3

ORIG. SHEET SIZE 22X34