



GENERAL PLAN NOTES

1000 university ave. w. suite ≥ 30 st. paul, minnesota 55104 612-252-4820

I hereby certify that this document was prepared by me or under my direct supervision

and that I am a duly licensed architect under the laws of the State of Washington

> Dawn Wieczorek Typed or Printed Name

11192 License # Date

MX-DRO SUBMITTAL APRIL 1, 2023

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REVISIONS


2108 PROJECT NUMBER

Checker Author CHECKED BY DRAWN BY WESLEY BRADLEY PARK 2

EAST BROWNSTONE

GARAGE LEVEL OVERALL PLANS

10' - 0"

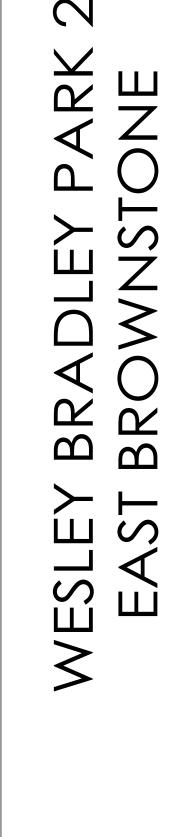

in • site architects

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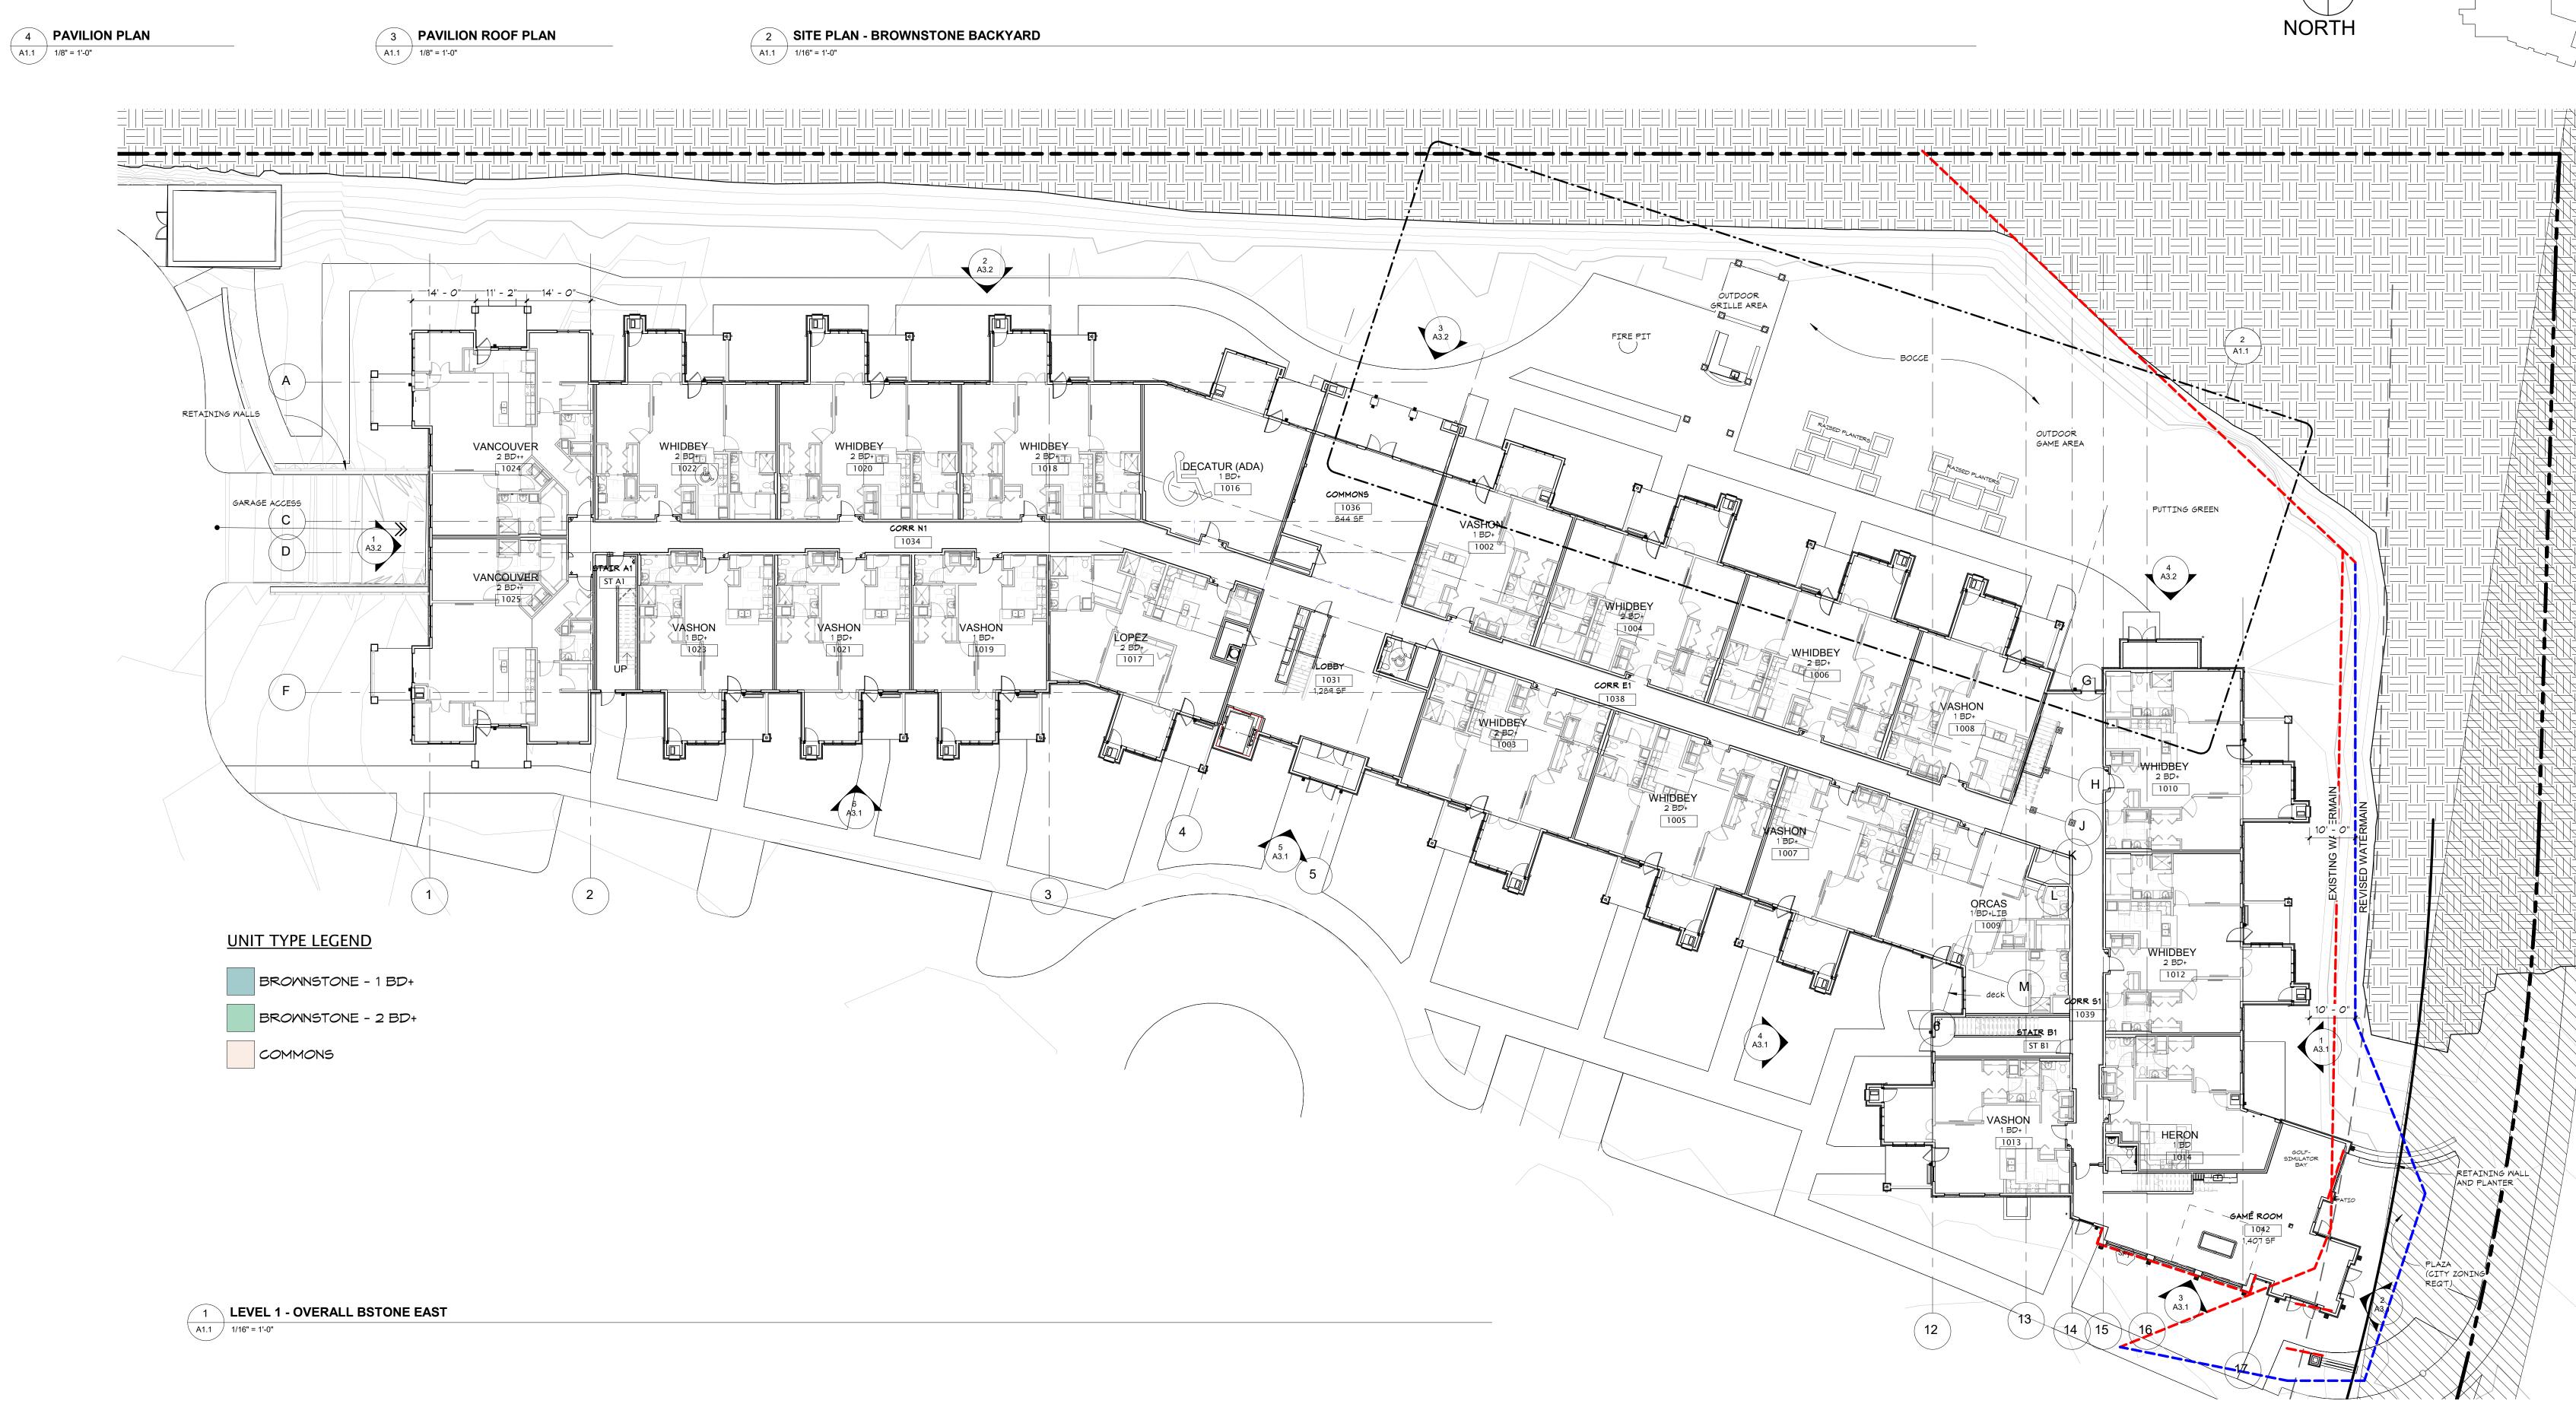
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WESLEY BRADLEY PARK 2
EAST BROWNSTONE

FIRST LEVEL OVERALL PLAN - BROWNSTONE B

A1.1





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WESLEY BRADLEY PARK 2 EAST BROWNSTONE

SECOND LEVEL OVERALL FLOOR PLANS

A1.2



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WESLEY BRADLEY PARK EAST BROWNSTONE

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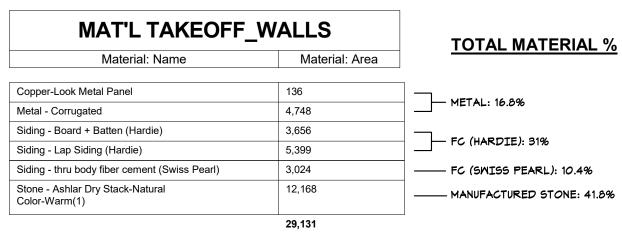
EAST BROWNSTONE

JDK Checker
DRAWN BY CHECKED BY

WESLEY BRADLEY PARK 2

EXTERIOR ELEVATIONS -BROWNSTONE EAST

43.1



PMC 20.52.025 (2)a = NOT COMPLIANT DUE TO ALLOWED STANDALONE SENIOR HOUSING USE/NO RETAIL

PMC 20.52.025 (2)B = GROUND FLOOR TRANSPARENCY @ STREET:

305'-4" LF @ 39TH AVE (INCLUDES RETURN OF BUILDING AT ENTRY DUE TO MAJOR VISIBLE EXPOSURE FROM THE STREET)
NOTE: ALL WINDOWS MEET THE 2' SILL AND 8' HEAD REQUIREMENT,
THEREFORE CALCULATIONS ARE DONE AS LF IN LIEU OF SF.

WINDOW LF:

WHIDBEY UNIT 1010: 27'-4"

WHIDBEY UNIT 1012: 27'-4"

HERON UNIT 1014: 11'-6"

GAMEROOM (STOREFRONT WDWS/DOORS): 54'

TOTAL: 120'-2" LF (39.4% TRANSPARENCY)

MAT'L TAKEOFF_		<u>LEVEL 1 MATERIAL %</u>		
Material: Name	Material: Area			(A3.2)
Copper-Look Metal Panel	136	¬		1
Metal - Corrugated	1,833	METAL: 14% ———————————————————————————————————	MIN 60% COVERAGE BY HIGH QUALITY (68%) - <b>COMPLIANT</b>	
Siding - Board + Batten (Hardie)	194		PER PMC 25.52.025 (6)	
Siding - Lap Siding (Hardie)	4,326	FC (HARDIE): 32%	_	(A3.1) 6
Siding - thru body fiber cement (Swiss Pearl)	0	FC (SMISS PEARL): 0%	MIN 30% COVERAGE BY 2 MATERIALS - <b>COMPLIANT</b>	
Stone - Ashlar Dry Stack-Natural Color-Warm(1)	7,625	MANUFACTURED STONE: 54%	PER PMC 25.52.025 (6)	2 (A3.2)
	14,114			
MAT'L TAKEOFF_  Material: Name	_WALLS  Material: Area	LEVEL 2 MATERIAL %		
Material: Name	Material: Area	LEVEL 2 MATERIAL %		A3.1 5
Material: Name  Copper-Look Metal Panel	Material: Area	LEVEL 2 MATERIAL %	NIN 60% COVERAGE BY	A3.1 5
Material: Name  Copper-Look Metal Panel  Metal - Corrugated	Material: Area  0 2,915		HIGH QUALITY (70%) - COMPLIANT	A3.1 5
Material: Name  Copper-Look Metal Panel  Metal - Corrugated  Siding - Board + Batten (Hardie)	Material: Area  0 2,915 3,462			A3.1 5
Material: Name  Copper-Look Metal Panel  Metal - Corrugated  Siding - Board + Batten (Hardie)  Siding - Lap Siding (Hardie)	Material: Area  0 2,915 3,462 1,073	METAL: 20%  ———————————————————————————————————	HIGH QUALITY (70%) - COMPLIANT PER PMC 25.52.025 (6)	
Material: Name  Copper-Look Metal Panel  Metal - Corrugated  Siding - Board + Batten (Hardie)  Siding - Lap Siding (Hardie)  Siding - thru body fiber cement (Swiss Pearl)	Material: Area  0 2,915 3,462 1,073 3,024	— METAL: 20%  — FC (HARDIE): 30%  — FC (SMISS PEARL): 20%	HIGH QUALITY (70%) - COMPLIANT PER PMC 25.52.025 (6)  MIN 30% COVERAGE BY 2 MATERIALS - COMPLIANT	3 A3.2
Material: Name  Copper-Look Metal Panel  Metal - Corrugated  Siding - Board + Batten (Hardie)  Siding - Lap Siding (Hardie)	Material: Area  0 2,915 3,462 1,073	METAL: 20%  ———————————————————————————————————	HIGH QUALITY (70%) - COMPLIANT PER PMC 25.52.025 (6)  MIN 30% COVERAGE BY	
Material: Name  Copper-Look Metal Panel  Metal - Corrugated  Siding - Board + Batten (Hardie)  Siding - Lap Siding (Hardie)  Siding - thru body fiber cement (Swiss Pearl)  Stone - Ashlar Dry Stack-Natural	Material: Area  0 2,915 3,462 1,073 3,024	— METAL: 20%  — FC (HARDIE): 30%  — FC (SMISS PEARL): 20%	HIGH QUALITY (70%) - COMPLIANT PER PMC 25.52.025 (6)  MIN 30% COVERAGE BY 2 MATERIALS - COMPLIANT	3 A3.2
Material: Name  Copper-Look Metal Panel  Metal - Corrugated  Siding - Board + Batten (Hardie)  Siding - Lap Siding (Hardie)  Siding - thru body fiber cement (Swiss Pearl)  Stone - Ashlar Dry Stack-Natural	Material: Area  0 2,915 3,462 1,073 3,024 4,543	— METAL: 20%  — FC (HARDIE): 30%  — FC (SMISS PEARL): 20%	HIGH QUALITY (70%) - COMPLIANT PER PMC 25.52.025 (6)  MIN 30% COVERAGE BY 2 MATERIALS - COMPLIANT	3 A3.2
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TRUSS BEARING
121'-0"

LEVEL 2- EAST
111'-0"

LEVEL 1- EAST
100'-0"

ONDUCTOR HEAD AND DOWNSPOUT

4 EXTERIOR ELEVATION - EAST SIDE (SOUTH END @ GRID 10)

A3.2 1/8" = 1'-0"

TYPICAL FINISHES AT UNIT EXTERIOR

5 CAMPUS ENTRY VIEW


3 EXTERIOR ELEVATION - EAST SIDE (SOUTH END)

A3.2 1/8" = 1'-0"

A3.2-B / NTS



1" = 80'-0"

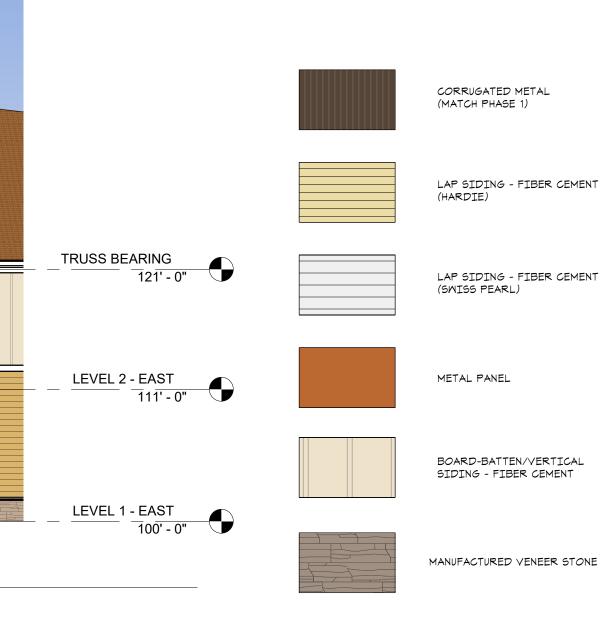

NOTE: ALL WINDOWS EXCEPT IN STONE AREAS RECEIVE 2" MIN TRIM

NOTE: ALL WINDOWS EXCEPT IN STO RECEIVE 2" MIN TRIM



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NORTH

BRADLEY PARK 2 3ROWNSTONE

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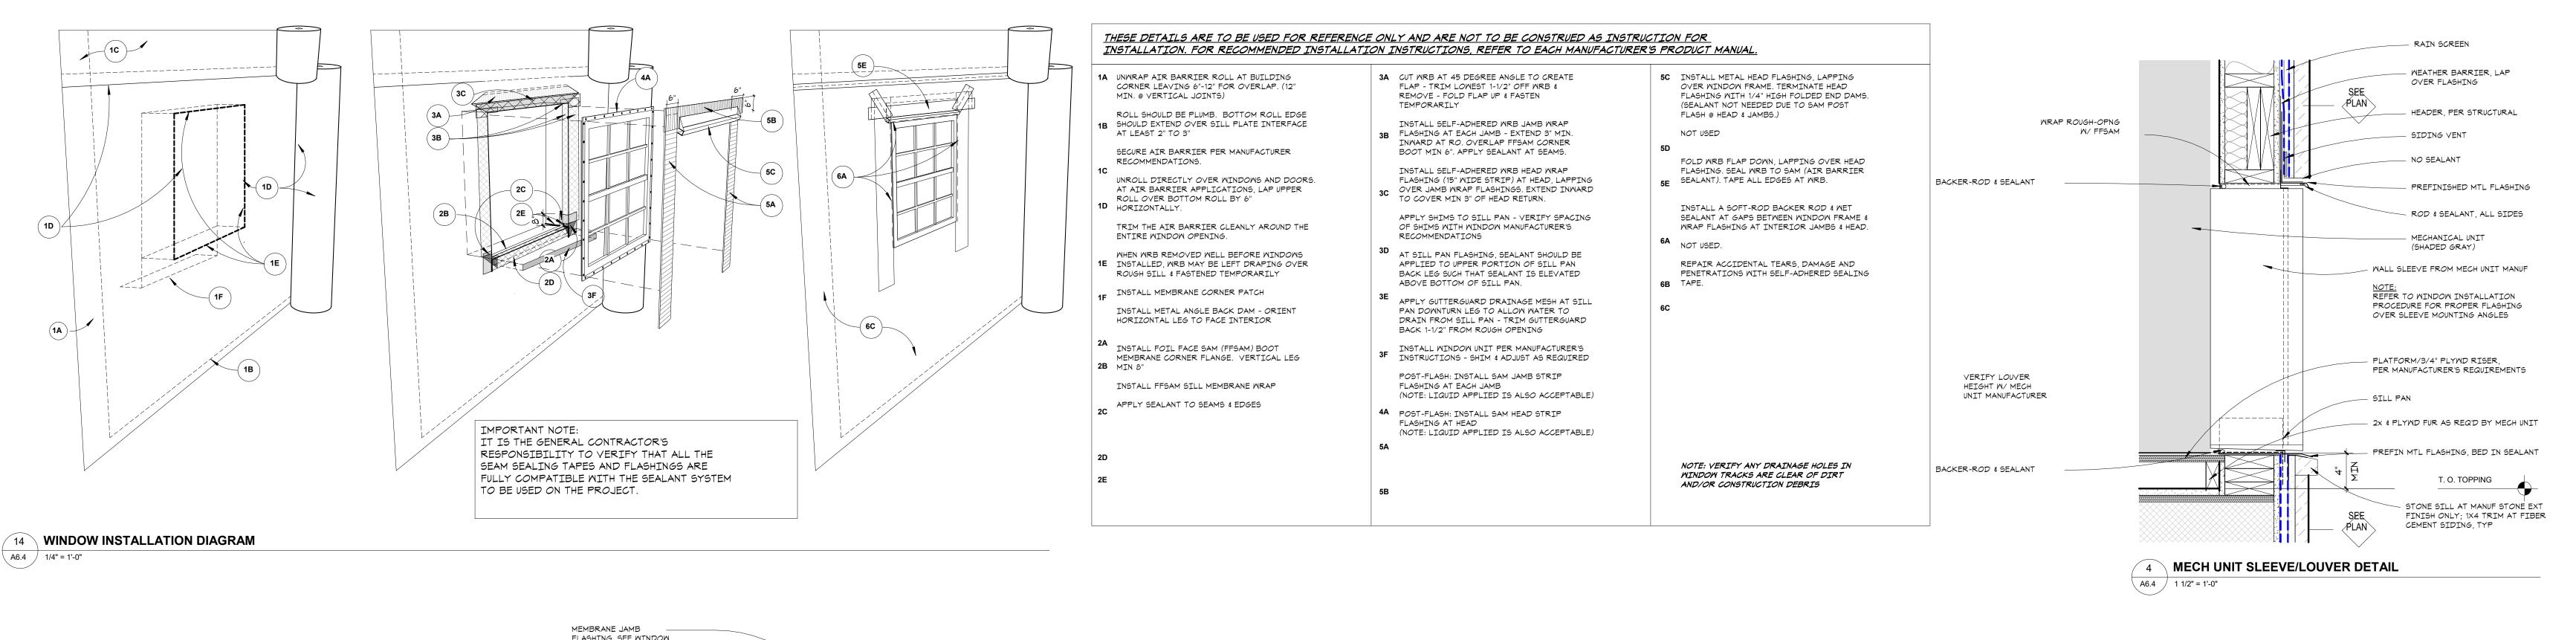
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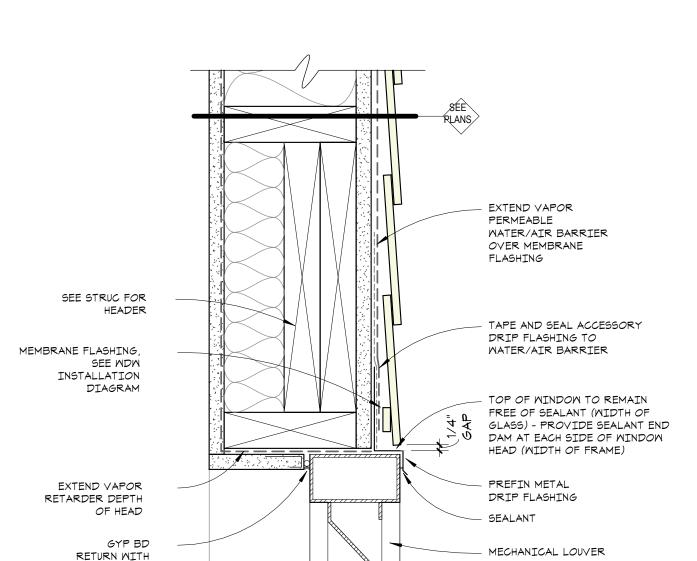
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WESLEY BRADLEY PARK 2 EAST BROWNSTONE

EXTERIOR ELEVATIONS -BROWNSTONE EAST










J-BEAD AND


A6.4 3" = 1'-0"

SEALANT

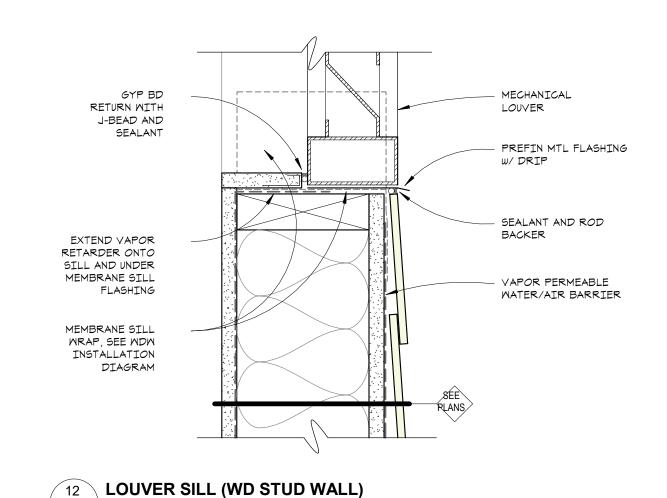


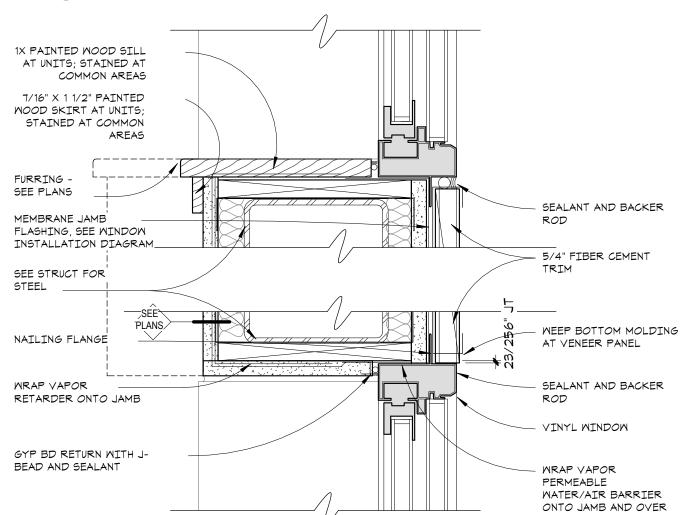

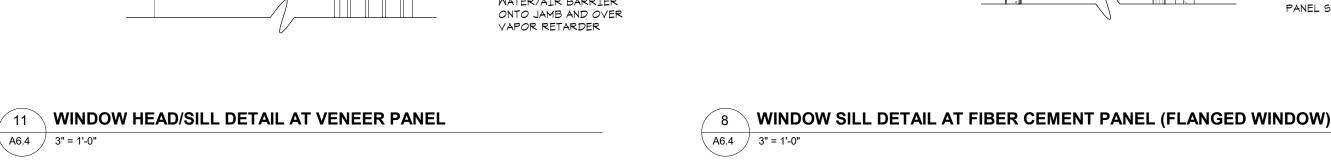


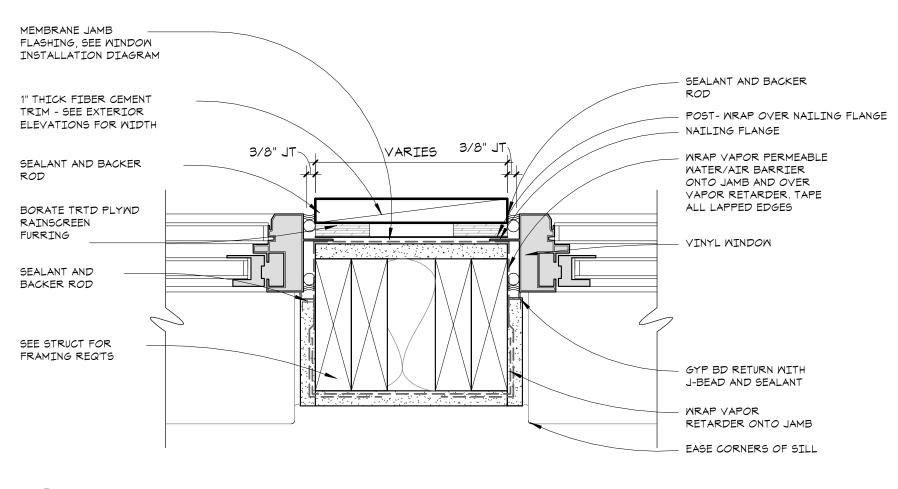


10 WINDOW JAMB DETAIL AT TRIM (PLAN)

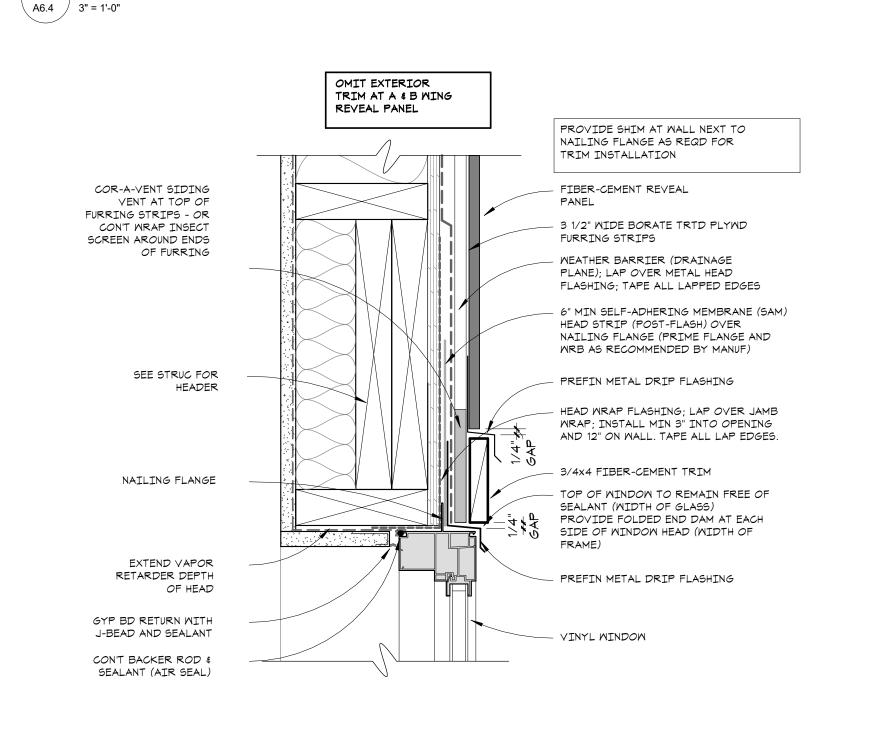



9 WINDOW HEAD DETAIL AT FC PANEL (FLANGED WINDOW)

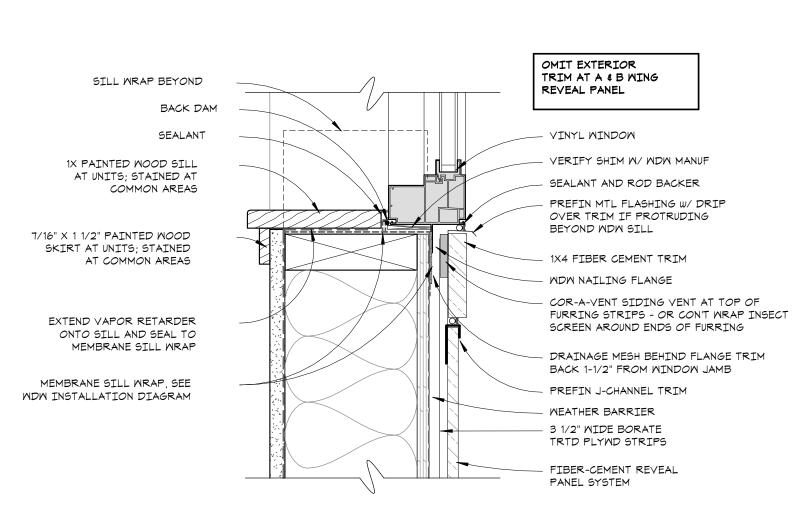




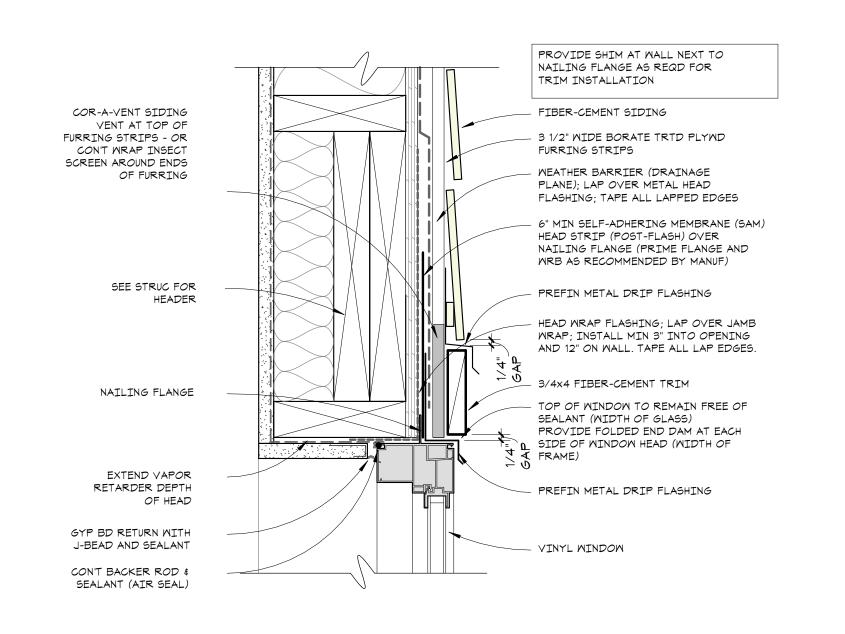

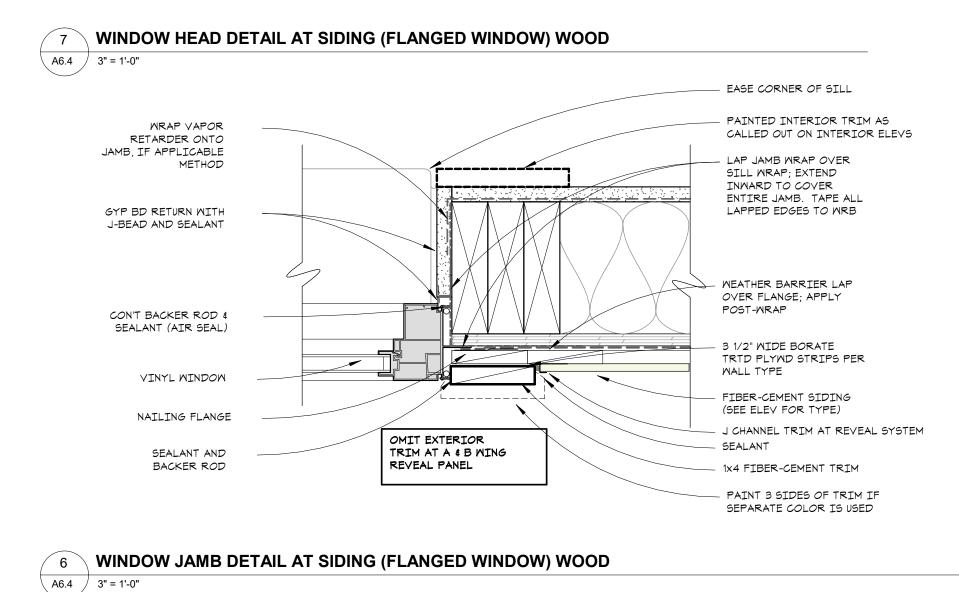

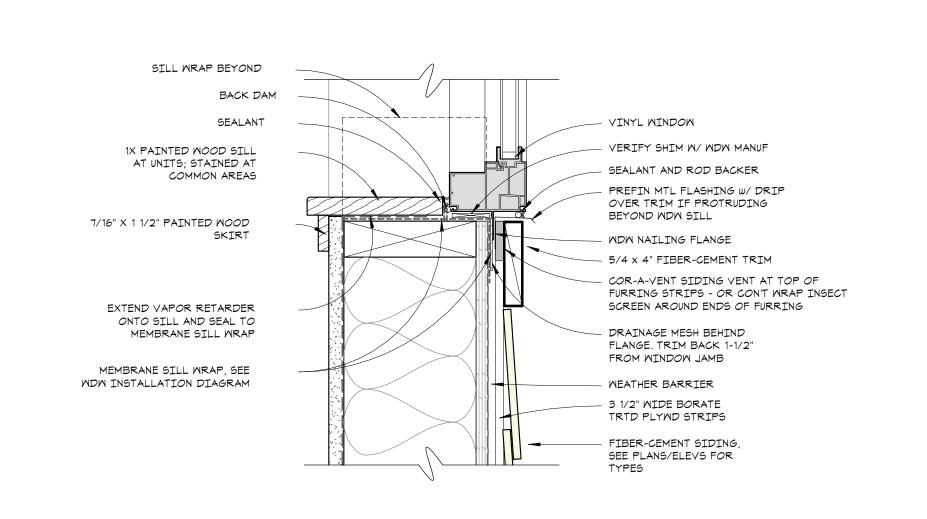

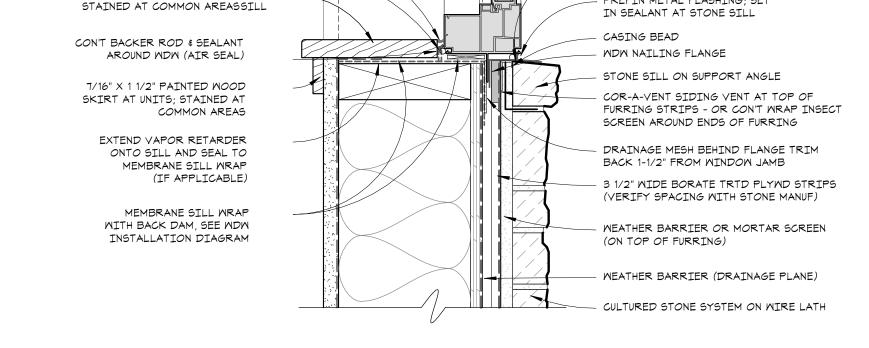

193/256" RS 1/2"

**WINDOW HEAD DETAIL AT STONE (FLANGED WINDOW) WOOD** 

2 WINDOW JAMB DETAIL AT STONE (FLANGED WINDOW) WOOD

WRAP VAPOR

RETARDER ONTO JAMB

m → OVER 3 1/2" WIDE

VINYL WINDOW

SEALANT AND

PREFIN METAL FLASHING; SET

ROD BACKER

SEE STRUC FOR

HEADER

NAILING FLANGE

EXTEND VAPOR RETARDER

(IF APPLICABLE METHOD)

A6.4 / 3" = 1'-0"

SILL; EASE CORNERS

GYP BD RETURN WITH

J-BEAD AND SEALANT

CON'T BACKER ROD \$

SEALANT (AIR SEAL)

VINYL WINDOW

SEALANT AND

BACKER ROD

SILL WRAP BEYOND

1X PAINTED WOOD SILL AT UNITS;URED

SEALANT

BACK DAM

HEMMED PREFIN

BREAK MTL CLOSURE

A6.4 3" = 1'-0"

GYP BD RETURN WITH

J-BEAD AND SEALANT

CON'T BACKER ROD &

SEALANT (AIR SEAL)

DEPTH OF HEAD

MEATHER BARRIER (DRAINAGE

PLANE); LAP OVER METAL HEAD

3 1/2" WIDE BORATE TRTD

PLYMD STRIPS

FLASHING; TAPE ALL LAPPED EDGES

WRB OR MORTAR SCREEN OVER FURRING

CULTURED STONE SYSTEM ON WIRE LATH

 6" MIN SELF-ADHERING MEMBRANE (SAM)HEAD STRIP OVER NAILING

RECOMMENDED BY MANUF)

CASING BEAD (OPTIONAL)

= > \$ PREFIN METAL DRIP FLASHING WITH

SEALANT (WIDTH OF GLASS)

FOLDED END DAMS AS REQUIRED;

TOP OF WINDOW TO REMAIN FREE OF

OF WINDOW HEAD (WIDTH OF FRAME)

PROVIDE FOLDED END DAM AT EACH SIDE

PAINTED INTERIOR TRIM

AS CALLED OUT ON

LAP JAMB WRAP OVER

ENTIRE JAMB. TAPE ALL

LAPPED EDGES TO WRB

MEATHER BARRIER (MRB)

WRB, MORTAR SCREEN,

OR CEMENT BACKER BD

BORATE TRTD PLYMD

- MANUF STONE SYSTEM

FURRING STRIPS

NAILING

SILL WRAP: EXTEND

INMARD TO COVER

INTERIOR ELEVS

FLANGE (PRIME FLANGE AND WRB AS

STRIP VENT (COR-A-VENT) OVER WDW


HEAD AT BOTTOM OF FURRING STRIPS

HEAD WRAP FLASHING; LAP OVER JAMB

WRAP; INSTALL MIN 3" INTO OPENING

AND 12" ON WALL. TAPE ALL LAP EDGES.



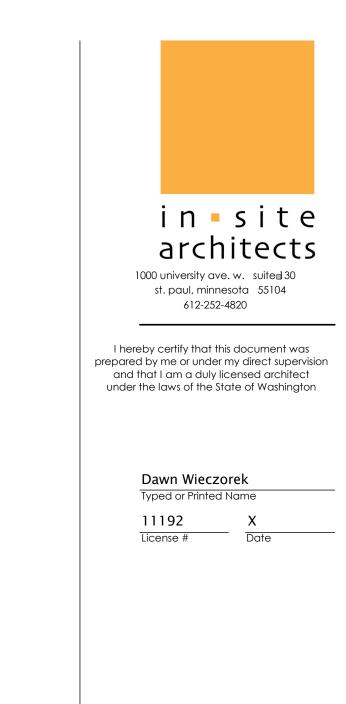

## WESLEY BRADLEY PARK 2 EAST BROWNSTONE

