

240 15TH ST SE PUYALLUP, WA 98372

DESIGN REVIEW AND SEPA SUBMISSION – OCTOBER 24, 2022

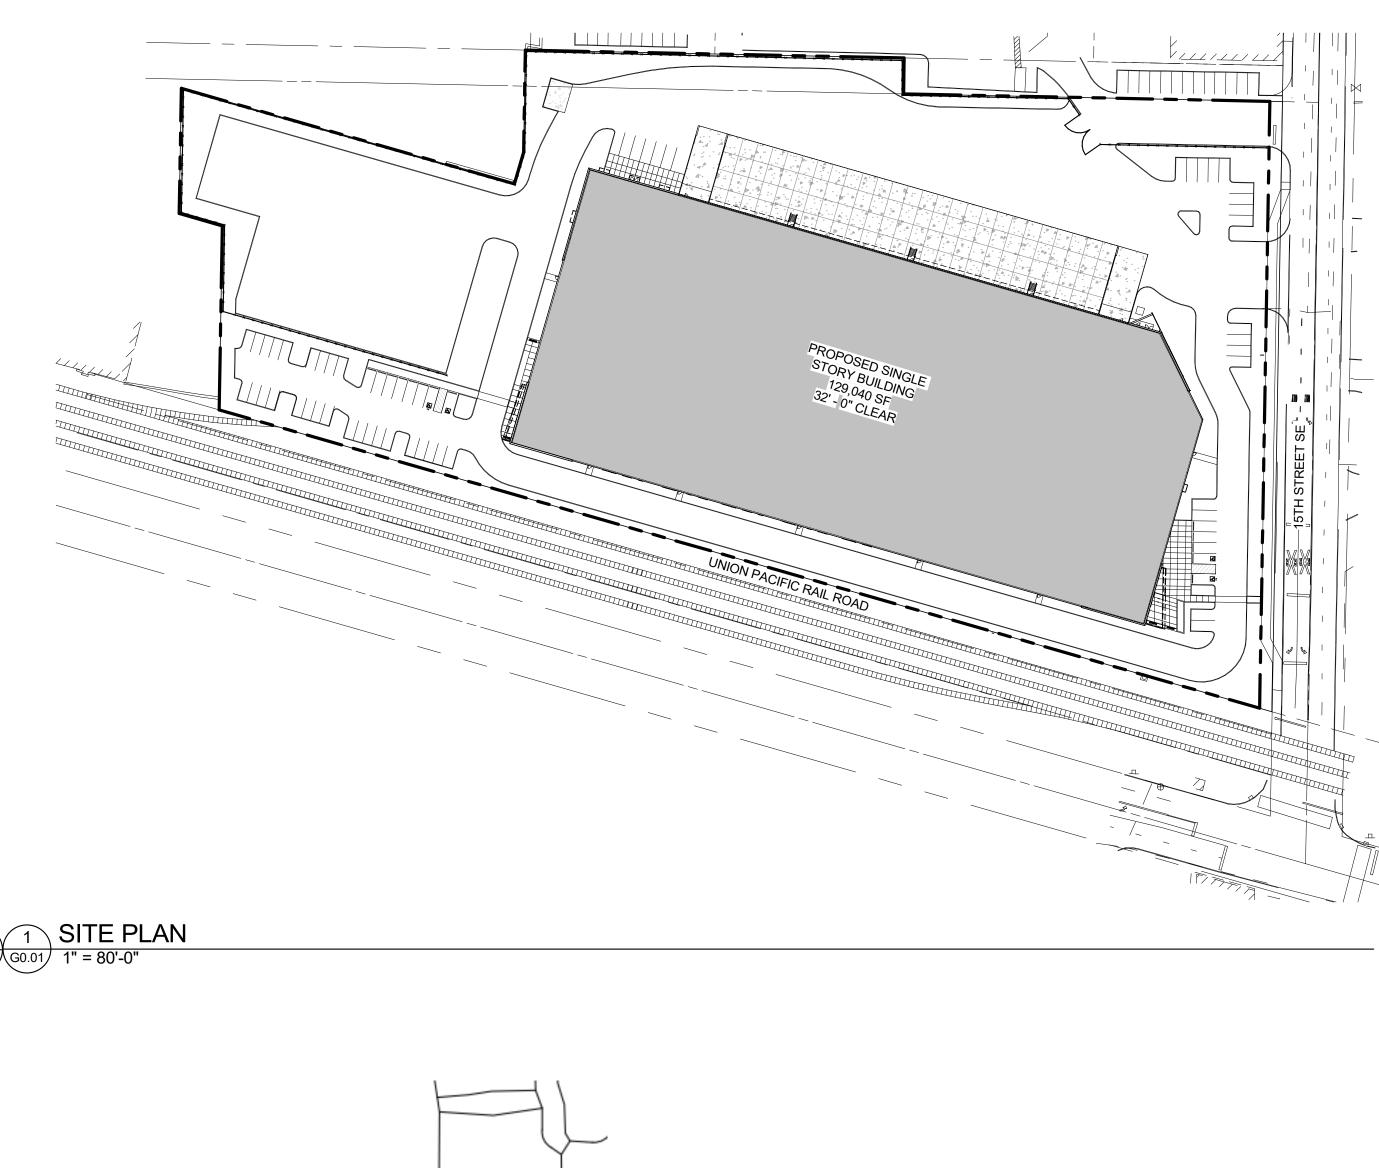

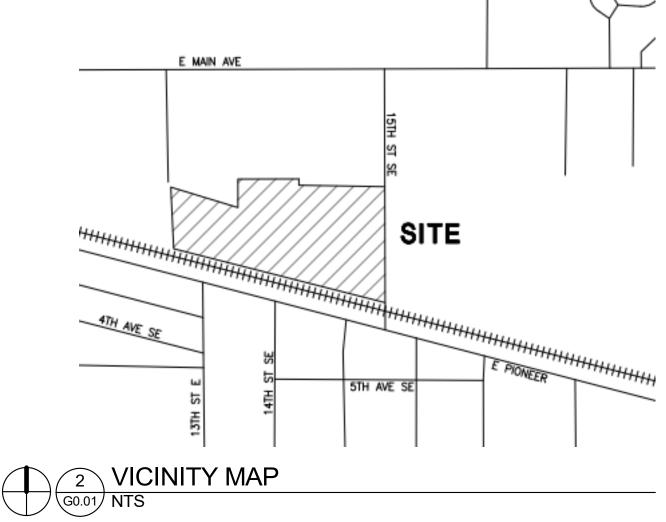

CREF3 PUYALLUP OWNER LLC

OWNER

CREF3 PUYALLUP OWNER LLC 11611 SAN VICENTE BLVD 10TH FLOOR LOS ANGELES, CA, 90049 PHONE: (310) 228-3030 CONTACT: BRADY THOMSON EMAIL: BTHOMSON@FORTRESS.COM

ARCHITECT

MACKENZIE

LOGAN BUILDING 500 UNION ST., STE. 410 SEATTLE, WA 98101 PHONE: (206) 749-9993 ARCHITECT: BRETT CONWAY CONTACT: JUSTIN ABRAHAM EMAIL: JABRAHAM@MCKNZE.COM

STRUCTURAL

MACKENZIE

LOGAN BUILDING 500 UNION ST., STE. 410 SEATTLE, WA 98101 PHONE: (206) 749-9993 CONTACT: ANDY TATKOWSKI EMAIL: ART@MCKNZE.COM

CIVIL

BARGHAUSEN

18215 72ND AVE S KENT, WA 98032 PHONE: (425) 251-6222 CONTACT: JÁSON HUBBELL EMAIL: JHUBBELL@BARGHAUSEN.COM

LANDSCAPE

MACKENZIE

RIVEREAST CENTER 1515 SE WATER AVE, #100 PORTLAND, OR 97214 PHONE: (503) 224-9560 CONTACT: NICOLE FERREIRA EMAIL: NFERREIRA@MCKNZE.COM

TRAFFIC

TENW - TRANSPORTATION ENGINEERING NORTHWEST 11400 SE 8TH ST., SUITE 200

RELIVIE WA 98004 **GEOTECHNICAL** EMAIL: AMY@IENW.COM-

TERRA ASSOCIATES 12220 113TH AVE NE, SUITE 130 KIRKLAND, WA 98034 PHONE: (425) 821-7777

ONE STORY

GENERAL DRAWINGS- DR

<u>CIVIL</u>	DRAV
P1 P2 P3 P4 P5 P6	
10	

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	LANDSCAP
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{	L5.12
{	L5.13
{	L5.14

A1.10 A2.00 A2.10



Architecture = Interiors Planning - Engineering

> Portland, OR 503.224.9560 /ancouver, WA 360.695.7879 Seattle, WA 206.749.9993 www.mcknze.com

MACKENZIE DESIGN DRIVEN | CLIENT FOCUSE

CREF3 PUYALLUP OWNER LLC

> 11611 SAN VICENTE BLVD. **10TH FLOOR** LOS ANGELES, CA 90049

FORTRESS PUYALLUP

240 15TH ST SE **PUYALLUP, WA 98372**



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	REVISION SCH	EDULE
Delta	Issued As	Issue Date
1	PLAN CHECK	5/26/23
2	PLAN CHECK	8/29/23
	•	

SHEET TITLE: TITLE SHEET AND DRAWING INDEX

DRAWN BY: TN

CHECKED BY: JA

SHEET



JOB NO. **2220290.00**

CODE ANALYSIS

BASED ON THE 2018 INTERNATIONAL BULIDING CODE WITH WASHINGTON STATE AMENDMENTS CONSTRUCTION TYPE: III-B

BUILDING HEIGHT: 42'-6"

FIRE PROTECTION: FULLY SPRINKLERED ESFR FUTURE OCCUPANCIES: S-1 (STORAGE WAREHOUSE), F-1 (MANUFACTURING), B (OFFICE). THE BUILDING AREA HAS BEEN CALCULATED BASED ON THE NON-SEPARATED USES (SECTIO

THE BUILDING TO BE UNOCCUPIED UNDER THIS PERMIT. FUTURE OCCUPANCIES MAY CONSIS OF B, S-1, AND/OR F-1 GROUPS. THE BUILDING AREA HAS BEEN CALCULATED BASED ON UNLIMITED AREA BUILDINGS (SECTION 507)

SITE AND BUILDING INFORMATION

240 15TH ST SE PUYALLUP, WA, 98372 PIERCE COUNTY TAX ID: 7845000161, 7945000170, 0420274126 FOR ADDITIONAL SITE AND BUILDING INFORMATION. SEE SHEET A1.10 - SITE PLAN

DRAWING INDEX

G0.01 TITLE SHEET AND DRAWING INDEX

WINGS - DR

PRELIMINARY CIVIL PLANS COVER SHEET

- EXISTING CONDITIONS PLAN PRELIMINARY SITE PLAN AND UTILITY PLAN
- PRELIMINARY GRADING AND DRAINAGE PLAN FIRE TRUCK ACCESS EXHIBIT
- ENTERING SITE DISTANCE EXHIBIT

TRANSPORTATION DRAWINGS - DR AUTOTURN ANALYSIS

PE DRAWINGS - DR

- LANDSCAPE GENERAL INFORMATION
- PLANTING PLAN EAST
- PLANTING PLAN CENTRAL
- PLANTING RLAN WEST MATERIALS AND LAYOUT PLAN
- SITE DETAILS
- ~ SQIL DETAILS
- IRRIGATION DETAILS
- PLANTING DETAILS
- STREET PLANTING DETAILS

ARCHITECTURE DRAWINGS - DR

SITE PLAN

EXTERIOR ELEVATIONS EXTERIOR RENDERINGS

8/29/2023 3:20:35 PM As indicated

BASIS OF PLAN

THIS SITE PLAN IS BASED ON LIMITED TOPOGRAPHIC AND BOUNDARY SURVEY, PREPARED BY BCE, INC. DATED 08/09/2022

THE EXISTING CULTURAL AND TOPOGRAPHIC DATA SHOWN ON THESE DRAWINGS HAS BEEN PREPARED. IN PART. BASED UPON INFORMATION FURNISHED BY OTHERS. WHILE THIS INFORMATION IS BELIEVED TO BE RELIABLE, BCE, INC. CANNOT ENSURE ACCURACY AND THUS IS NOT RESPONSIBLE FOR THE ACCURACY OF THAT INFORMATION OR FOR ANY ERRORS OR OMISSIONS WHICH MAY HAVE BEEN INCORPORATED INTO THESE DRAWINGS AS A RESULT. IT IS THE CONTRACTOR'S RESPONSIBILITY TO COORDINATE WITH THE OWNER TO HAVE ALL IMPROVEMENTS FIELD VERIFIED PRIOR TO CONSTRUCTION. DISCREPANCIES SHALL BE BROUGHT TO THE ATTENTION OF BARGHAUSEN CONSULTING ENGINEERS, INC. PRIOR TO WORK.

SURVEY INFORMATION

TITLE REPORT INFORMATION

TITLE COMMITMENT:

ALL TITLE INFORMATION SHOWN ON THIS MAP. INCLUDING APPURTENANT EASEMENTS AND ADJOINING DEEDS FOR UNPLATTED LOTS, IF ANY, HAS BEEN EXTRACTED FROM FIRST AMERICAN TITLE INSURANCE COMPANY ALTA COMMITMENT NO. NCS-1133990-CHI2, DATED JUNE 3, 2022 AT 7:30 AM. IN PREPARING THIS MAP, BARGHAUSEN CONSULTING ENGINEERS, INC. HAS CONDUCTED NO INDEPENDENT TITLE SEARCH NOR IS BARGHAUSEN CONSULTING ENGINEERS, INC. AWARE OF ANY TITLE ISSUES AFFECTING THE SURVEYED PROPERTY OTHER THAN THOSE SHOWN ON THE MAP AND DISCLOSED BY SAID COMMITMENT. BARGHAUSEN CONSULTING ENGINEERS, INC. HAS RELIED WHOLLY ON SAID TITLE COMPANY'S REPRESENTATIONS OF THE TITLE'S CONDITION TO PREPARE THIS SURVEY AND THEREFORE BARGHAUSEN CONSULTING ENGINEERS, INC. QUALIFIES THE MAP'S ACCURACY AND COMPLETENESS TO THAT EXTENT.

LEGAL DESCRIPTION: (PER ABOVE REFERENCED TITLE REPORT)

PARCEL "A"

THAT PORTION OF BLOCKS 34 TO 37, INCLUSIVE, OF REPLAT OF A PART OF FRANK R. SPINNING'S FIRST ADDITION TO THE TOWN OF PUYALLUP, PIERCE COUNTY, WASHINGTON, ACCORDING TO PLAT RECORDED IN BOOK 6 OF PLATS AT PAGE(S) 91, LYING NORTHERLY OF THE NORTHERN PACIFIC RAILWAY COMPANY RIGHT OF WAY, IN PUYALLUP, PIERCE COUNTY, WASHINGTON.

TOGETHER WITH THE SOUTH 30 FEET OF VACATED PIONEER AVENUE ABUTTING BLOCKS 34 AND 35 AS VACATED BY CITY OF PUYALLUP ORDINANCE NO. 211 RECORDED FEBRUARY 14, 1902 UNDER AUDITOR'S NO. 146161.

PARCEL "B" A PARCEL OF LAND SITUATED WITHIN THE SOUTHEAST QUARTER OF SECTION 27, TOWNSHIP 20 NORTH. RANGE 4 EAST OF THE WILLAMETTE MERIDIAN. IN PIERCE COUNTY, WASHINGTON, DESCRIBED AS FOLLOWS:

BEGINNING AT THE SOUTHEAST CORNER OF BLOCK 33 OF REPLAT OF A PART OF FRANK R. SPINNING'S FIRST ADDITION TO THE TOWN OF PUYALLUP, PIERCE COUNTY, WASHINGTON, ACCORDING TO PLAT RECORDED IN BOOK 6 OF PLATS AT PAGE 91; THENCE NORTH 00'50' WEST 28.58 FEET ALONG THE EAST LINE OF SAID BLOCK 33;

THENCE SOUTH 14'18'45" WEST 27.61 FEET TO A POINT ON THE SOUTH LINE OF SAID BLOCK 33; THENCE SOUTH 75'49' EAST 7.47 FEET ALONG SAID SOUTH LINE TO THE POINT OF BEGINNING. IN PUYALLUP, PIERCE COUNTY, WASHINGTON.

PARCEL "C"

THAT PORTION OF THE SOUTHEAST OF SECTION 27, TOWNSHIP 20 NORTH, RANGE 4 EAST OF THE WILLAMETTE MERIDIAN, IN PIERCE COUNTY, WASHINGTON, DESCRIBED AS FOLLOWS:

COMMENCING AT THE SECTION CORNER COMMON TO SECTIONS 26, 27, 34 AND 35, ALL IN SAID TOWNSHIP 20 NORTH, RANGE 4 EAST; THENCE NORTHERLY ALONG THE SECTION LINE COMMON TO SAID SECTIONS 26 AND 27. A DISTANCE OF 1578.0 FEET, MORE OR LESS, TO THE POINT OF INTERSECTION WITH A LINE DRAWN PARALLEL WITH AND DISTANT 51.13 FEET NORTHERLY OF, AS MEASURED AT RIGHT ANGLES TO. BURLINGTON NORTHERN

RAILROAD COMPANY'S MAIN TRACK CENTERLINE. AS NOW LOCATED AND CONSTRUCTED THENCE NORTHWESTERLY DEFLECTING 74'59 TO THE LEFT FROM SAID SECTION LINE, ALONG SAID LINE LYING 51.13 FEET NORTHERLY OF AND PARALLEL WITH SAID MAIN TRACT CENTERLINE, A DISTANCE OF 493.0 FEET, MORE OR LESS, TO THE POINT OF INTERSECTION WITH THE WEST RIGHT OF WAY LINE OF FIFTEENTH STREET SOUTHEAST, AS NOW LOCATED IN THE CITY OF PUYALLUP, WASHINGTON SAID POINT

BEING THE TRUE POINT OF BEGINNING OF THE PARCEL TO BE DESCRIBED; THENCE CONTINUING NORTHWESTERLY ALONG SAID PARALLEL LINE, 920.0 FEET, MORE OR LESS, TO THE POINT OF INTERSECTION WITH A LINE DRAWN PARALLEL WITH AND DISTANT 8.50 FEET NORTHERLY OF, AS MEASURED AT RIGHT ANGLES TO, THE MOST NORTHERLY SPUR TRACT OF SAID BURLINGTON NORTHERN RAILROAD COMPANY, AS NOW LOCATED AND CONSTRUCTED

THENCE NORTHERLY, PARALLEL WITH THE WEST LINE OF BLOCK 32 OF REPLAT OF A PART OF FRANK R. SPINNING'S FIRST ADDITION TO THE TOWN OF PUYALLUP, ACCORDING TO PLAT RECORDED IN BOOK 6 OF PLATS AT PAGE 91. A DISTANCE OF 148.0 FEET: THENCE NORTHWESTERLY, PARALLEL WITH SAID LINE LYING 51.13 FEET NORTHERLY OF SAID RAILROAD

COMPANY'S MAIN TRACT CENTERLINE, A DISTANCE OF 40.0 FEET; THENCE NORTHERLY, PARALLEL WITH SAID WEST LINE OF BLOCK 32, 106.0 FEET TO THE POINT OF INTERSECTION WITH A LINE DRAWN PARALLEL WITH AND DISTANT 300.0 FEET NORTHERLY OF, AS MEASURED AT RIGHT ANGLES TO, SAID MAIN TRACT CENTERLINE; THENCE EASTERLY ALONG SAID PARALLEL LINE, 946.0 FEET, MORE OR LESS, TO THE POINT OF INTERSECTION WITH THE WEST RIGHT OF WAY LINE OF FIFTEENTH STREET SOUTHEAST; THENCE SOUTHERLY ALONG SAID WEST RIGHT OF WAY LINE TO THE TRUE POINT OF BEGINNING, IN

HORIZONTAL DATUM

PIERCE COUNTY, WASHINGTON.

NAD 83/11 PER WSDOT PUBLISHED MONUMENTS. WSDOT CONTROL POINT "GP 27512-100" WAS HELD FOR POSITION, AND A LINE BETWEEN SAID POINT "GP 27512-100" AND CONTROL POINT "GP27512-18AZ" WAS HELD FOR ROTATION, BEING SOUTH 38°23'07" WEST.

VERTICAL DATUM: NAVD88

VERTICAL CONTROL PUBLISHED BY WSDOT. POINT "GP 27512-100" WAS HELD FOR ELEVATION. BENCHMARK ELEVATION = 81.27'

SITE BENCHMARK:

SET MAGNAIL & WASHER #49 IN THE SIDEWALK ON THE WEST SIDE OF 15TH STREET S.E. ELEVATION =55.16' (NAVD 88)

LEGEND:

PROPOSED		CURB	EXISTING		
HEAVY DUTY ASPHALT		PAINT STRIPE		LUMINAIRE (LUM.)	¢−−X
		CONCRETE	▽ ▷ ♡ ♦	YARD LIGHT	E-
LIGHT DUTY ASPHALT		CONCRETE (DEMO)	v	POWER METER	۲
GRIND AND OVERLAY ASPHALT		CONTOUR	432 —	POWER POLE JUNCTION BOX (AS NOTED)	-0- ⊠
SAWCUT				CATCH BASIN (CB)	
CONTOUR	66	WATER		STORM MANHOLE (SDMH)	
STORM DRAIN PIPE		STORM	SD	SANITARY SEWER MANHOLE (SSMH)	\bigcirc
TYPE 1 CATCH BASIN		TYPE 1 CATCH BASIN		CLEANOUT (AS NOTED)	0
			<u> </u>	GAS METER	
TYPE 2 CATCH BASIN		SANITARY	55	GAS VALVE WATER VALVE (WV)	GV ¥X
SPOT ELEVATION	65.00	SS MANHOLE	\bigcirc	FIRE HYDRANT(FH)	N Q
STREET LIGHT	́~ П	GAS	G	CONNECTION(FDC)	þ
		POWER OVERHEAD	— P (OH)—	WATER METER	Ξ
		POWER UNDERGROUND	——P (UG)—	SIGN	
		GRAVEL/SAND (AS NOTED))	DIRECTIONAL ARROW	
		ASPHALT		BOLLARD	Ð
		BUILDING LINE		CONIFEROUS TREE	- And
		WATER LINE	W	DECIDUOUS TREE	
		OH/UG TEL. LINE	T(XX)		


UTILITIES/SERVICES

WATER: CITY OF PUYALLUP WATER DIVISION 1100 39TH AVE. SE PUYALLUP, WA 98374 (253) 841-5505 GAS: PUGET SOUND ENERGY

8001 SOUTH 212TH STREET KENT, WA 98032 (253) 395-7065 POWER:

PUGET SOUND ENERGY 8001 SOUTH 212TH STREET KENT, WA 98032 (253) 395-7065


SEWER/STORM CITY OF PUYALLUP 333 S MERIDIAN PUYALLUP, WA 98371

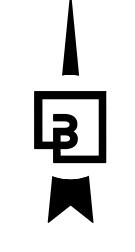

C)	5	0'	10	0'		200
		sc	AL	.E:	1"=	100'	

PRELIMINARY CIVIL PLANS - COVER SHEET

PORTION OF SE QUARTER OF SEC 27, TWN 20 N, RGE. 4 E, W.M. CITY OF PUYALLUP, PIERCE COUNTY, WASHINGTON

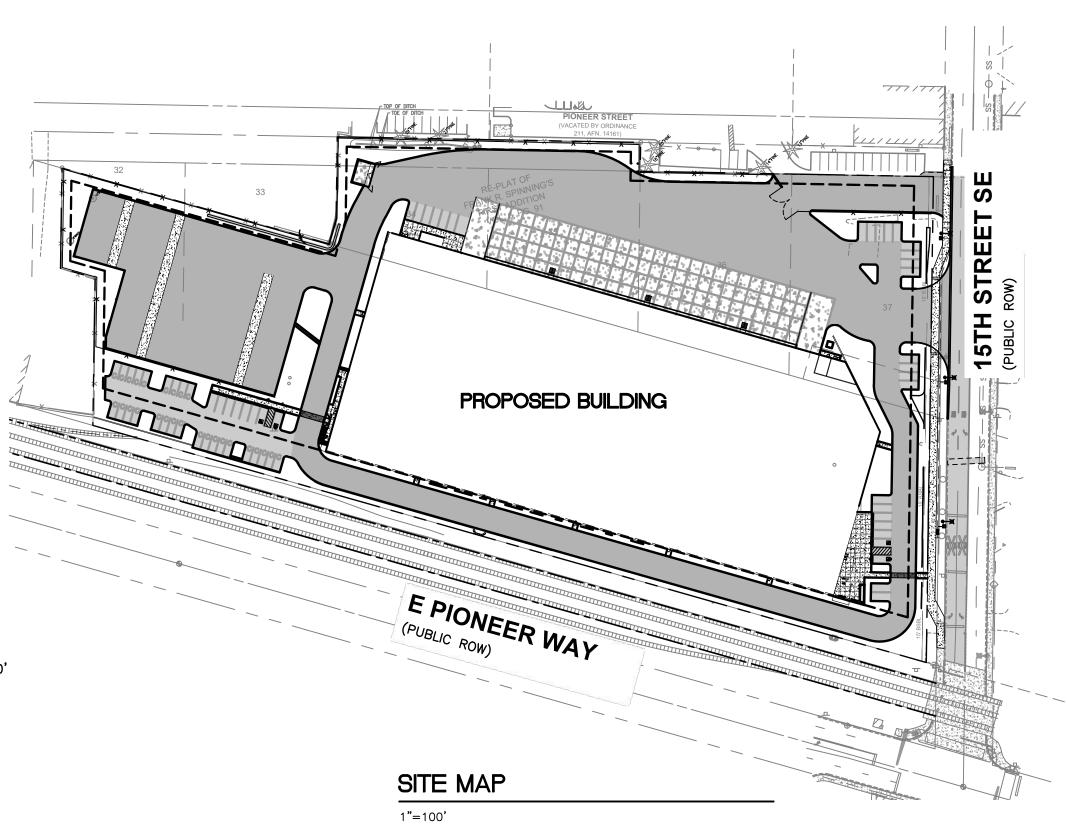



INDEX OF SHEETS


- P1 PRELIMINARY CIVIL PLANS COVER SHEET
- **P2 EXISTING CONDITIONS PLAN**
- **P3** PRELIMINARY SITE PLAN AND UTILITY PLAN
- PRELIMINARY GRADING AND DRAINAGE PLAN **P4**
- FIRE TRUCK ACCESS EXHIBIT **P5**
- **ENTERING SITE DISTANCE EXHIBIT P6**


SOILS REPORT NOTES


- THE FOLLOWING SOILS REPORTS/ASSESSMENTS WERE PREPARED FOR THE SITE: GEOTECHNICAL REPORT, PROJECT NO. T-8661 DATED: JAN 12TH 2022:
- 240 15TH STREET SE INDUSTRIAL 240 – 15TH STREET SE PUYALLUP, WASHINGTON
- PREPARED BY: TERRA ASSOCIATES, INC. 12220 113TH AVENUE NE, STE. 130 KIRKLAND. WASHINGTON 98034
- 2. IT SHALL BE THE RESPONSIBILITY OF THE CONTRACTOR TO ENSURE THAT ALL PROVISIONS OF THE SOILS REPORT FOR THE SITE BE OBSERVED AND COMPLIED WITH DURING ALL PHASES OF THE SITE PREPARATION. GRADING OPERATIONS, AND PAVING CONSTRUCTION.
- ANY PROVISIONS OF THE SOILS REPORT WHICH CONFLICT WITH INFORMATION SHOWN ELSEWHERE ON THESE DRAWINGS, OR WHICH REQUIRE FURTHER CLARIFICATION, SHALL BE BROUGHT TO THE ATTENTION OF BARGHAUSEN ENGINEERS.
- 4. A REPRESENTATIVE FOR THE SOILS ENGINEER SHALL BE AVAILABLE TO OBSERVE AND APPROVE THE EARTHWORK OPERATIONS AND TO VERIFY FIELD CONDITIONS AS WORK PROCEEDS. THE SOILS ENGINEER SHALL SUBMIT FIELD REPORTS CERTIFYING THAT THE METHODS AND MATERIALS OF THE EARTHWORK OPERATIONS WERE IN ACCORDANCE WITH THE RECOMMENDATION OF THE SOILS INVESTIGATION AND THAT THE WORK WAS PERFORMED TO THE SATISFACTION OF THE ENGINEER. THE CONTRACTOR SHALL MAKE ALL PROVISIONS FOR SOILS INSPECTIONS AS RECOMMENDED WITHIN SOILS REPORT AS A MINIMUM, THIS INCLUDES THE OBSERVATION OF THE FOLLOWING BY A SOILS ENGINEER: UTILITY TRENCH EXCAVATIONS, UTILITY PIPE BEDDING, SUBGRADE STABILITY, FOOTING SUBGRADE CONDITIONS, STRUCTURAL FILL OBSERVATIONS AND TESTING, SITE DRAINAGE MEASURES AND OBSERVATIONS, PAVEMENT SUBGRADE OBSERVATIONS, EROSION CONTROL, SITE STABILITY INCLUDING TEMPORARY AND PERMANENT SLOPES.
- THE SOILS ENGINEER SHOULD BE NOTIFIED AT LEAST FIVE (5) WORKING DAYS PRIOR TO ANY SITE CLEARING 5. OR GRADING.
- THE SITE IS IDENTIFIED BY WASHINGTON STATE D.O.E. AS HAVING CONFIRMED OR SUSPECTED SOILS CONTAMINATION. REFER TO NOTES ON SHEET E3 FOR ALL WORK IN KNOWN AREAS OF CONTAMINATED SOILS AND FOR STORMWATER DISCHARGES FROM SITE

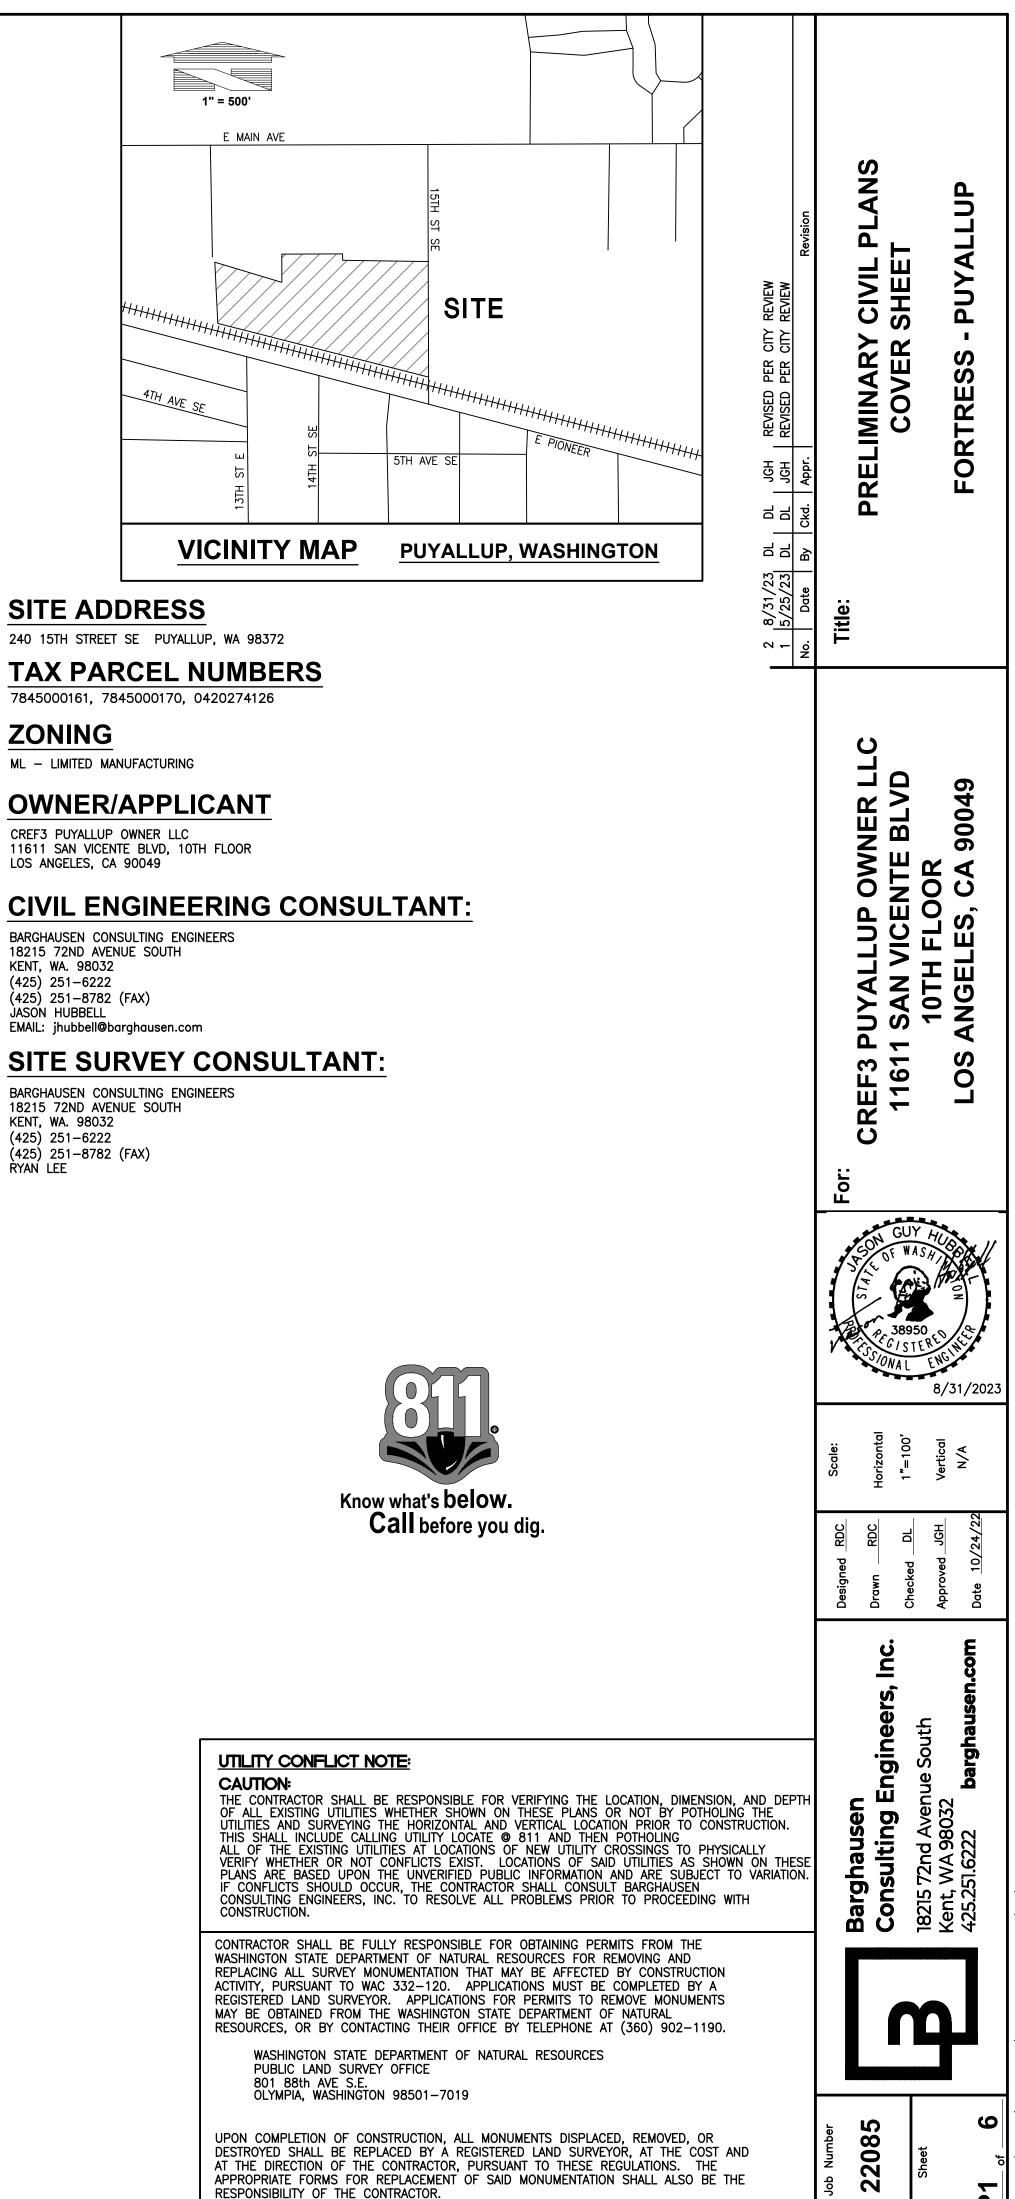


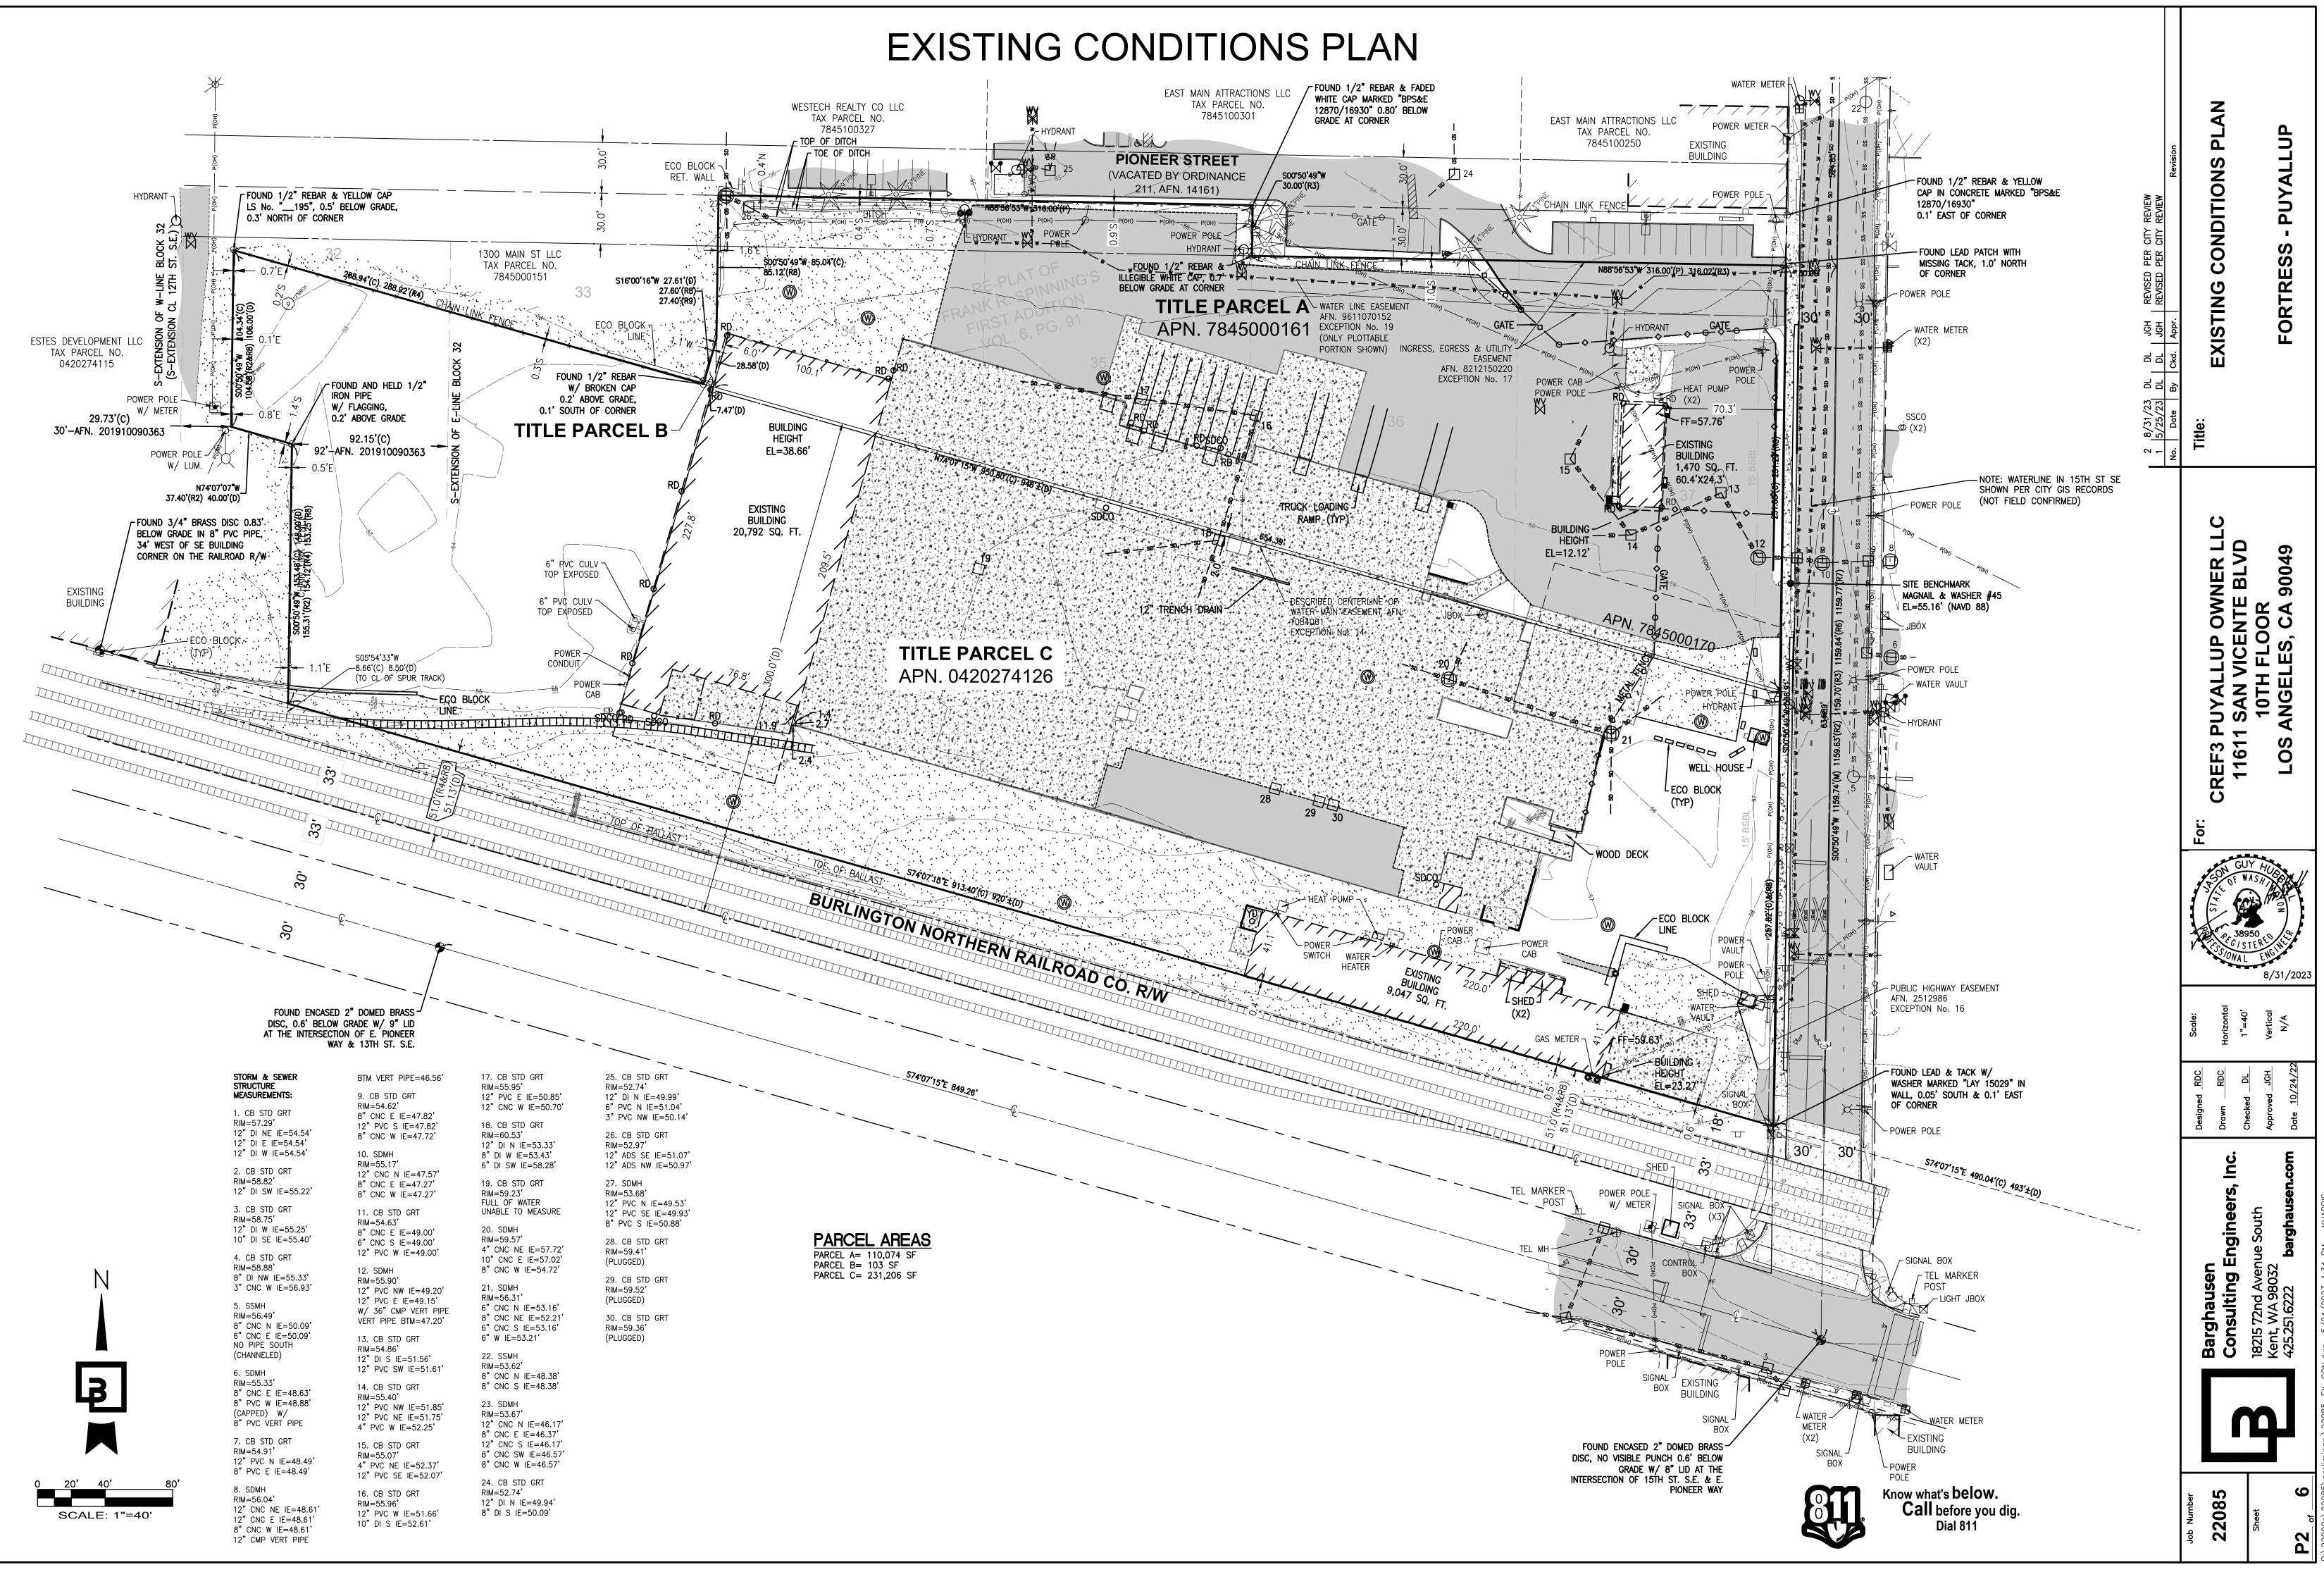

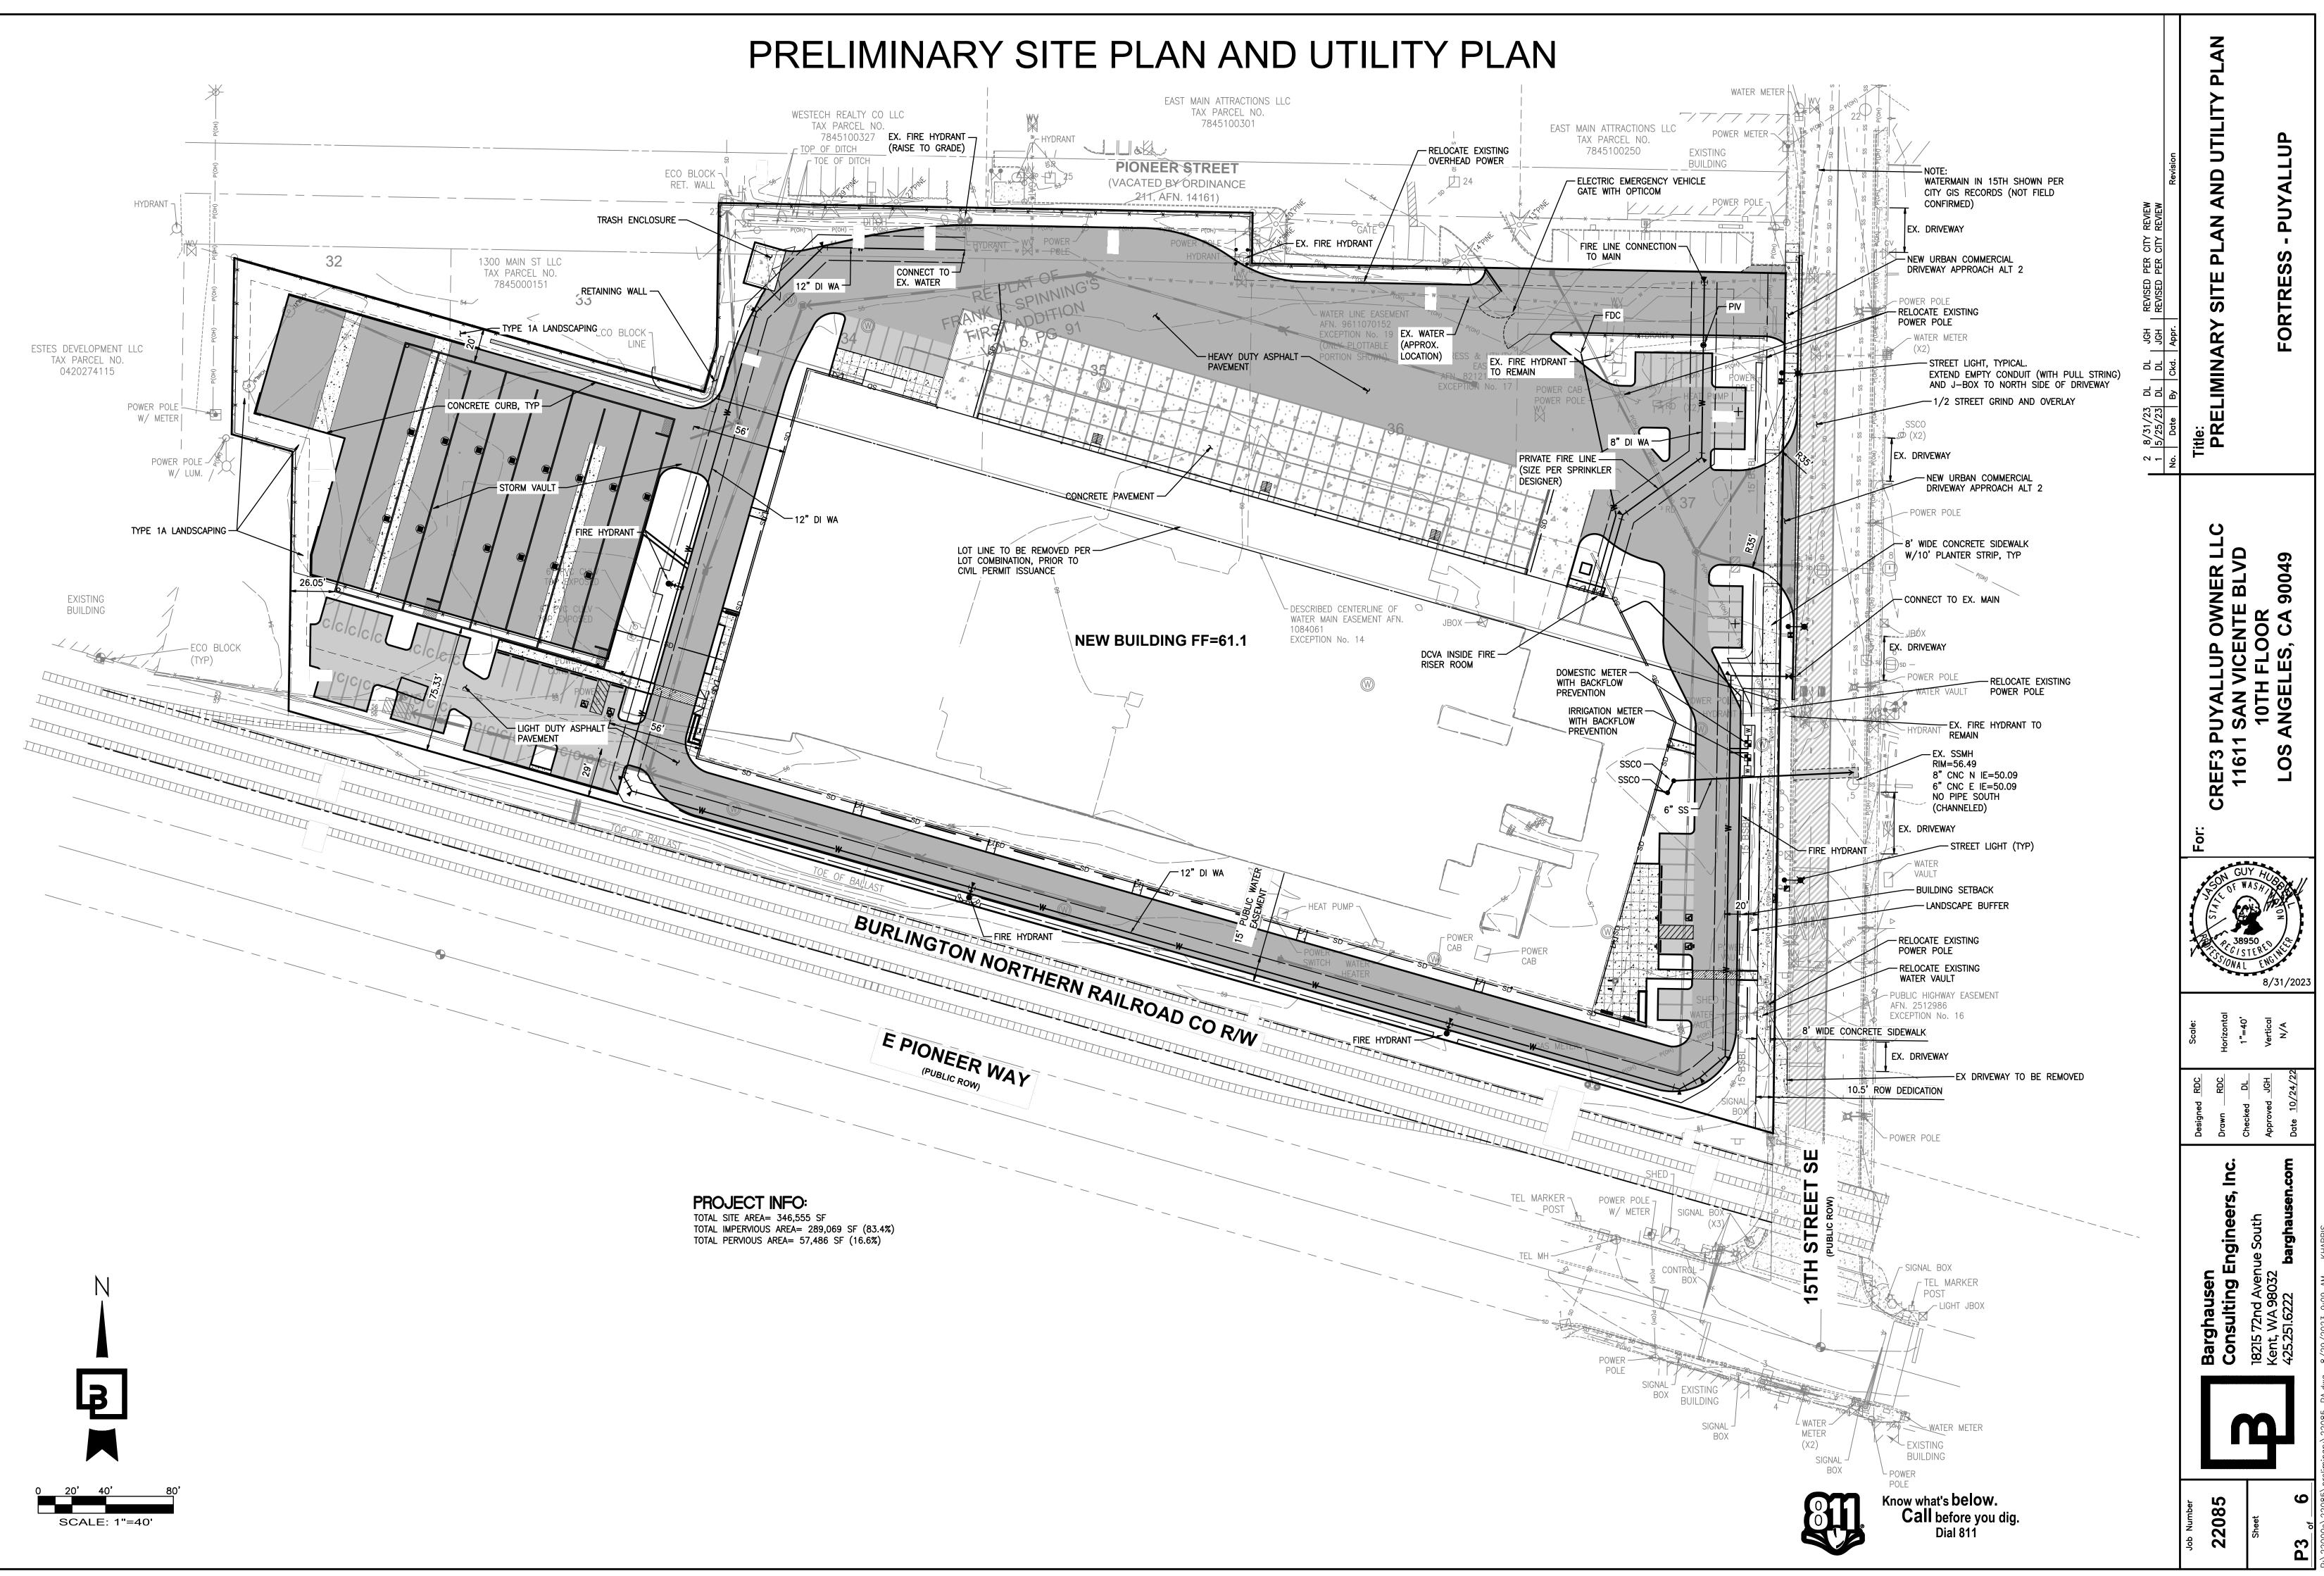


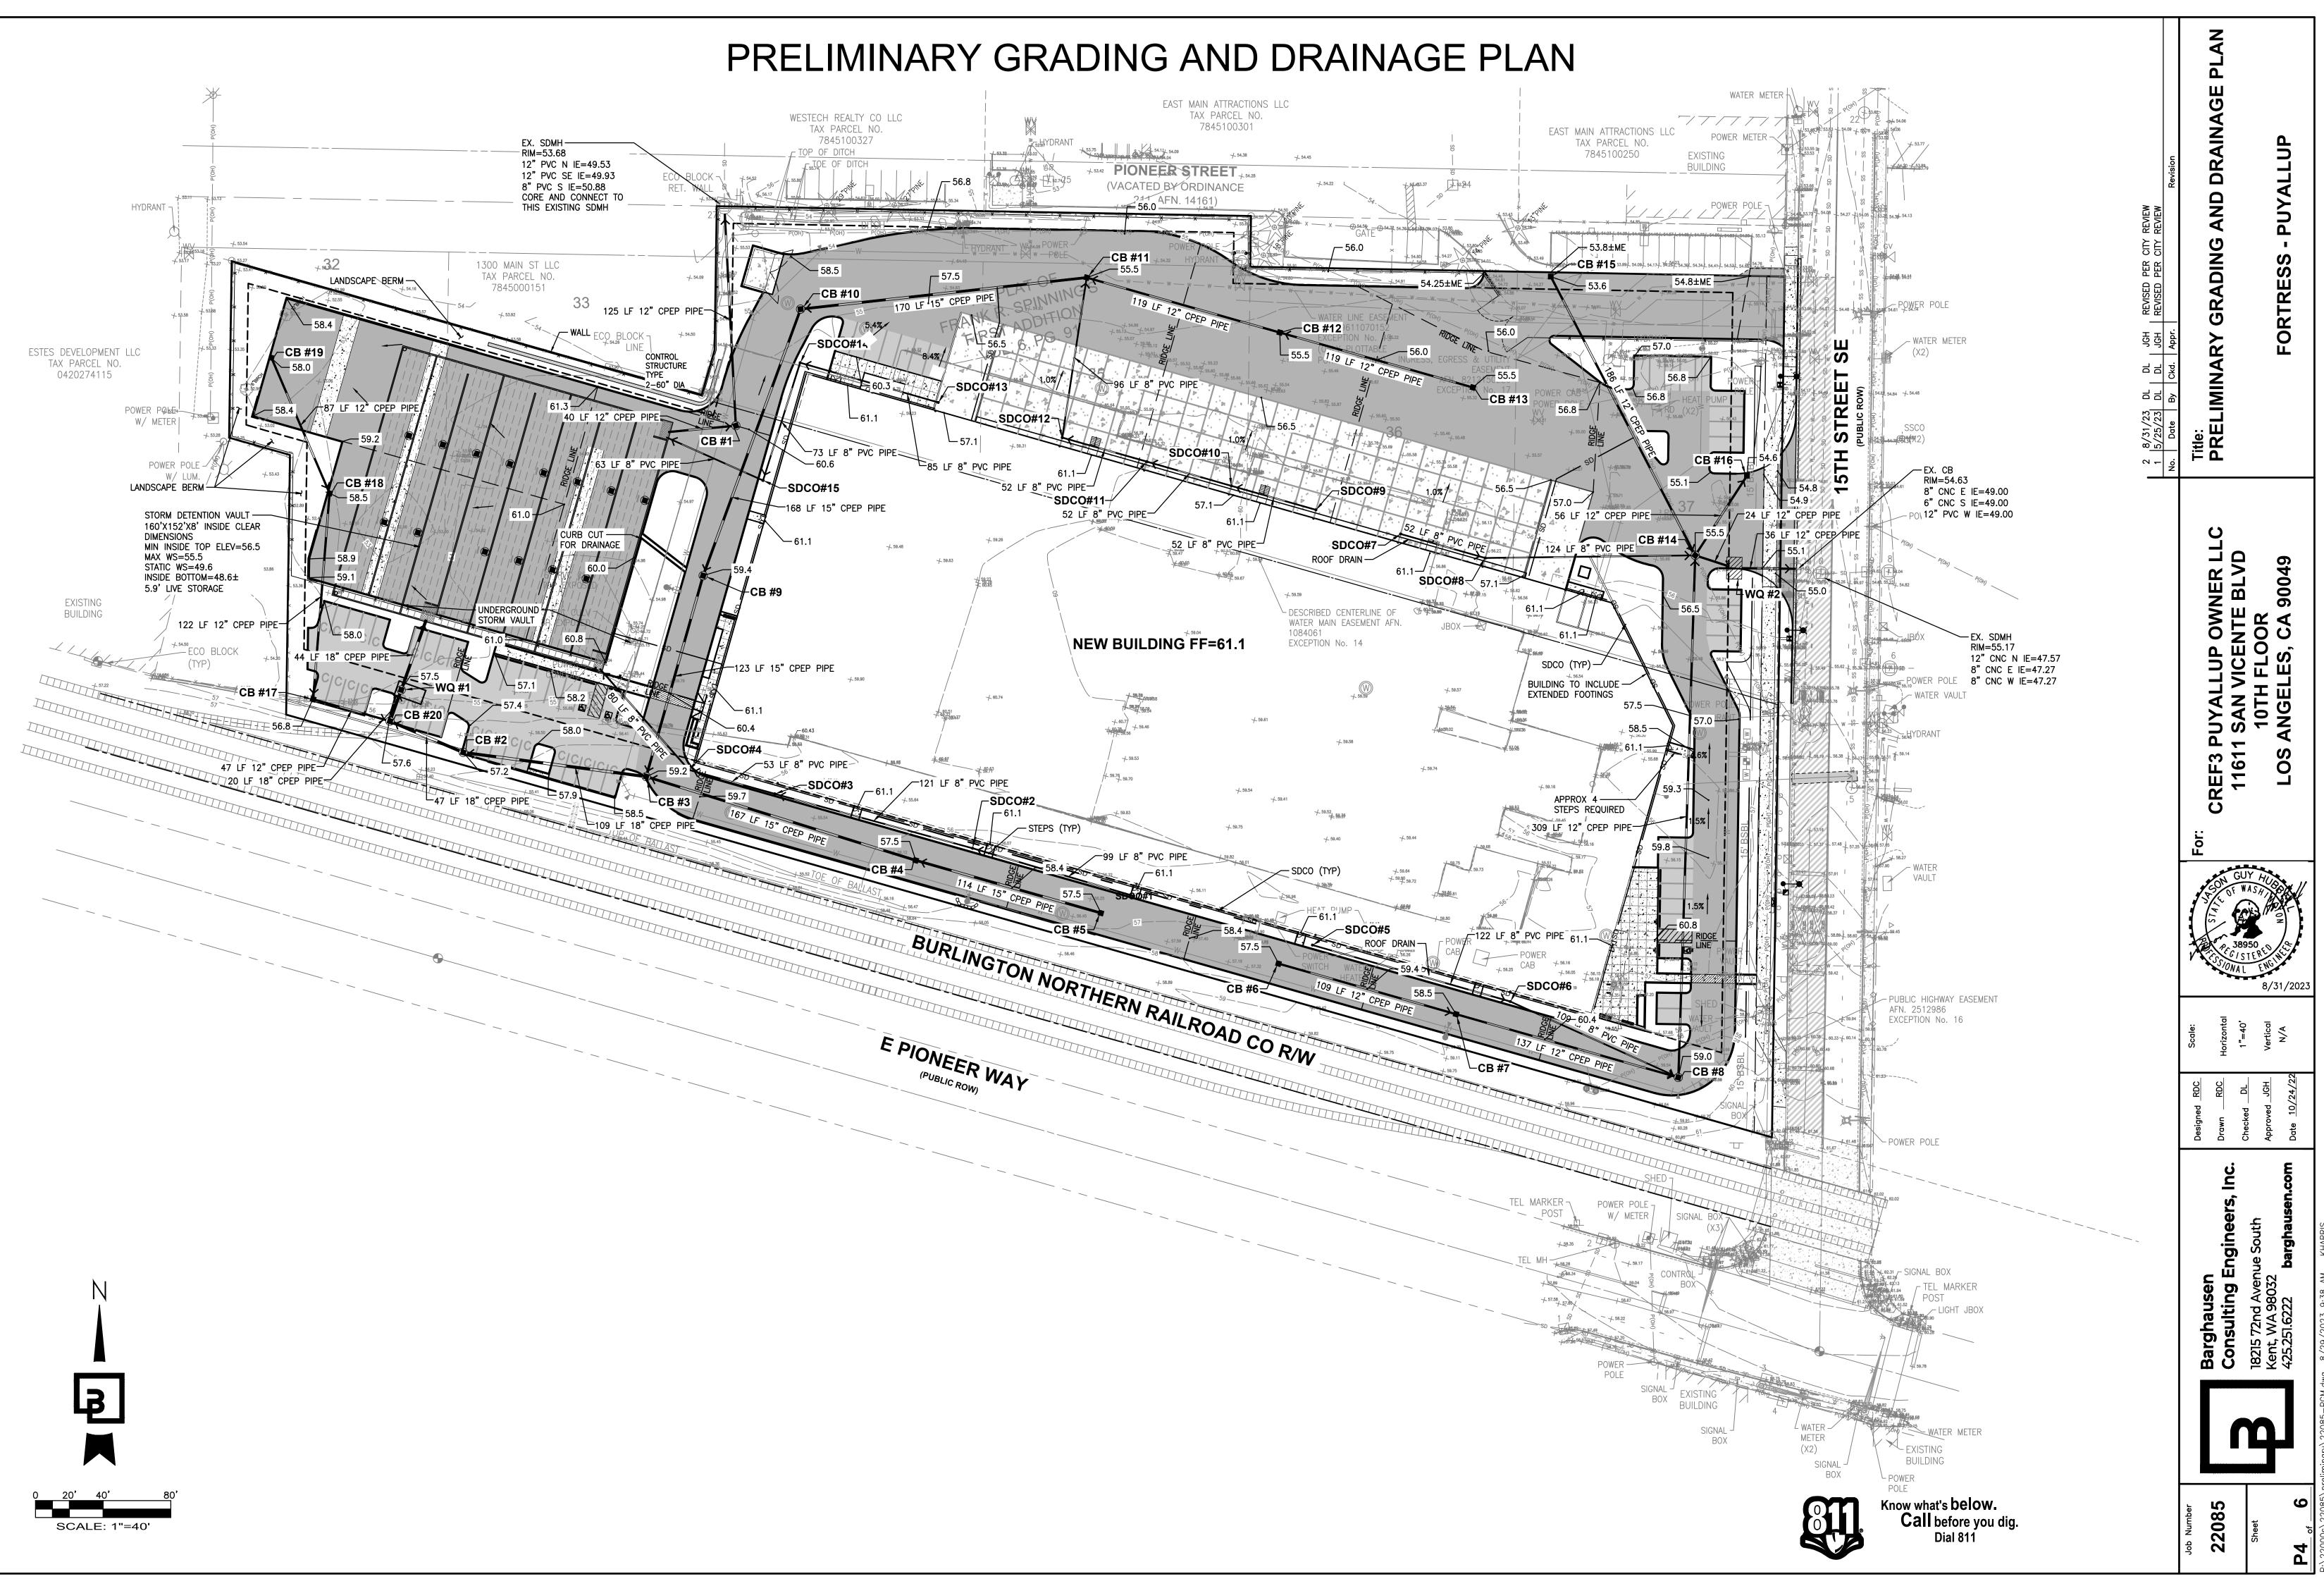


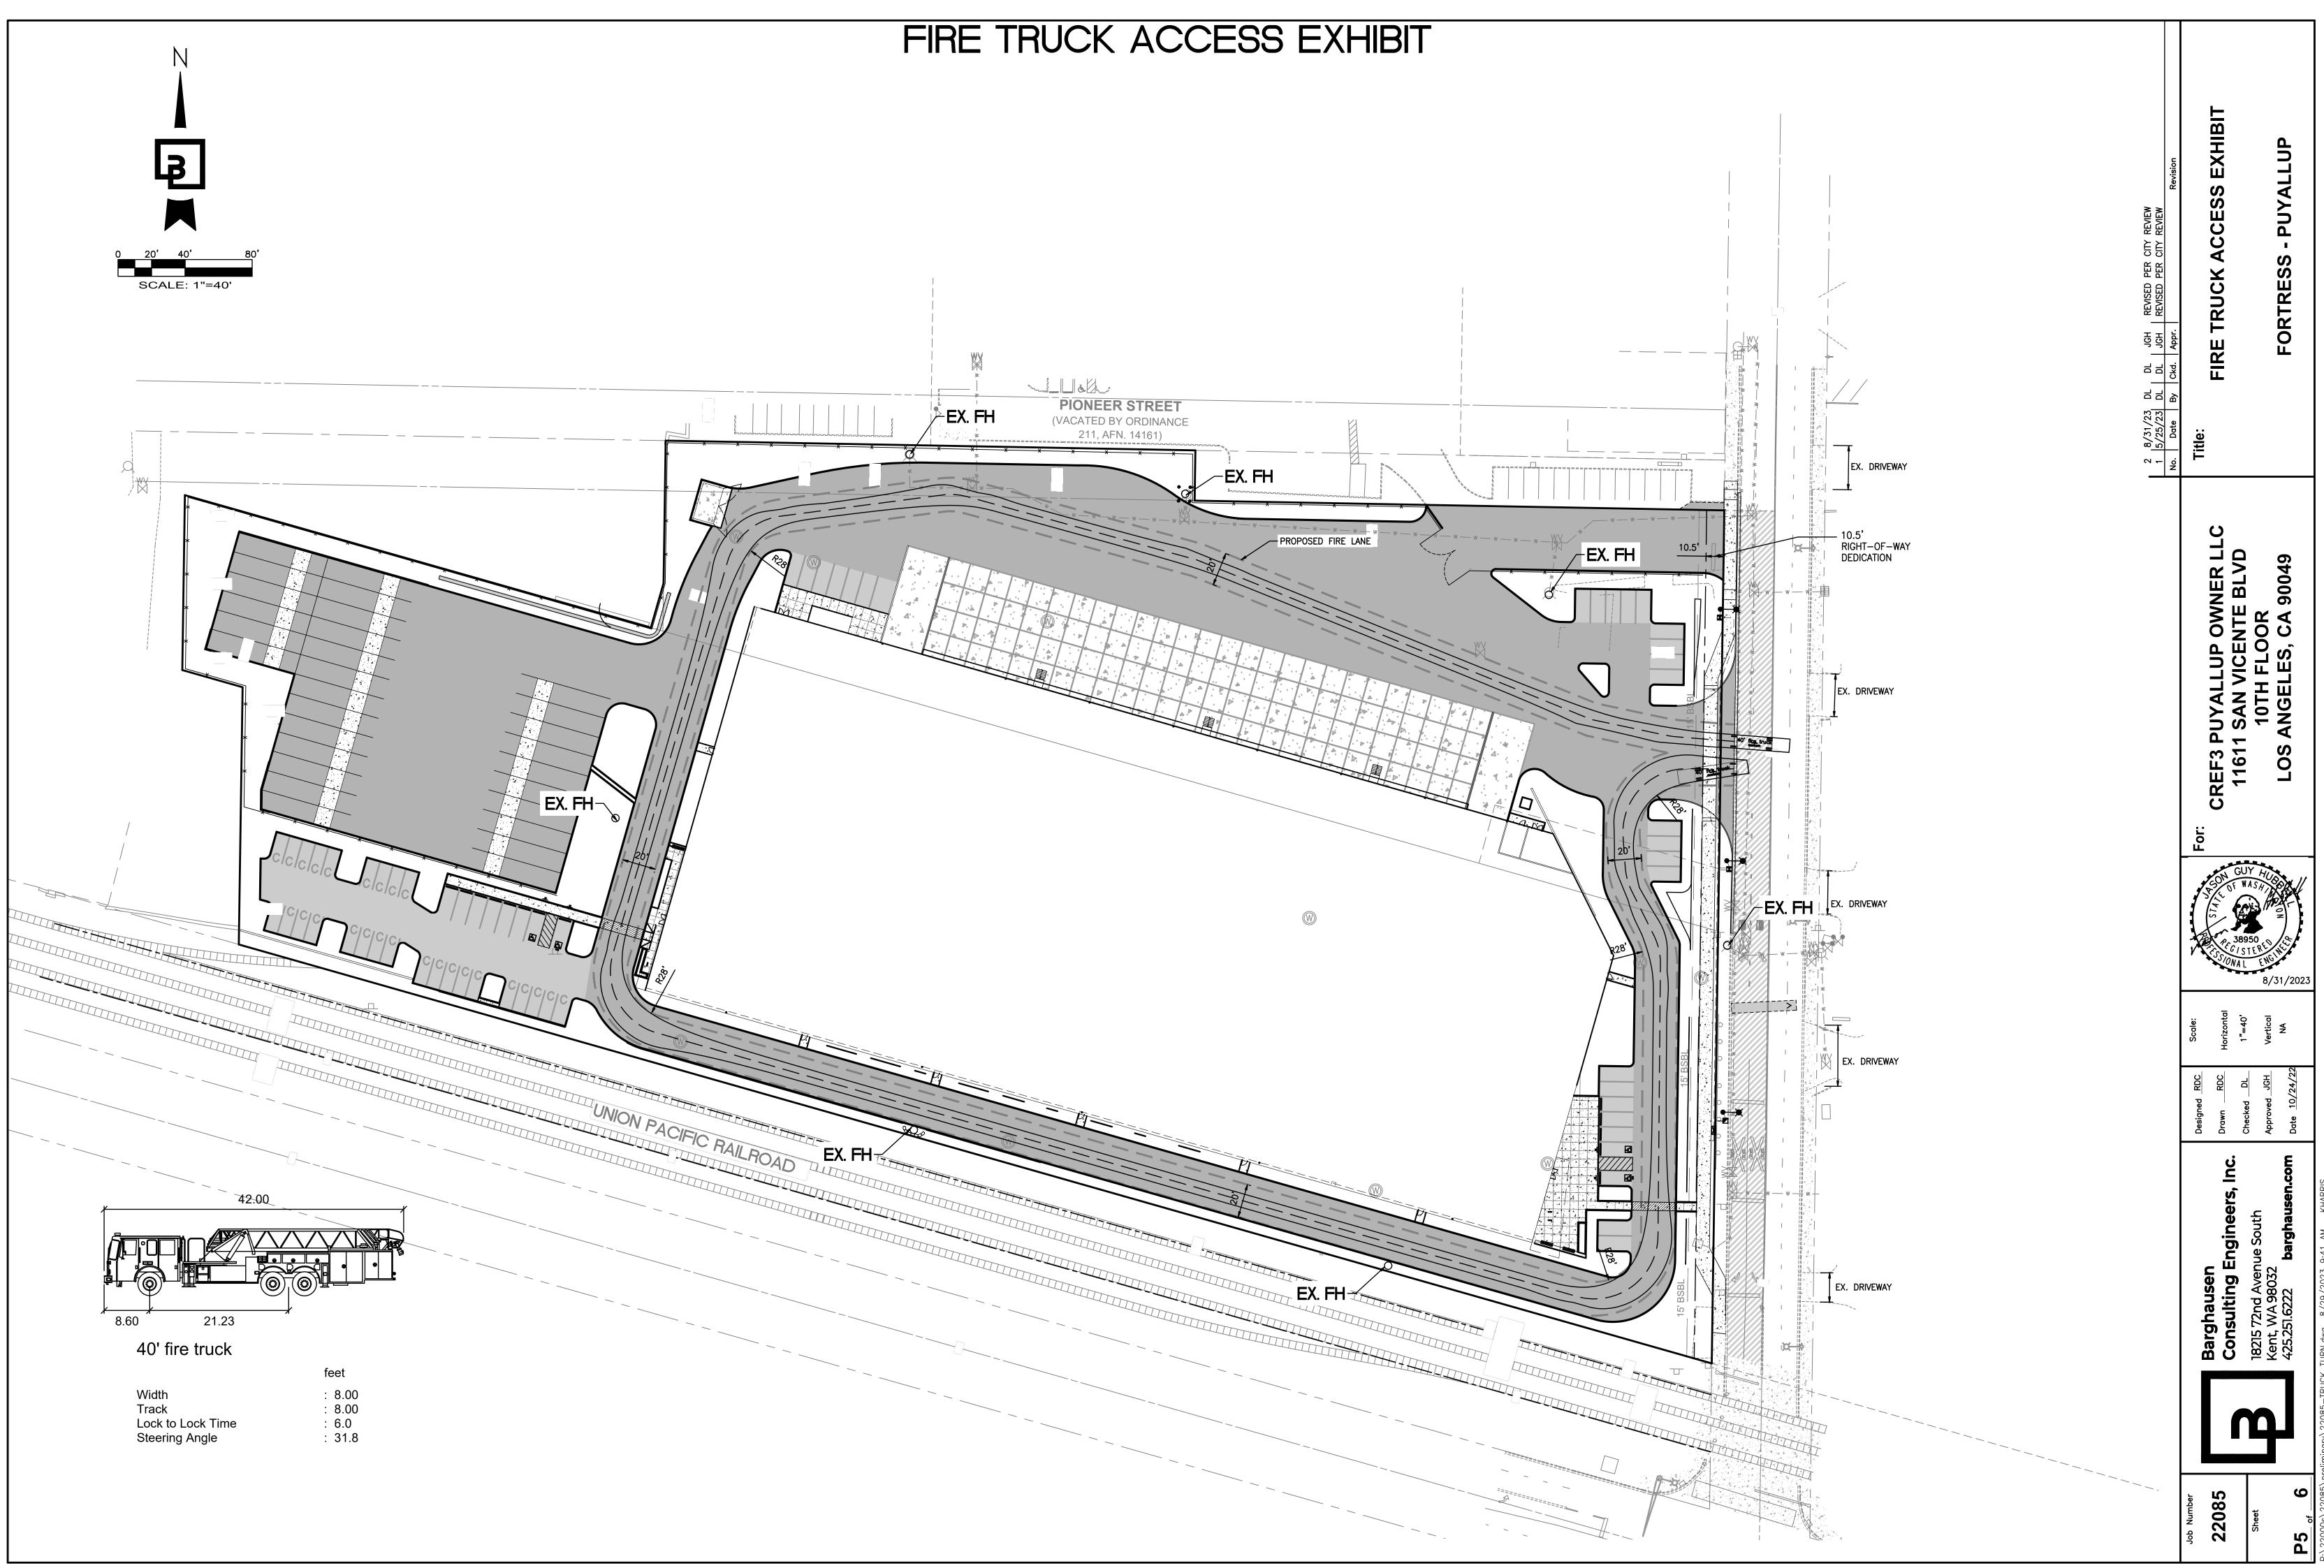


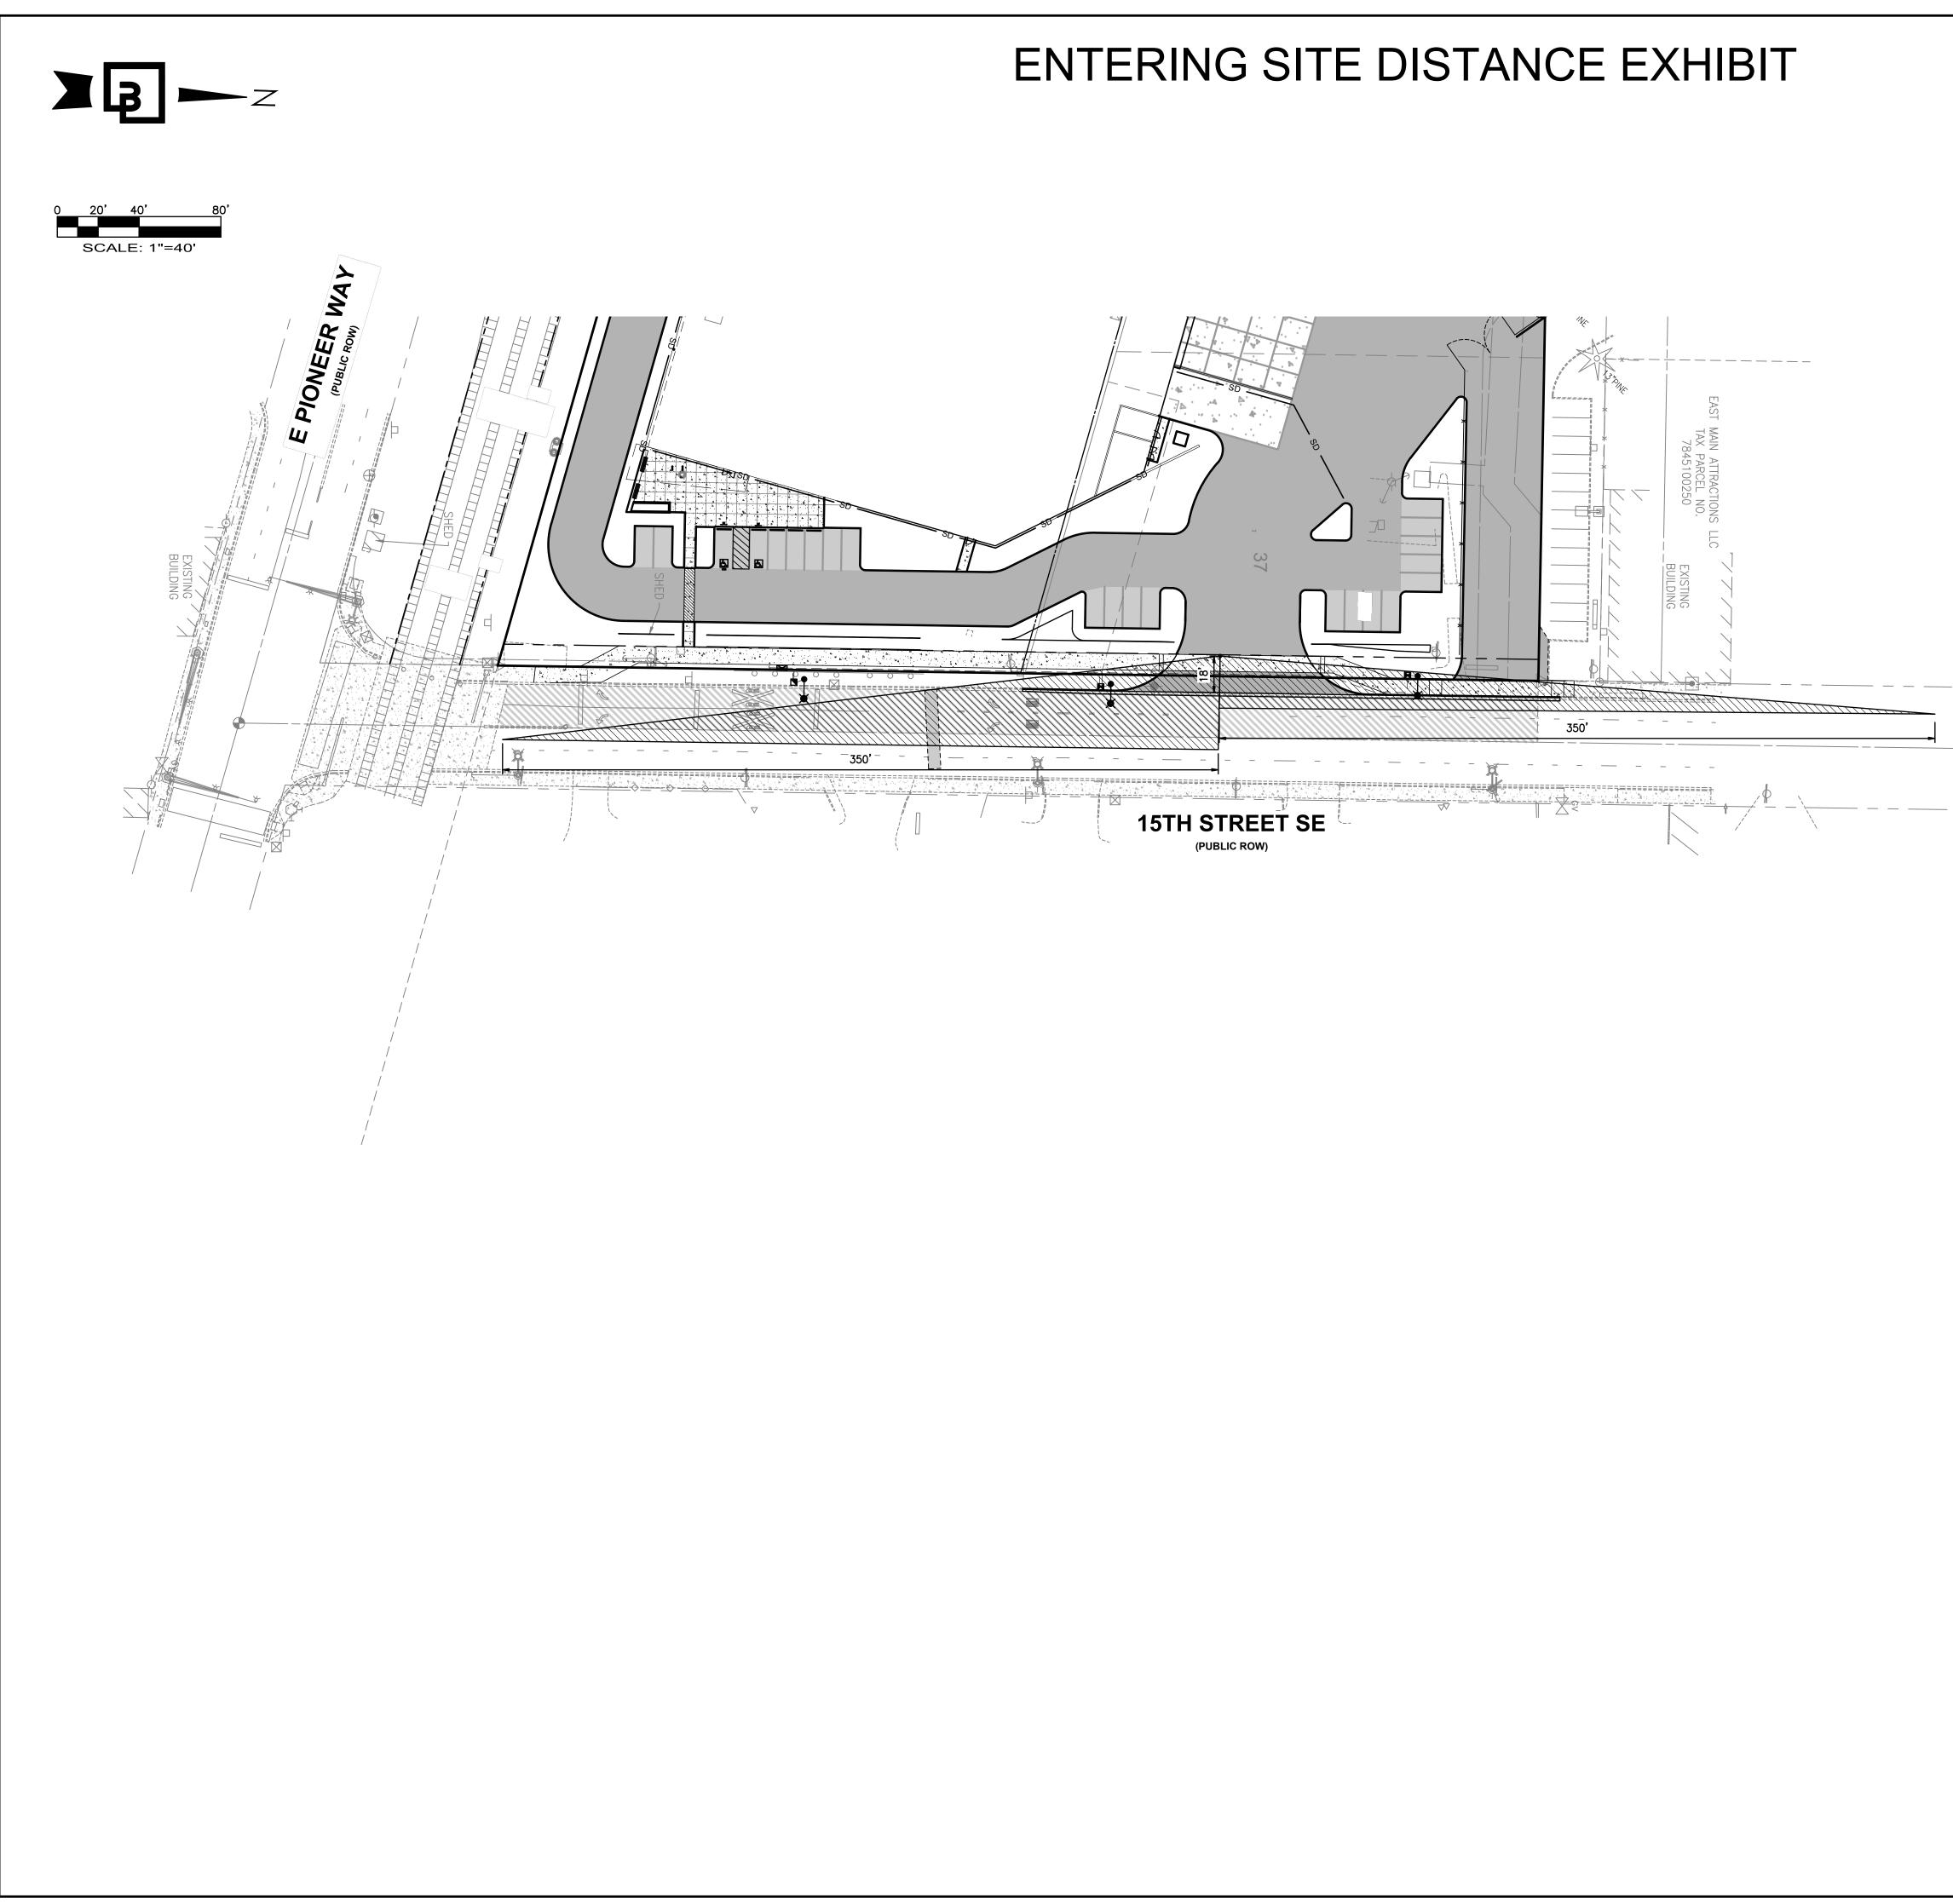


	2 8/31/23 DL DL JGH REVISED PER CITY REVIEW 1 5/25/23 DL DL JGH REVISED PER CITY REVIEW No. Date By Ckd. Appr. Revision	Title: ENTERING SITE DISTANCE EXHIBIT FORTRESS - PUYALLUP
		For: CREF3 PUYALLUP OWNER LLC 11611 SAN VICENTE BLVD 10TH FLOOR LOS ANGELES, CA 90049
		Designed RDC Bold RDC Horizontal Drawn RDC Horizontal Horizontal Checked DL 1"=40' 1"=40' Approved JGH Vertical N/A Date 10/24/22 N/A Vertical
Know what's below. Call before you dig. Dia 811		Job Number2208522085SheetSheetBaghausenSheetBaghausenSheetBaghausenBaghausenSheetBaghausenBaghausenBaghausenBaghausenBaghausenBaghausenPiBaghausenPiBaghausenPiBaghausen <td< td=""></td<>

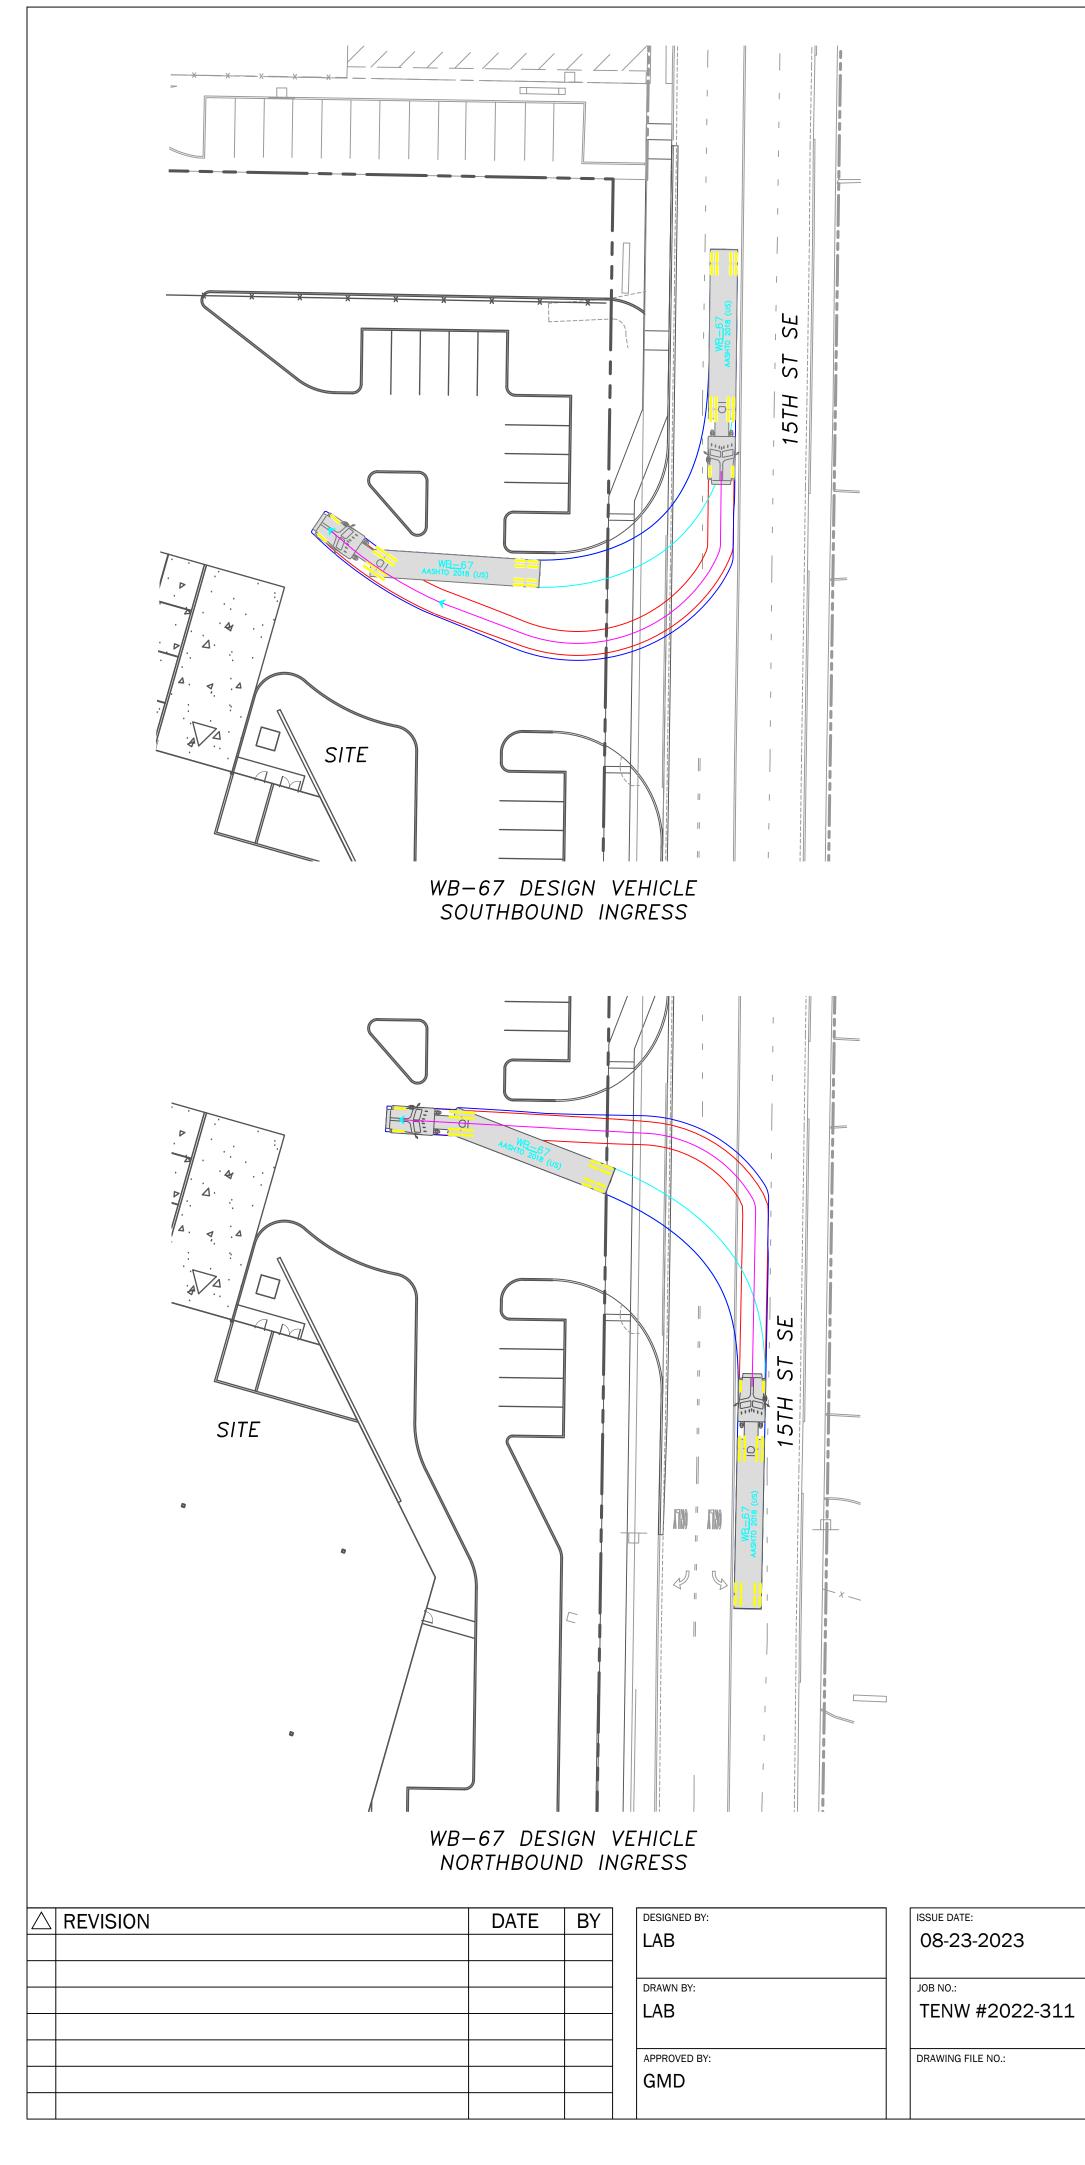

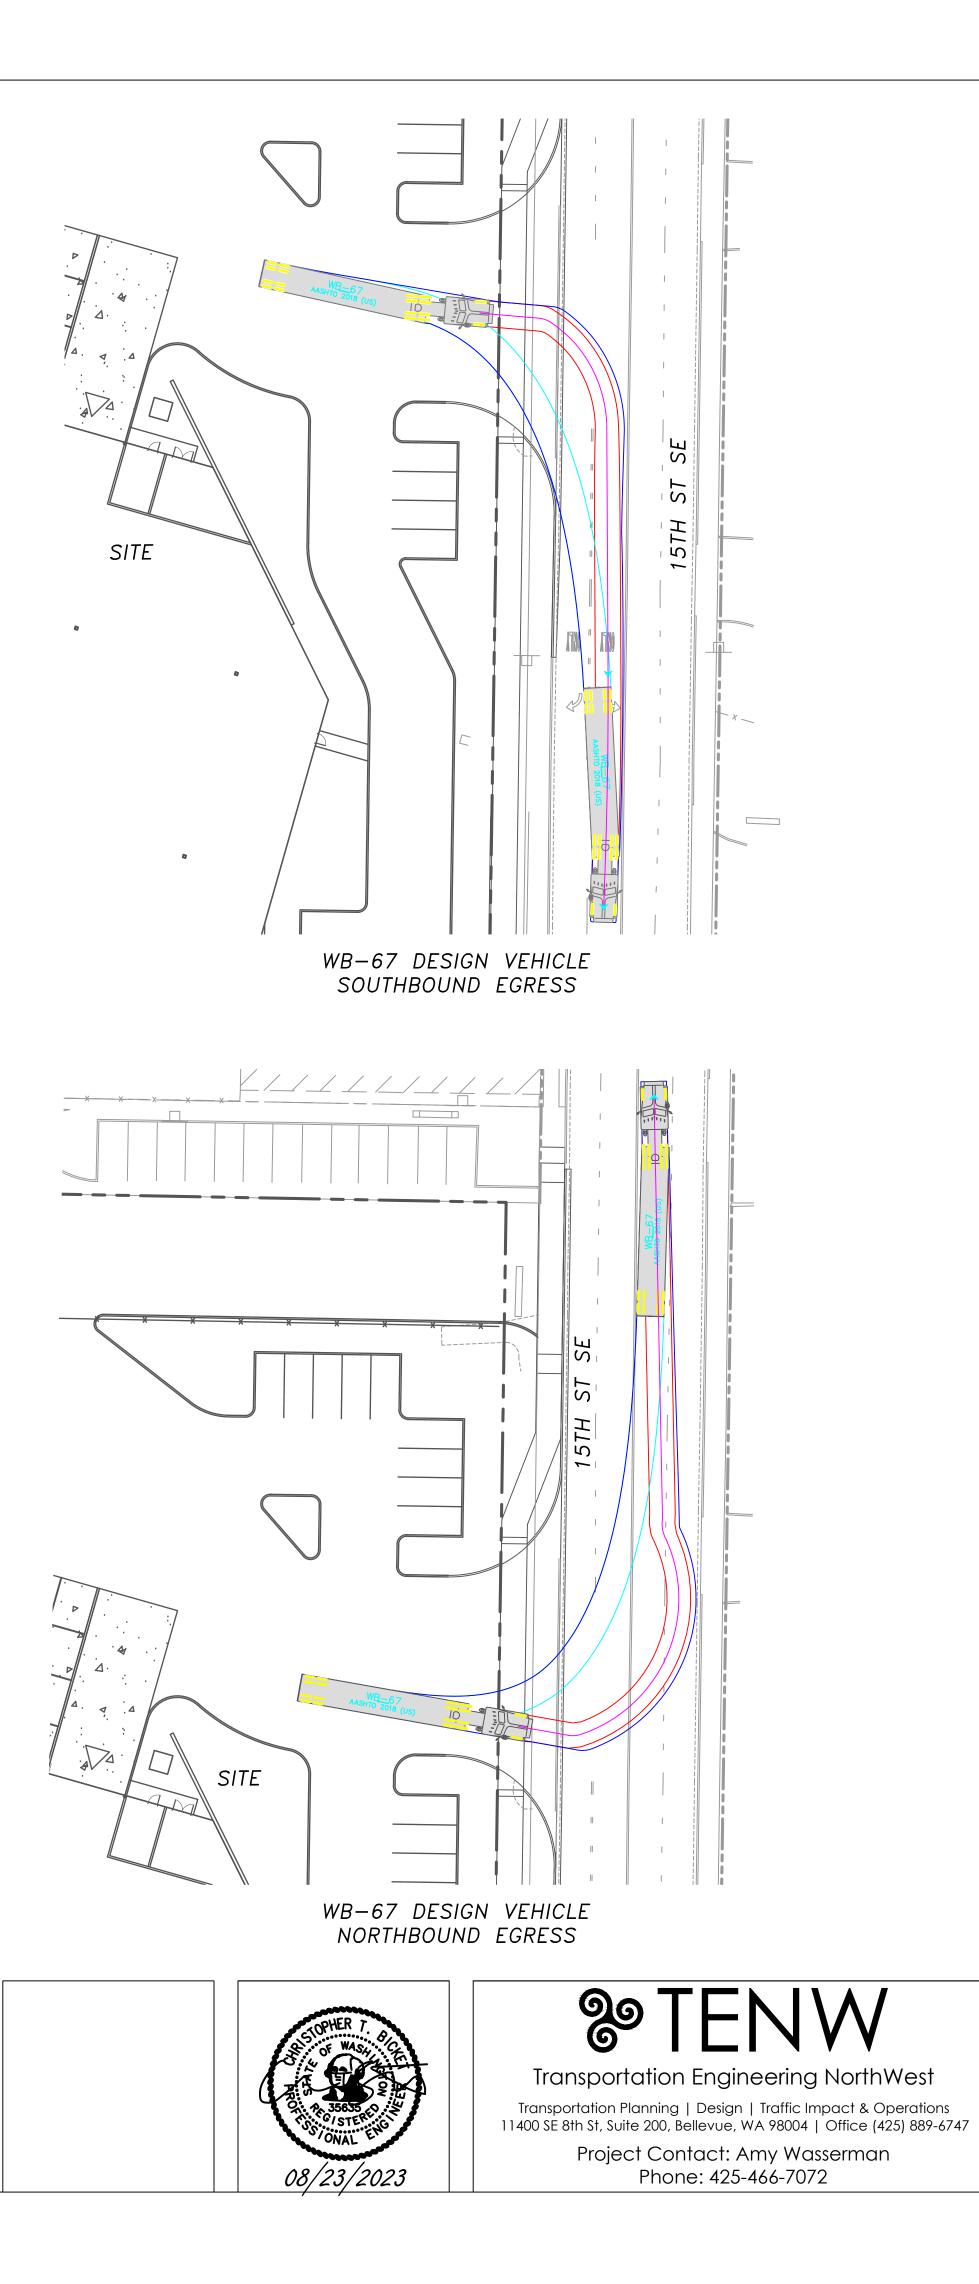

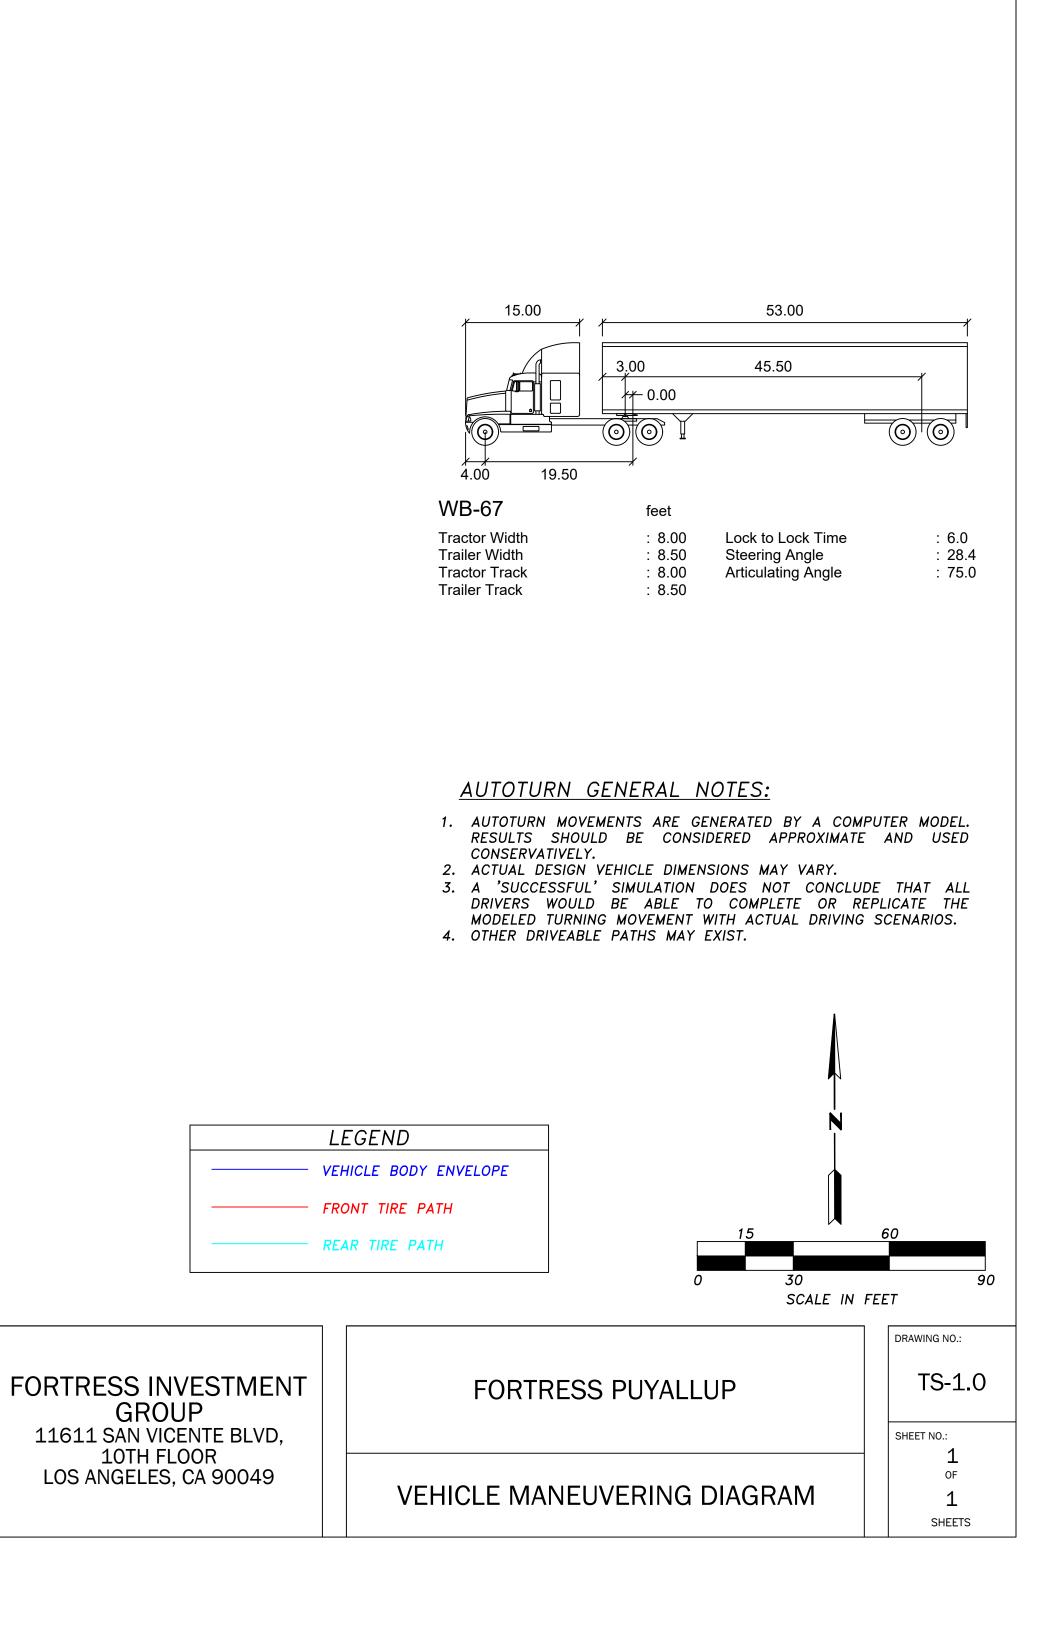

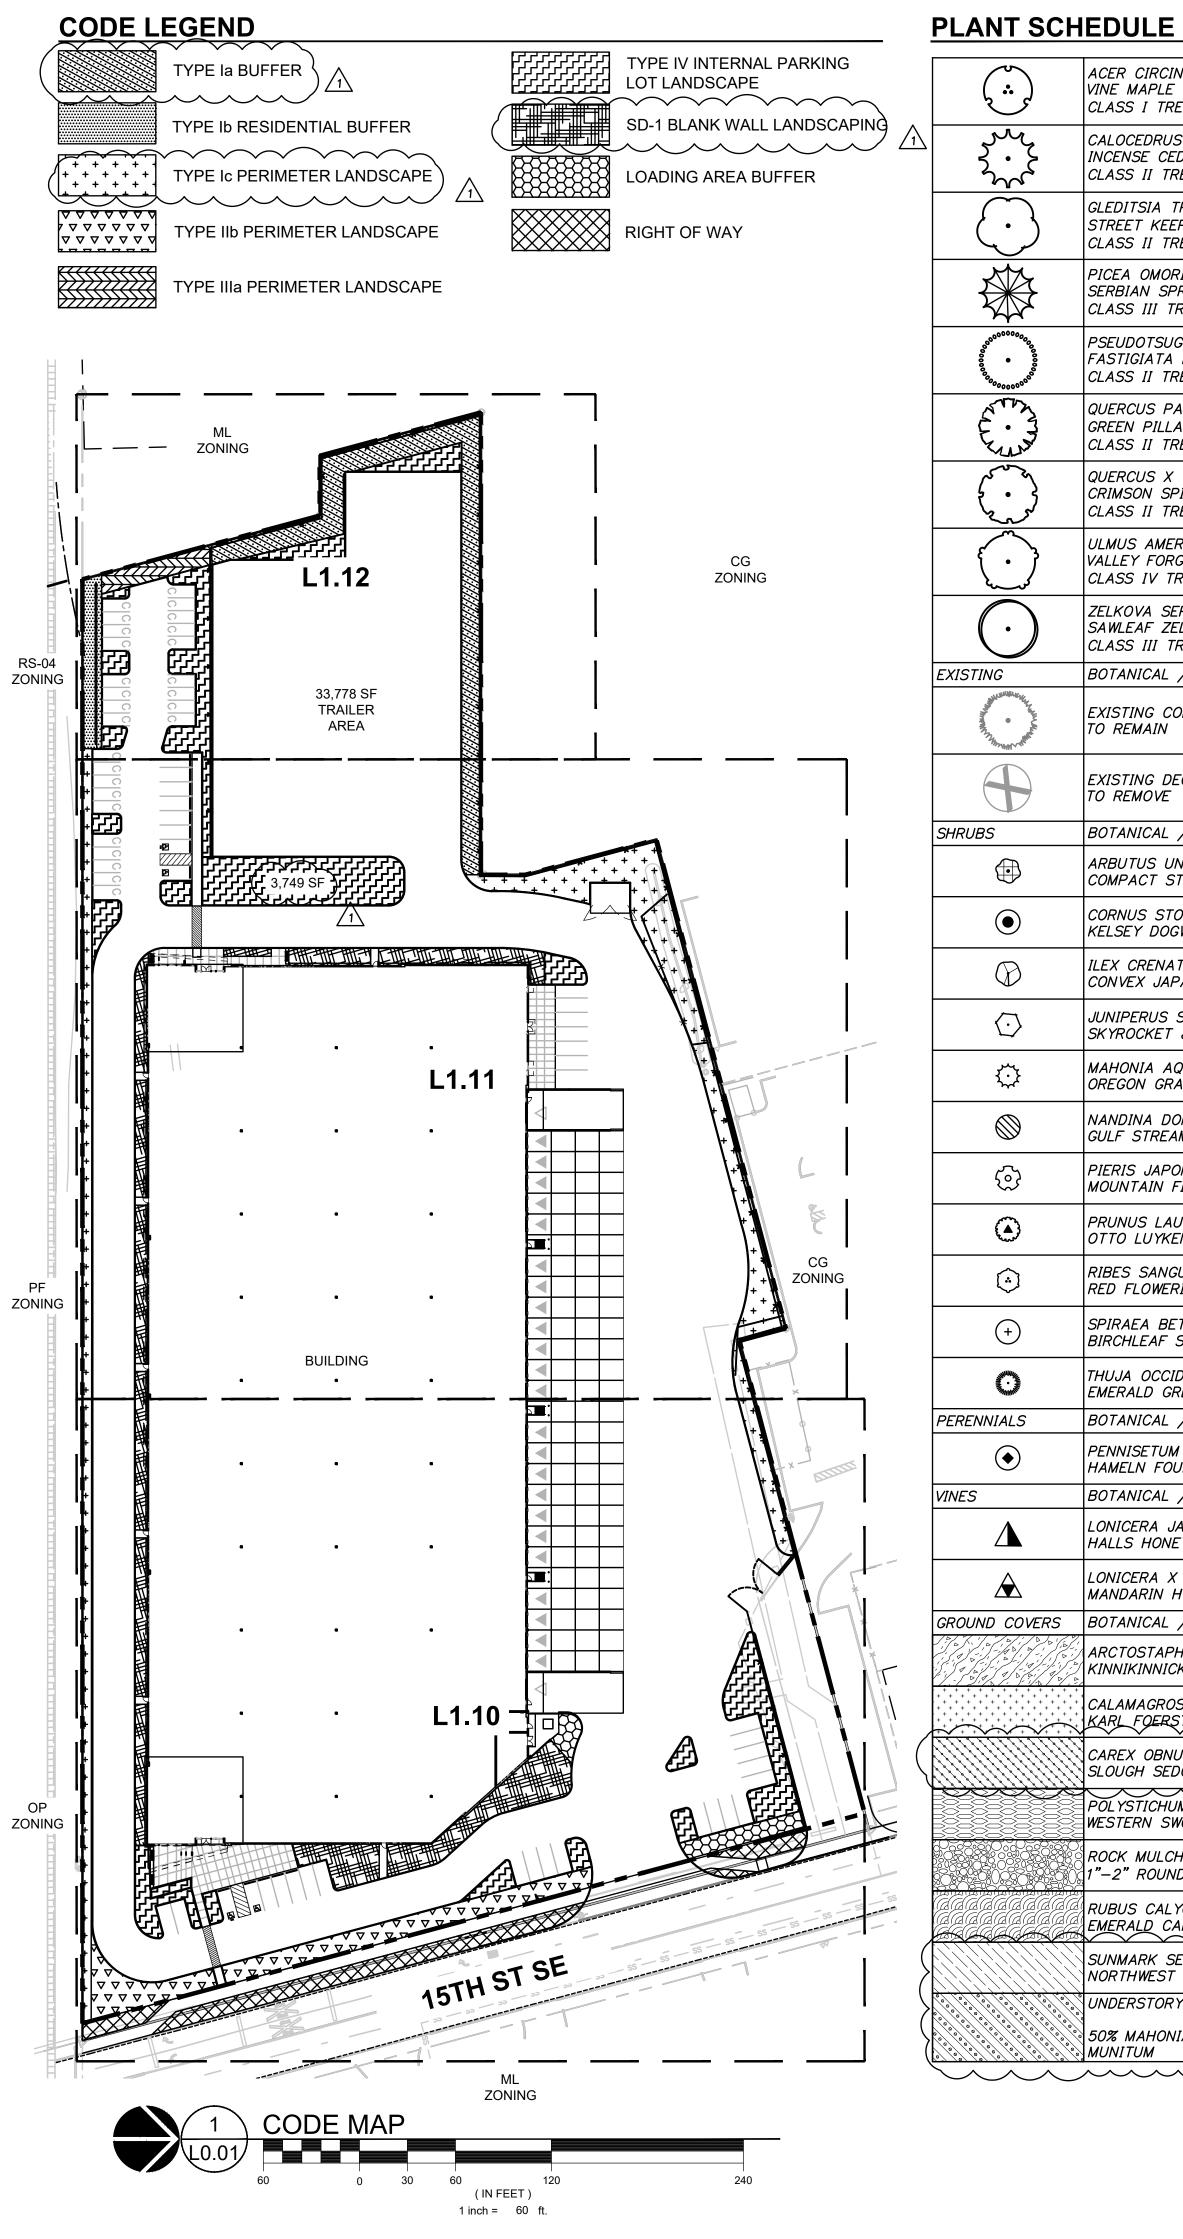

EDULE			
ACER CIRCINATUM VINE MAPLE CLASS I TREE (15' H X 10' W)	2" CAL. B&B	5	13
CALOCEDRUS DECURRENS INCENSE CEDAR CLASS II TREE (50' H X 15' W)	8' HT. MIN. B&B		39
GLEDITSIA TRIACANTHOS INERMIS 'DRAVES' STREET KEEPER® HONEY LOCUST CLASS II TREE (45' H X 20' W)	2" CAL., B&B		25
PICEA OMORIKA SERBIAN SPRUCE CLASS III TREE (50' H X 20' W)	8' HT. MIN. B&B		28
PSEUDOTSUGA MENZIESII 'FASTIGIATA' FASTIGIATA DOUGLAS FIR CLASS II TREE (45' H X 15' W)	6' HT. MIN. B&B		17
QUERCUS PALUSTRIS 'PRINGREEN' GREEN PILLAR® PIN OAK CLASS II TREE (45' H X 15' W)	2" CAL., B&B		7
QUERCUS X 'CRIMSCHMIDT' CRIMSON SPIRE™ OAK CLASS II TREE (45' H X 15' W)	2" CAL. B&B		13
ULMUS AMERICANA 'VALLEY FORGE' VALLEY FORGE AMERICAN ELM CLASS IV TREE (80' H X 60' W)	2" CAL. B&B		6
ZELKOVA SERRATA 'VILLAGE GREEN' SAWLEAF ZELKOVA CLASS III TREE (40' H X 40' W)	2" CAL., B&B		21
BOTANICAL / COMMON NAME	SIZE		QTY
EXISTING CONIFER TREE TO REMAIN			6
EXISTING DECIDUOUS TREE TO REMOVE			2
BOTANICAL / COMMON NAME	SIZE	SPACING	QTY
ARBUTUS UNEDO 'COMPACTA' COMPACT STRAWBERRY TREE	5 GAL.	60" o.c.	119
CORNUS STOLONIFERA 'KELSEYI' KELSEY DOGWOOD	3 GAL.	24" o.c.	373
ILEX CRENATA CONVEXA CONVEX JAPANESE HOLLY	5 GAL. 48" HT. MIN.	48" o.c.	78
JUNIPERUS SCOPULORUM 'SKYROCKET' SKYROCKET JUNIPER	8' HT. MIN.	48" o.c.	28
MAHONIA AQUIFOLIUM OREGON GRAPE	5 GAL. 48" HT. MIN.	48" o.c.	189
NANDINA DOMESTICA 'GULF STREAM' GULF STREAM HEAVENLY BAMBOO	3 GAL.	36" o.c.	31
PIERIS JAPONICA MOUNTAIN FIRE MOUNTAIN FIRE JAPANESE PIERIS	3 GAL.	60" o.c.	90 2
PRUNUS LAUROCERASUS 'OTTO LUYKEN' OTTO LUYKEN LAUREL	3 GAL.	42" o.c.	102
RIBES SANGUINEUM RED FLOWERING CURRANT	5 GAL.	48" o.c.	108
SPIRAEA BETULIFOLIA 'TOR' BIRCHLEAF SPIREA	3 GAL.	30" o.c.	324
THUJA OCCIDENTALIS 'SMARAGD' EMERALD GREEN ARBORVITAE	8' HT. MIN.	48" o.c.	156
BOTANICAL / COMMON NAME	SIZE	SPACING	QTY
PENNISETUM ALOPECUROIDES 'HAMELN' HAMELN FOUNTAIN GRASS	1 GAL.	24" o.c.	90 {
BOTANICAL / COMMON NAME	SIZE	SPACING (QTY
LONICERA JAPONICA 'HALLIANA' HALLS HONEYSUCKLE FLOWERING VINE	1 GAL.	24" o.c.	19 {
LONICERA X 'MANDARIN' MANDARIN HONEYSUCKLE	1 GAL.		19
BOTANICAL / COMMON NAME ARCTOSTAPHYLOS UVA-URSI	SIZE	SPACING	QTY
KINNIKINNICK	1 GAL.		1,321 SF
KARL FOERSTER FEATHER REED GRASS	1 GAL.	24" o.c.	1,842 SF)
CAREX OBNUPTA SLOUGH SEDGE	1 GAL.	18" o.c.	1,192 SF
POLYSTICHUM MUNITUM WESTERN SWORD FERN	3 GAL.	24" o.c.	,6,152 SF
ROCK MULCH MAINTENANCE BAND 1"–2" ROUND ROCK			21,685 SF
RUBUS CALYCINOIDES 'EMERALD CARPET' EMERALD CARPET CREEPING BRAMBLE	1 GAL.	18" o.c.	.13,842 SF {
SUNMARK SEEDS NORTHWEST LAWN MIX	8LBS/1000SF		4,444 SF
UNDERSTORY BLEND			

LANDSCAPE NOTES

- **GENERAL** CONTRACTOR SHALL CONFIRM ALL EXISTING CON 1. WORK.
- CALL BEFORE YOU DIG. CONTRACTOR SHALL VERI 2. UNDERGROUND UTILITIES AND NOTIFY LANDSCAP DISCREPANCIES WITH PLANTING ROOT ZONES. TO PROPOSED EXCAVATION CALL 1-800-424-5555 (OR
- 3. NOTIFY THE OWNER OR OWNER'S REPRESENTATIN CONFLICTS WITH EXISTING CONDITIONS PRIOR TO
- 4. LOCATION OF EXISTING TREES SHALL BE VERIFIED PRIOR TO COMMENCEMENT OF WORK. VEGETATION PROTECTION SHALL BE INSTALLED F
- STACKING, STORING, STOCKPILING, OR ACCUMULA PROHIBITED IN THE ROOT PROTECTION ZONE. SEE AND PUYALLUP APPENDIX 20 FOR TREE PROTECTI SITES.
- DAMAGE TO EXISTING CONCRETE CURB, ASPHALT SHALL BE REPAIRED OR REPLACED TO PRE CONST
- 7. CONTRACTOR SHALL COORDINATE WITH THE OWN CIRCULATION PRIOR TO COMMENCEMENT OF ANY <u>PLANTING</u>
- 1. ALL EXISTING TREES, PLANTS, AND ROOTS SHALL FROM ANY CONSTRUCTION PREPARATION, REMOV WITHIN AND ADJACENT TO PROJECT LIMITS.
- SHRUBS ADJACENT TO PARKING AREAS SHALL BE 2. THE BACK OF CURB. SHRUBS AND GROUNDCOVER SHALL BE PLANTED A MINIMUM OF ONE HALF THEIR PAVEMENT EDGE.
- ALL PLANT MATERIAL SHALL BE HEALTHY NURSER ROOTED, FULL FOLIAGE, FREE FROM INSECTS, DIS INJURIES AND DEFECTS WITH NO LESS THAN MININ STANDARDS FOR NURSERY STOCK, ANSI Z60.1-200 SHALL BE TALL ENOUGH TO BE LIMBED UP TO AT L GRADE WHILE MAINTAINING ENOUGH BRANCHES
- TO NOT PLANT TREES ABOVE WATERLINES, UTILIT PIPING.
- IF DISTURBANCE IS NECESSARY AROUND EXISTING PROTECT THE CROWN AND ALL WORK WITHIN THE TO THE USE OF HAND TOOLS AND MANUAL EQUIPM
- REPLACE, REPAIR AND RESTORE DISTURBED LAND TRENCHING OR OTHER REASONS TO PRE-CONSTR
-) MATERIAL APPROVED BY THE OWNER AND OWNER
- \setminus EXISTING AREAS PROPOSED FOR NEW PLANT MAT LEGALLY DISPOSED UNLESS SO NOTED.
- A SOILS ANALYSIS, BY AN INDEPENDENT SOILS TE , BY THE STATE DEPARTMENT OF AGRICULTURE, SH APPROPRIATE PLANTING SOIL AND/OR SPECIFIED
- ∖ TOPSOIL SHALL BE AMENDED AS RECOMMENDED | ABORATORY AND AS OUTLINED IN THE SPECIFIC ALL LANDSCAPED AREAS SHALL BE COVERED BY 10
- A DEPTH OF 4-INCHES. TAPER MULCH DEPTH DOW STARTING 12-INCHES FROM THE EDGE OF PAVEME RRIGATION
- 1. UNLESS OTHERWISE INDICATED, ALL NEW LANDSO A FULLY AUTOMATIC UNDERGROUND IRRIGATION FOR OPTIMUM EFFICIENCY.
- 2. CONTRACTOR SHALL SUBMIT SHOP DRAWINGS (IR ARCHITECT PRIOR TO CONSTRUCTION. DRAWINGS PER MINUTE, LATERAL LINES, AND BE AT MINIMUM CONTRACTOR TO DETERMINE STATIC WATER PRE-3.
- PREPARING SHOP DRAWINGS.
- CONTRACTOR SHALL ESTABLISH MINIMUM PRESSU REQUIREMENTS FOR IRRIGATION SYSTEM DESIGN IRRIGATION SCHEDULE.
- IRRIGATION SYSTEM AS DESIGNED AND INSTALLED 5 TOLERANCES AND SPECIFICATIONS OF THE SPECI
- SYSTEM SHALL BE DESIGNED TO SUPPLY MANUFA 6. OPERATING PRESSURE TO FARTHEST EMITTER FR
- SYSTEM SHALL PROVIDE HEAD TO HEAD COVERAC 7. BUILDING, FENCES, SIDEWALKS, PARKING AREAS, SURFACES.
- 8. ALL IRRIGATION PIPE MATERIAL AND INSTALLATIO CODE FOR PIPING AND COMPONENT REQUIREMEN PROVIDE SLEEVING AT ALL AREAS WHERE PIPE TR 9.
- SURFACING. 10. VALVES SHALL BE WIRED AND INSTALLED PER MAI
- INSTALLATION PROCEDURES AND CONNECTED TO 11. REFER TO CIVIL DETAILS AND DETAILS ON L5.10 FO
- BACKFLOW PREVENTION INFORMATION.
- 12. MAINLINE LAYOUT IS DIAGRAMMATIC ONLY.
- 13. CONTROLLER TO BE MOUNTED ON BUILDING EXTE COORDINATE LOCATION WITH OWNER'S REPRESE
- 14. ZONE THE FOLLOWING AREAS SEPARATELY: TEMP LANDSCAPE AREAS, AND TREES.
- 15. QUICK COUPLERS TO BE PLACED EVERY 300 LINEA IRRIGATION SHALL BE WINTERIZED THROUGH LOW 16.
- BLOWOUT CONNECTION THROUGH QUICK COUPLE
- 17. THE SYSTEM SHALL BE GRAVITY DRAINED. THE CO APPROPRIATE MANUAL DRAINS AT LOW POINTS.

	SHEET INDEX		
NDITIONS PRIOR TO COMMENCING	L0.01 LANDSCAPE GENERAL INFORMATION L1.10 PLANTING PLAN EAST L1.11 PLANTING PLAN CENTRAL L1.12 PLANTING PLAN WEST		
RIFY INVERT ELEVATIONS OF ALL PE ARCHITECT IF THERE ARE ANY O REQUEST LOCATES FOR R 811) IN WASHINGTON.	L1.20 MATERIALS AND LAYOUT PLAN L5.10 SITE DETAILS L5.11 SOIL DETAILS L5.12 IRRIGATION DETAILS		Architecture - Interiors
TIVE OF ANY DISCREPANCIES OR O COMMENCEMENT OF ANY WORK.	L5.13 PLANTING DETAILS L5.14 STREET PLANTING DETAILS		Planning - Engineering
ED IN THE FIELD BY THE CONTRACTOR		ONS	
PRIOR TO ANY WORK COMMENCING. LATION OF GOODS OR MATERIALS IS EE TREE PROTECTION DETAIL 9/L5.13 TION STANDARDS ON CONSTRUCTION	ANSI AMERICAN NATIONAL GAL STANDARDS INSTITUTE MIX B&B BALL AND BURLAP POC CAL CALIPER PVC	MIXTURE POINT OF CONNECTION	Portland, OR 503.224.9560 Vancouver, WA
T PAVING, OR OTHER STRUCTURE	² SITE INFORMATION		360.695.7879 Seattle, WA
STRUCTION CONDITIONS. WNER ANY DISRUPTION TO VEHICULAR IY WORK.	JURISDICTION STORMWATER ZONE	PUYALLUP, WA PUYALLUP 2015 ML	206.749.9993 www.mcknze.com
L BE PROTECTED FROM DAMAGE OVAL OR INSTALLATION ACTIVITIES	SITE AREA	341,226 SF (7.82 AC)	MACKENZIE DESIGN DRIVEN I CLIENT FOCUSED
E PLANTED 2 FT MINIMUM AWAY FROM ER ALONG OTHER PAVEMENT EDGES EIR ON CENTER SPACING AWAY FROM	BUFFER WIDTH (15' HT MIN) EVERGREEN HEDGE (6' HT MIN) TWO TYPES NATIVE CONIFER TREES WALL OR FENCE (6' HT MIN)	15' AVE 8' HT PROVIDED 6' HT BLACK CHAIN LINK WITH SLATS	CREF3 PUYALLUP OWNER LLC
ERY STOCK, WELL BRANCHED AND ISEASES, WEEDS, WEED ROT, IIMUMS SPECIFIED IN AMERICAN 004.TREES IN THE RIGHT OF WAY LEAST 8 FT ABOVE DRIVE SURFACE TO SUPPORT HEALTHY GROWTH.	BUFFER TYPE Ib - RESIDENTIAL SCREEN TREES (1 PER 40 LF MAX) EVERGREEN TREES (75% MAX) WALL (6' HT MIN) TYPE Ic BUFFER - VISUAL BARRIER	109 LF 5 TREES (100%) 4 (80%) 6' HT 1,373 LF	
HIES, OR OTHER UNDERGROUND	TREES (45 FT MATURE HT MIN) EVERGREEN HEDGE (6 FT HT MIN) BUFFER WIDTH (6 FT MIN)	50 FT HT 6 FT 10-27 FT	
NG TREES, CONTRACTOR SHALL IE TREE DRIPZONE SHALL BE LIMITED PMENT ONLY.	TYPE IIb BUFFER - FRONTAGE TREES (30 FT OC MAX) TREES (50% EVERGREEN MIN) SHRUBS (EVERGREEN, 5 FT OC MAX)	320 LF 9 TREES (112%) 5 (55%) 160 SHRUBS	11611 SAN VICENTE BLVD 10TH ELOOR
NDSCAPE AREAS DUE TO GRADING, IRUCTION CONDITION AND PROVIDE ER'S REPRESENTATIVE. ATERIAL SHALL BE CLEARED AND	TYPE IIIa PERIMETER LANDSCAPE TREES (1 PER 40 LF) EVERGREEN (MAX 50%)	71 LF 2 TREES 1 (50%)	10TH FLOOR LOS ANGELES CA 90049
ESTING LABORATORY RECOGNIZED SHALL BE USED TO RECOMMEND AN	TYPE IV INTERNAL PARKING LOT LANDSCAPE OVERALL SITE AREA PAVED AREA	341,226 SF (100%) 156,745 SF (100%)	 Project
D SOIL AMENDMENTS. D BY AN INDEPENDENT SOILS TESTING CATION.	LANDSCAPE AREA (10% MIN) PARKING LOT LANDSCAPE AREA TRAILER LANDSCAPE AREA SD-1 LANDSCAPE AREA	22,495 SF (14.4%) 9,527 SF 3,749 SF 9,219 SF	FORTRESS - PUYALLUP
A LAYER OF WOOD CHIPS MULCH TO WN FROM 4-INCH TO 2-INCHES MENT.	TOTAL TREES TOTAL CONIFER TREES (50% MIN)	36 TREES (100%) 21 TREES (58.3%)	240 15TH ST SE
SCAPE AREAS TO BE IRRIGATED WITH N SYSTEM. PROVIDE LOOP SYSTEM	 TRAILER AREA* PAVED AREA LANDSCAPE AREA (10% MIN) *IN LIEU OF PROVIDING ISLANDS WITHIN THE EQUIVALENT AREA OF LANDSCAPE IS PROVID TRAILER AREA. 		PUYALLUP, WA, 98372
IRRIGATION PLANS) TO LANDSCAPE GS TO INDICATE HEAD TYPE, GALLONS M SCALE OF 1"=20'	SD-01 BLANK WALL LANDSCAPING		THE OF WASHING
ESSURE AT THE P.O.C. PRIOR TO SURE AND MAXIMUM DEMAND IN, AND PROVIDE INFORMATION IN AN	BLANK WALL SCREEN MITIGATION STAFF IS SUPPORTIVE OF REDUCING THE BLAN ALONG THE SOUTH SIDE OF THE BUILDING DEP THE FORM OF CU-STRUCTURAL SOIL IN A TOTAI THAT WHICH WOULD HAVE BEEN PROVIDED IF T	ENDENT UPON MITIGATION IN L SOIL VOLUME EQUAL TO	
ED SHALL PERFORM WITHIN THE	HAD BEEN INSTALLED.	100.5 LF	4NDSCAPE ARCH
CIFIED MANUFACTURERS. FACTURER'S SPECIFIED MINIMUM FROM WATER METER.	PER PMC 20.26.400(3) & 20.26.500(1) TREES (1 PER 15') SHRUBS (6' HT MIN)	6 TREES 6' FT HT	MACKENZIE 2023 ALL RIGHTS RESERVED
AGE WITHOUT OVERSPRAY ONTO 5, OR OTHER NON-VEGETATED			THESE DRAWINGS ARE THE PROPERTY OF MACKENZIE AND ARE NOT TO BE USED OR REPRODUCED IN ANY MANNER, WITHOUT PRIOR WRITTEN PERMISSION
ON SHALL CONFORM TO APPLICABLE ENTS.			REVISION SCHEDULE
FRAVELS UNDER CONCRETE OR HARD			Delta Issued As Issue Date
ANUFACTURER'S RECOMMENDED O THE IRRIGATION CONTROLLER. FOR POINT OF CONNECTION AND			1 PLAN CHECK 8/29/2023
FERIOR. GENERAL CONTRACTOR TO			
IPORARY AREAS, PERMANENT			
EAR FEET MAX.			SHEET TITLE:
W PRESSURE, HIGH VOLUME AIR LER. CONTRACTOR SHALL PROVIDE			LANDSCAPE GENERAL INFORMATION

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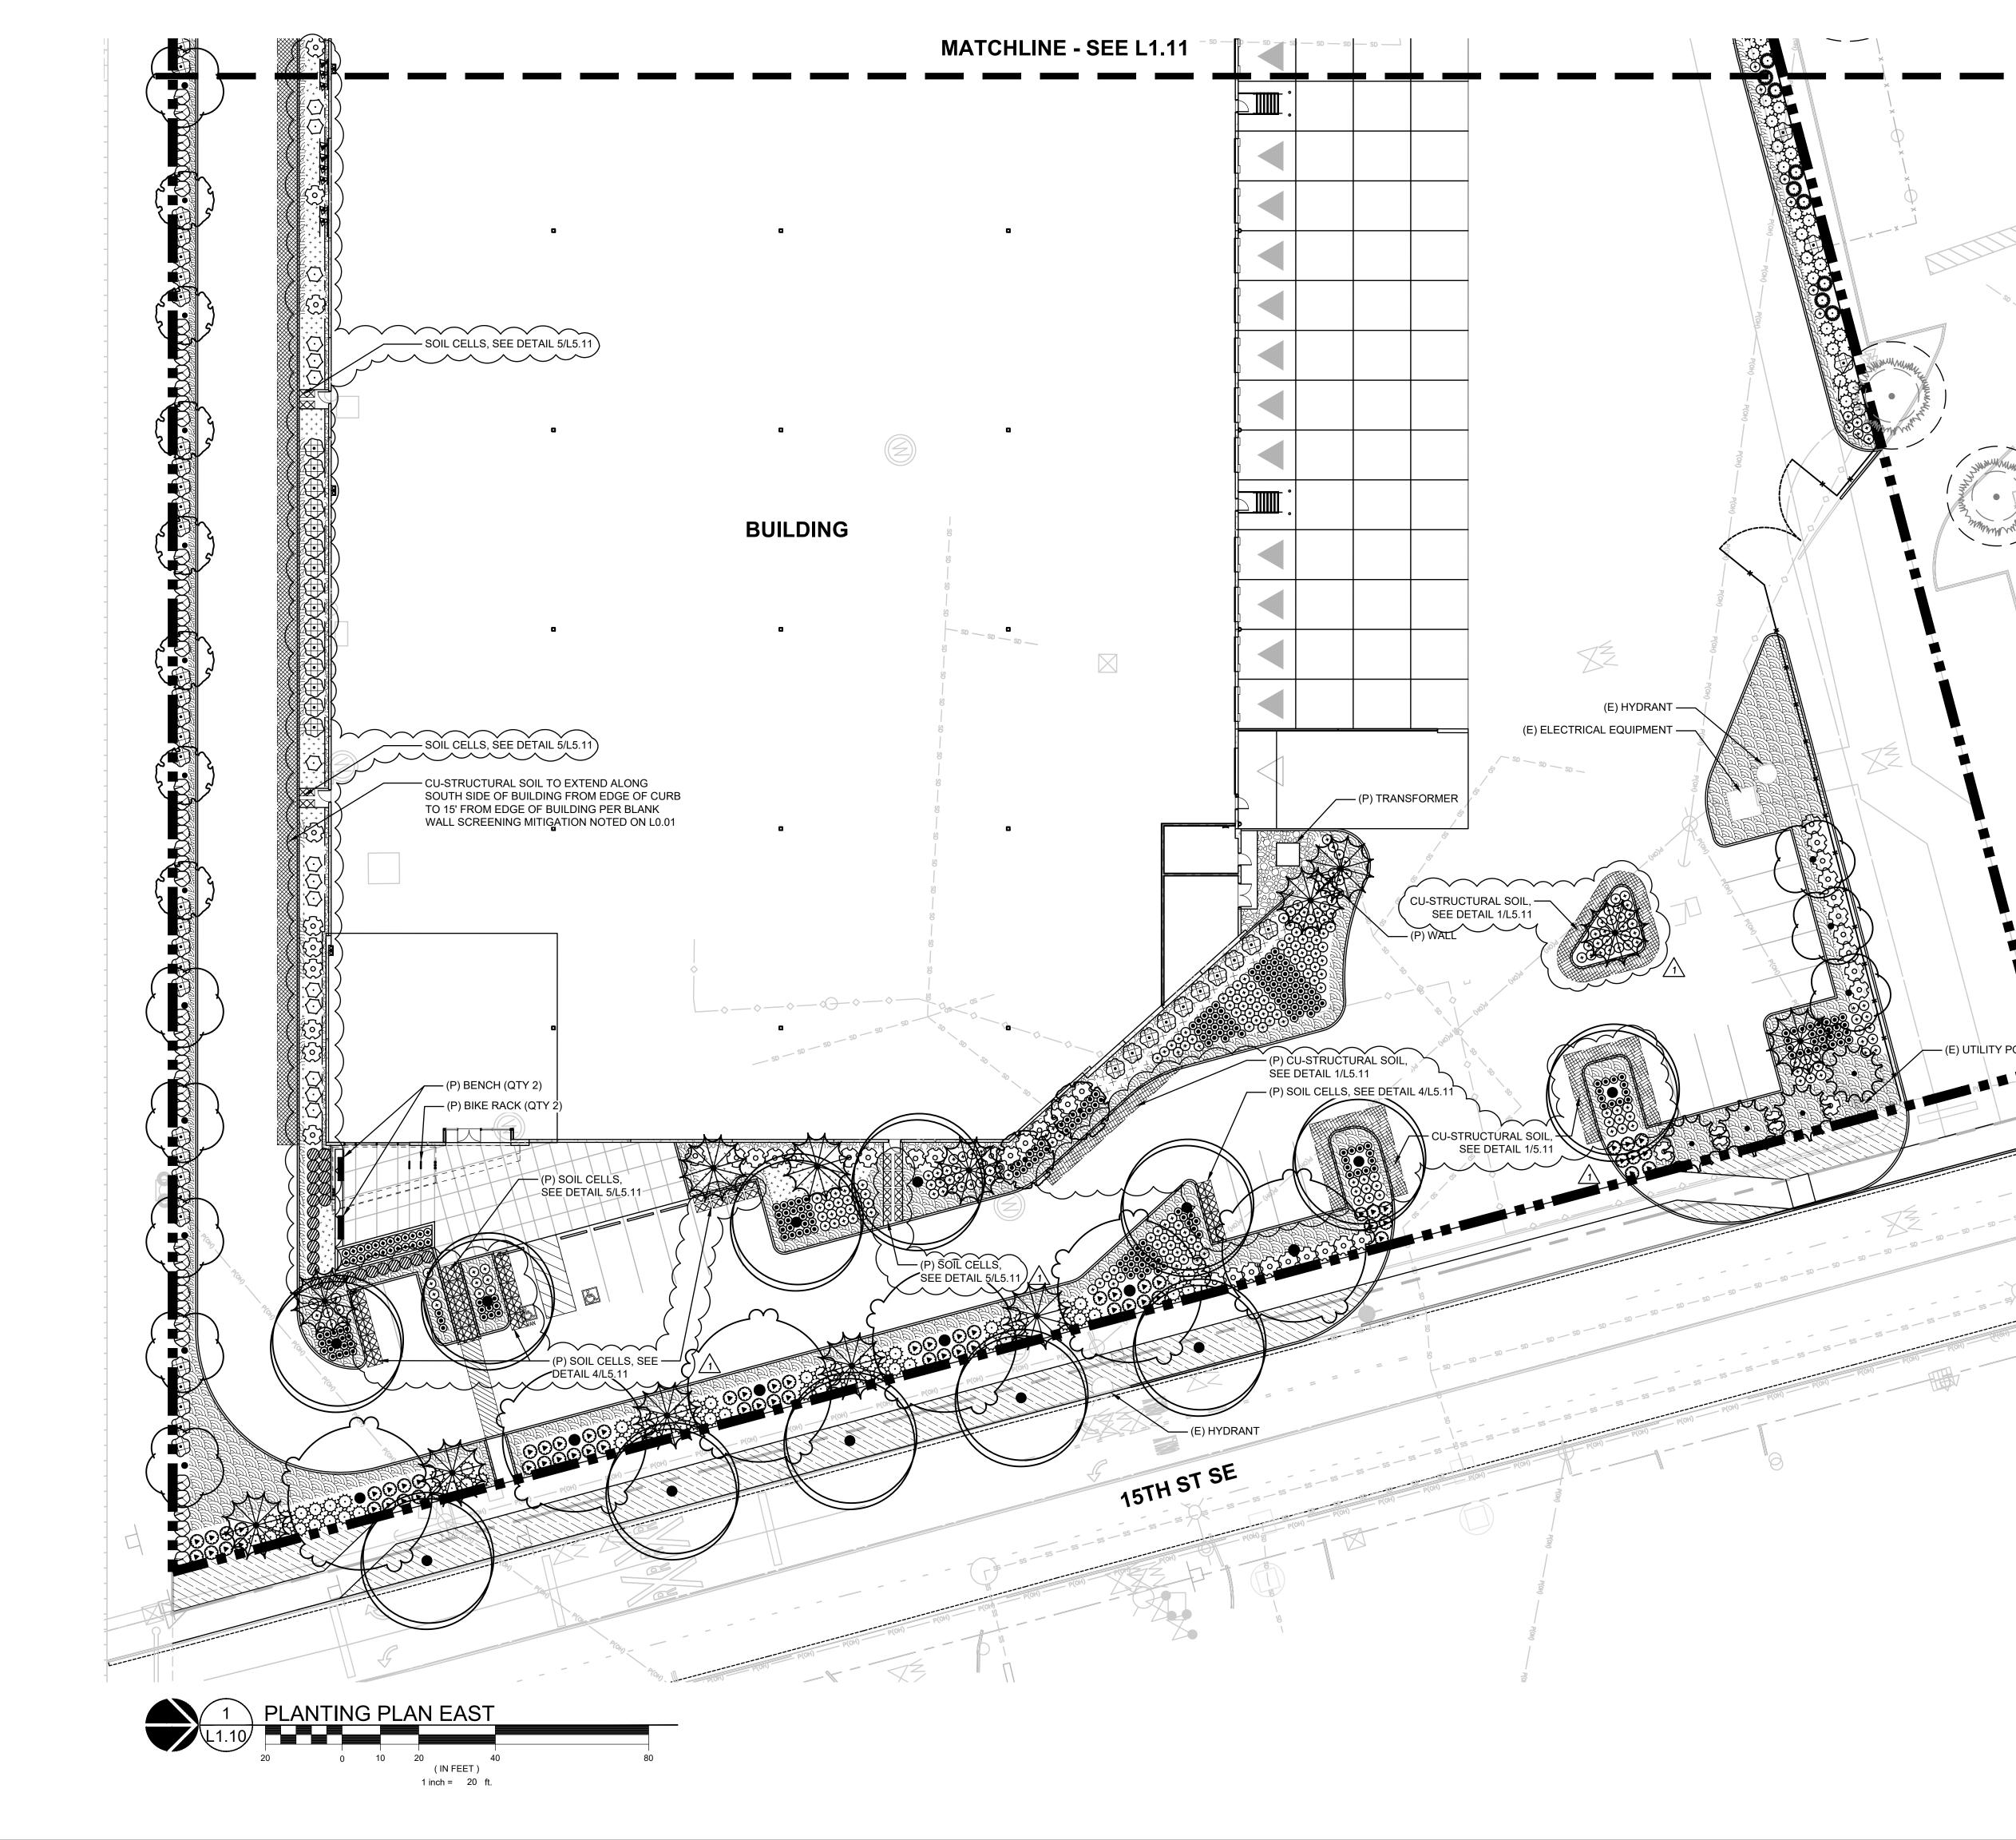
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L0.01

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Project FORTRESS -PUYALLUP

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SHEET TITLE: PLANTING PLAN

EAST

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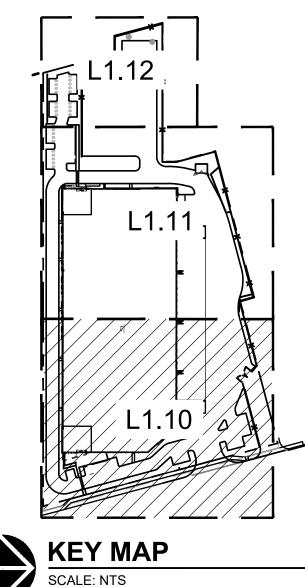
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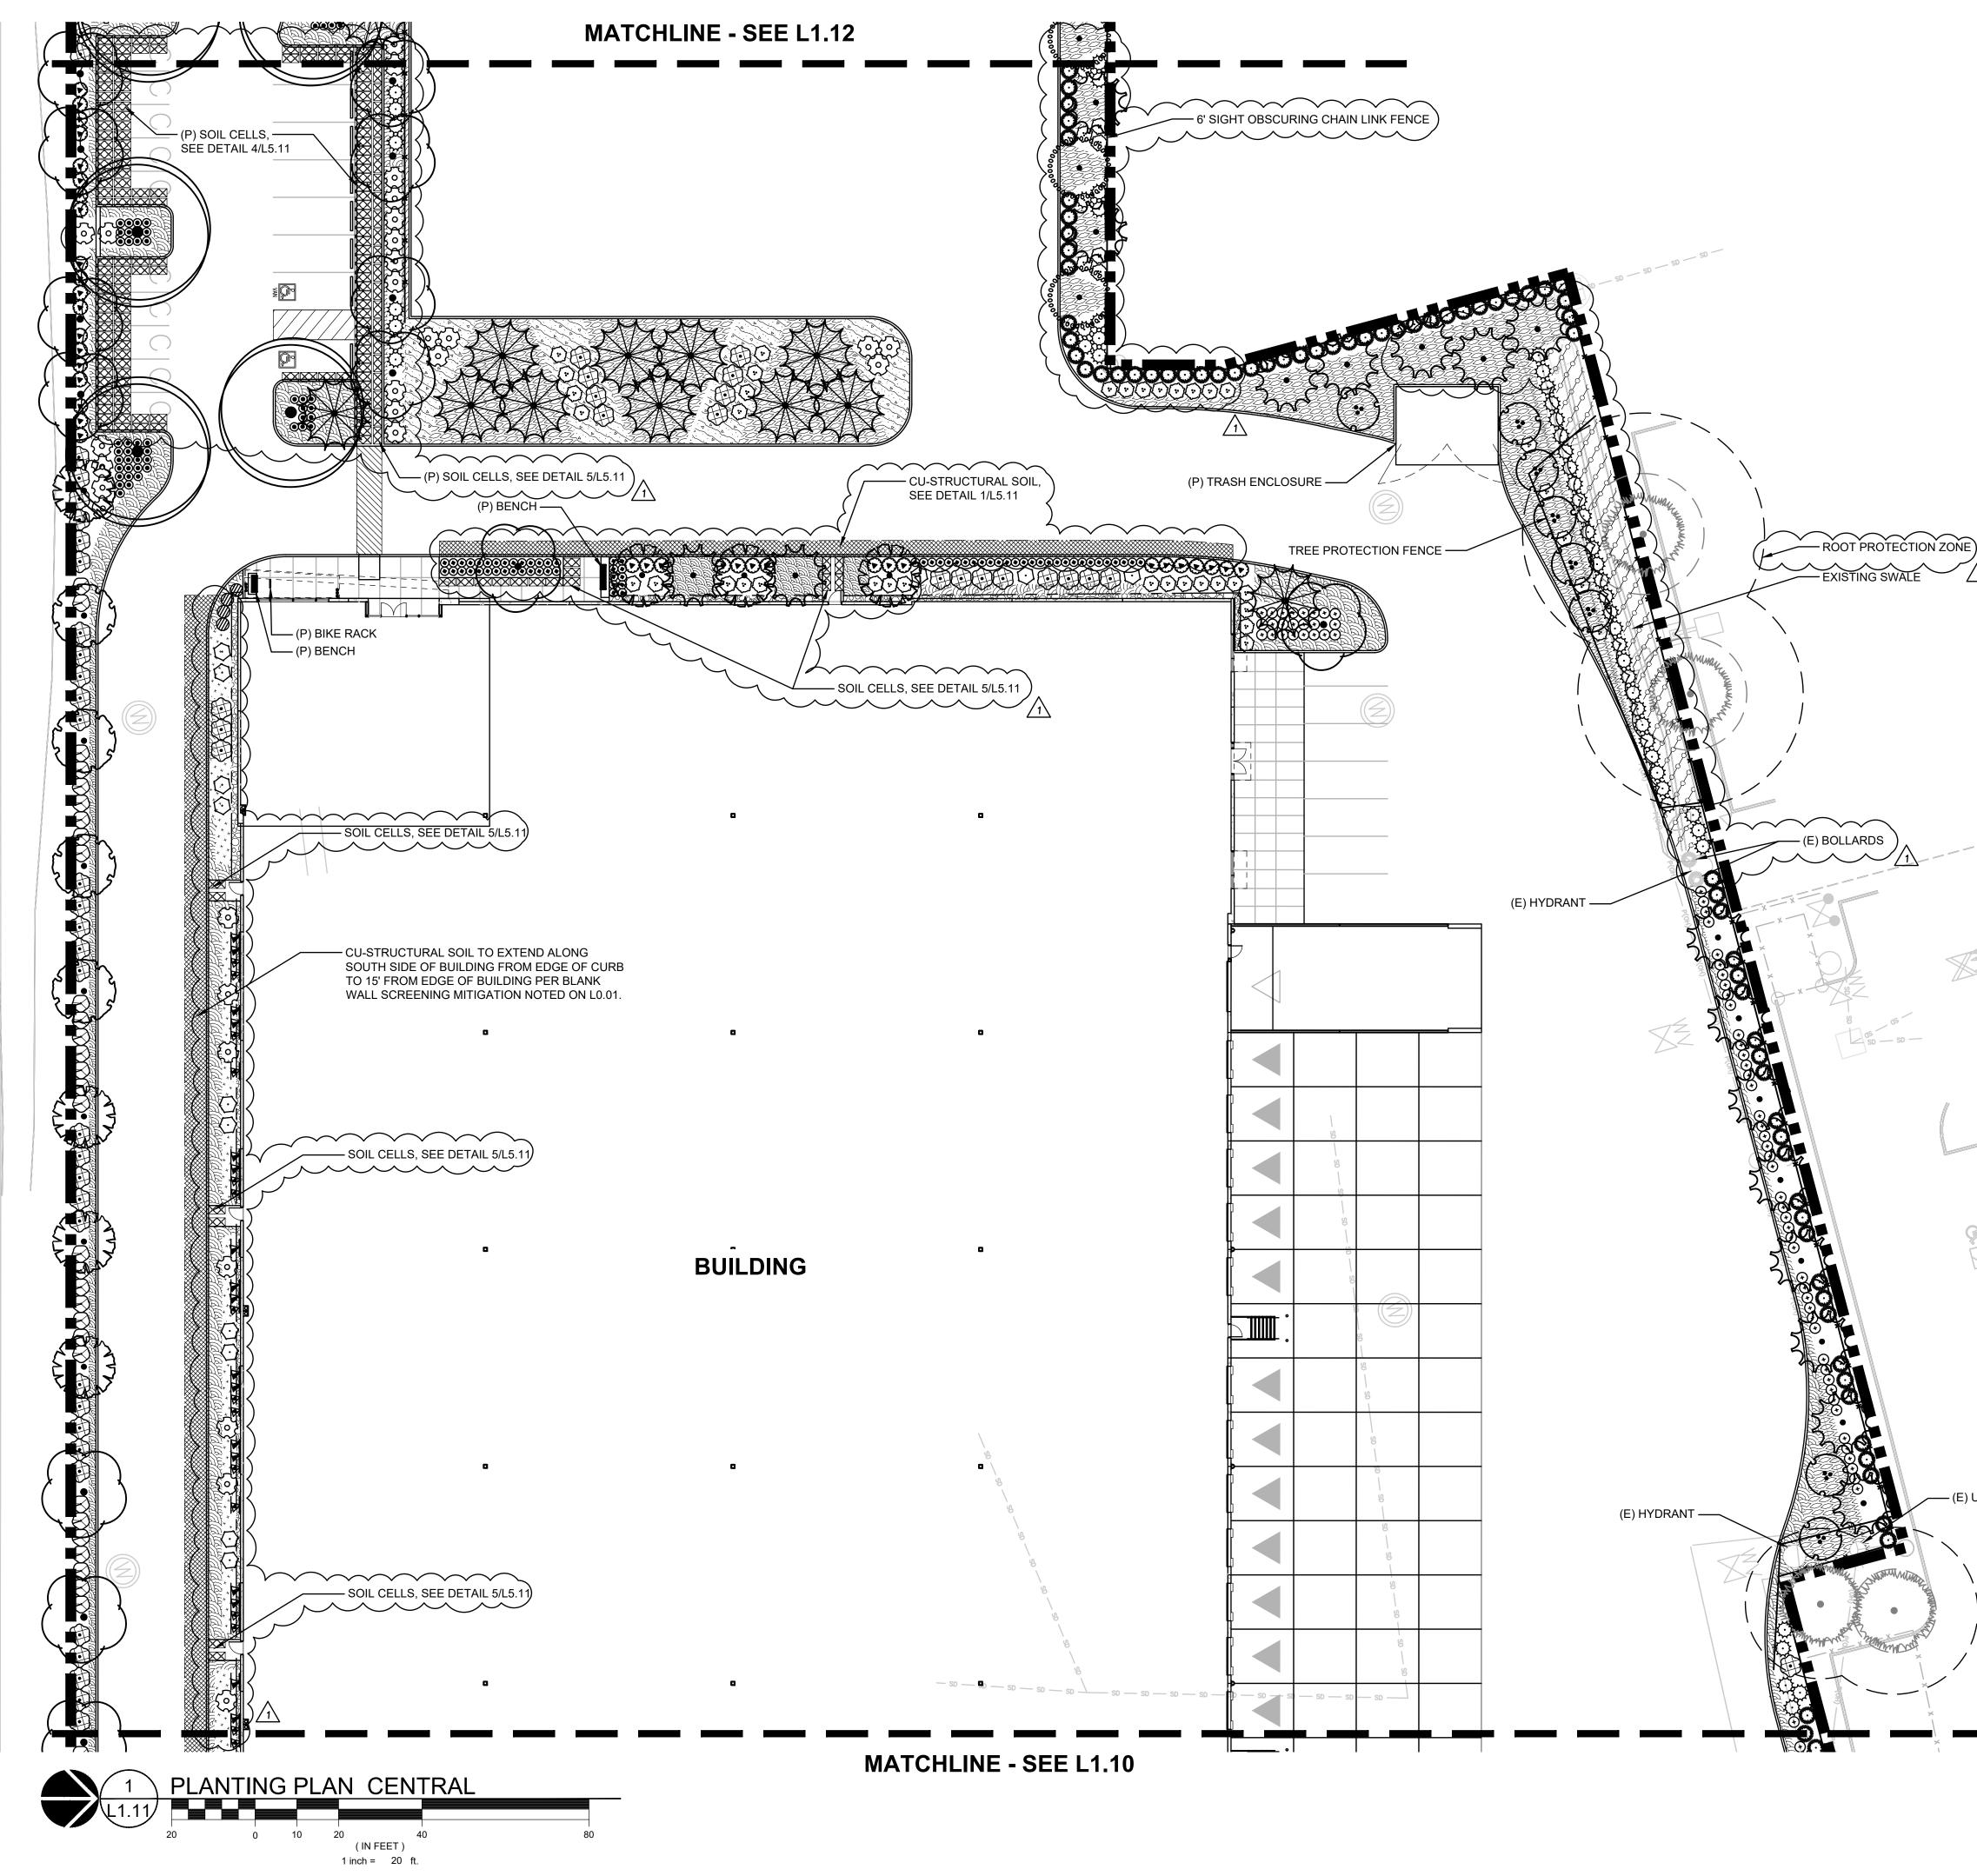
REFERENCE NOTES

- PLANT SIZE, SPACING, AND QUANTITY, SEE PLANT SCHEDULE L0.01 EXISTING TREE TO REMAIN. DO NOT DISTURB. PROTECT IN PLACE. PROPOSED UTILITY BOX. AVOID PLANTING WITHIN DEFINED
- ACCESS ZONE.
- CAREFULLY EXCAVATE SHRUB PITS IN VICINITY OF EXISTING TREES, WITHOUT DISTURBING TREE ROOTS. COORDINATE SHRUB LAYOUT WITH EXISTING UTILITIES, REPORT CONFLICTS TO LANDSCAPE ARCHITECT.





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SHEET TITLE:

PLANTING PLAN CENTRAL

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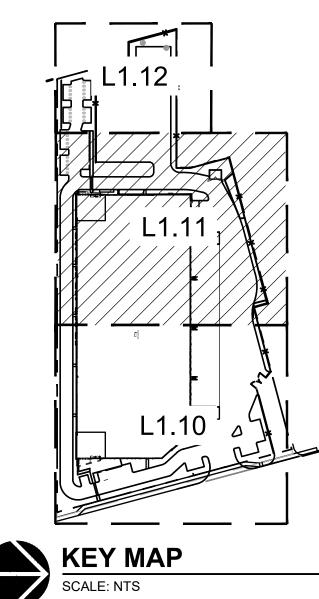
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REFERENCE NOTES

- 1. PLANT SIZE, SPACING, AND QUANTITY, SEE PLANT SCHEDULE L0.01 EXISTING TREE TO REMAIN. DO NOT DISTURB. PROTECT IN PLACE. 3. PROPOSED UTILITY BOX. AVOID PLANTING WITHIN DEFINED
- PROPOSED UTILITY BOX. AVOID PLANTING WITHIN DEFINED ACCESS ZONE.
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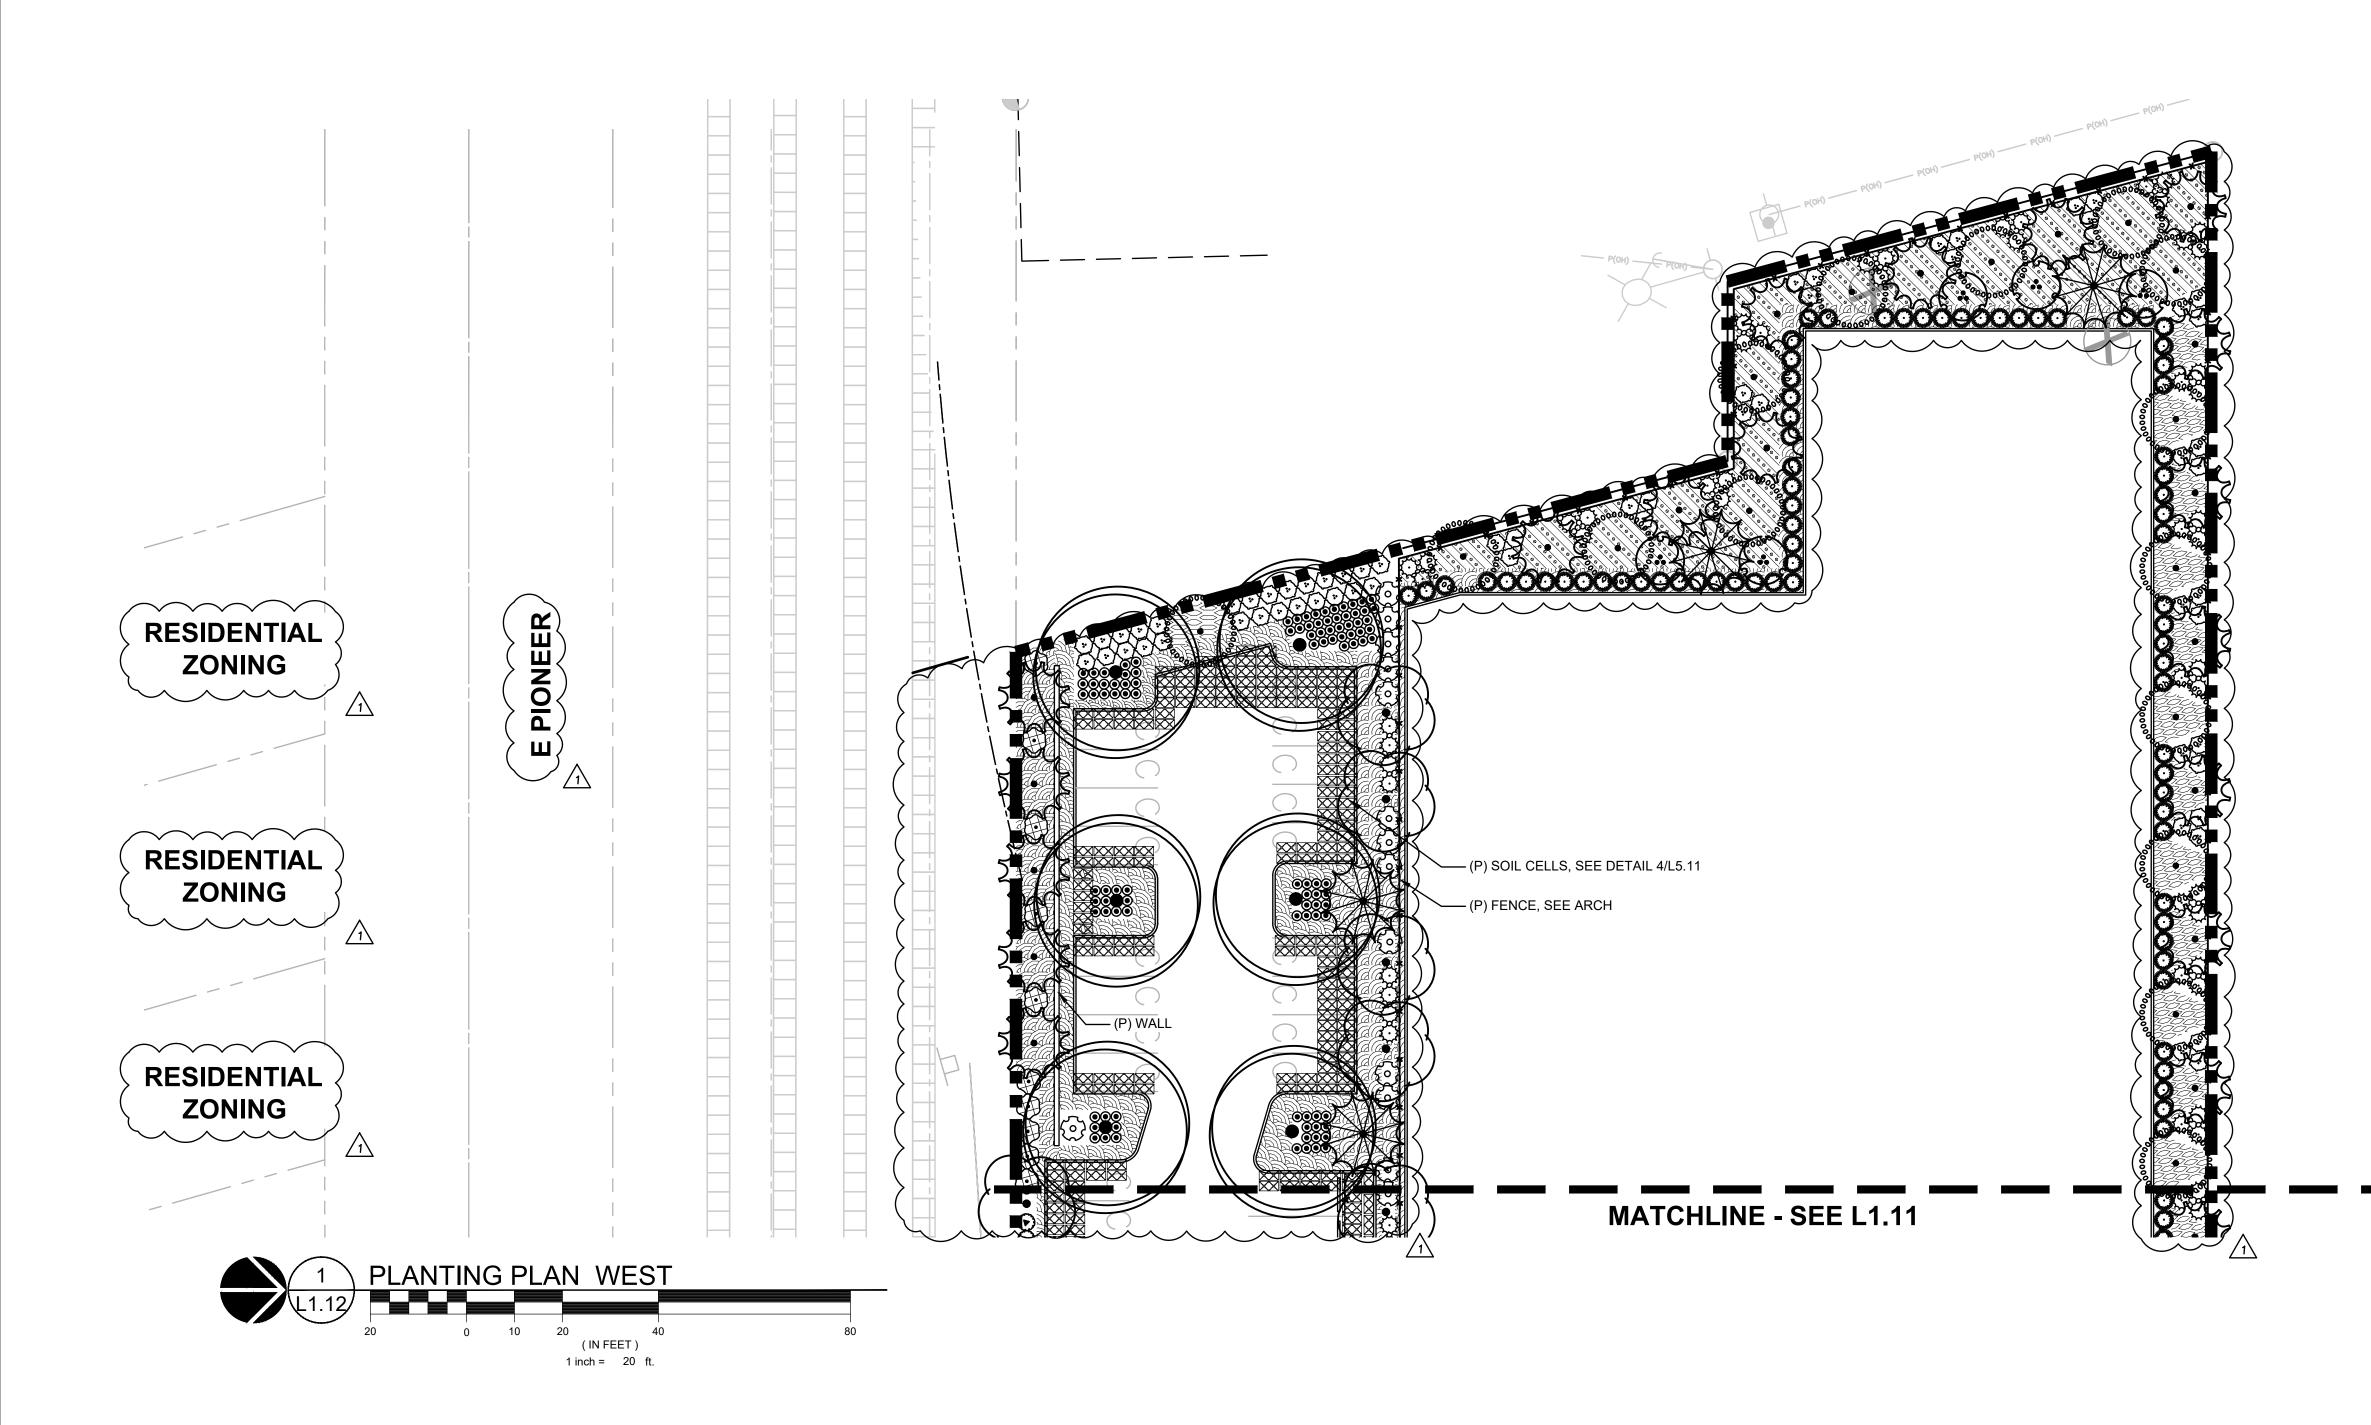
(E) UTILITY POLE

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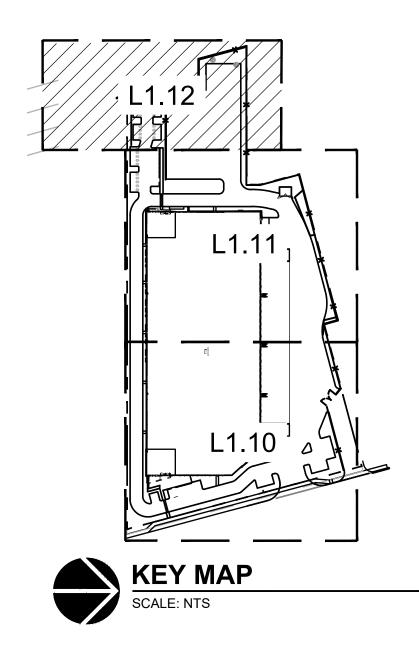


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REFERENCE NOTES

 PLANT SIZE, SPACING, AND QUANTITY, SEE PLANT SCHEDULE L0.01
 COORDINATE SHRUB LAYOUT WITH EXISTING UTILITIES, REPORT CONFLICTS TO LANDSCAPE ARCHITECT.



SHEET TITLE: PLANTING PLAN WEST

DRAWN BY: LJM

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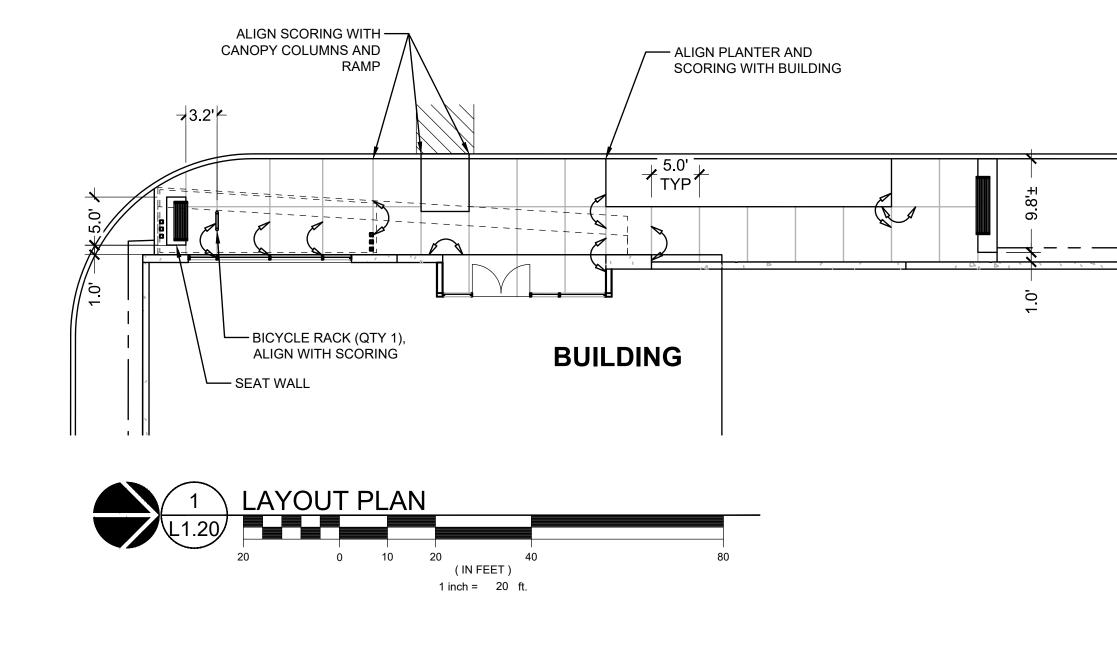
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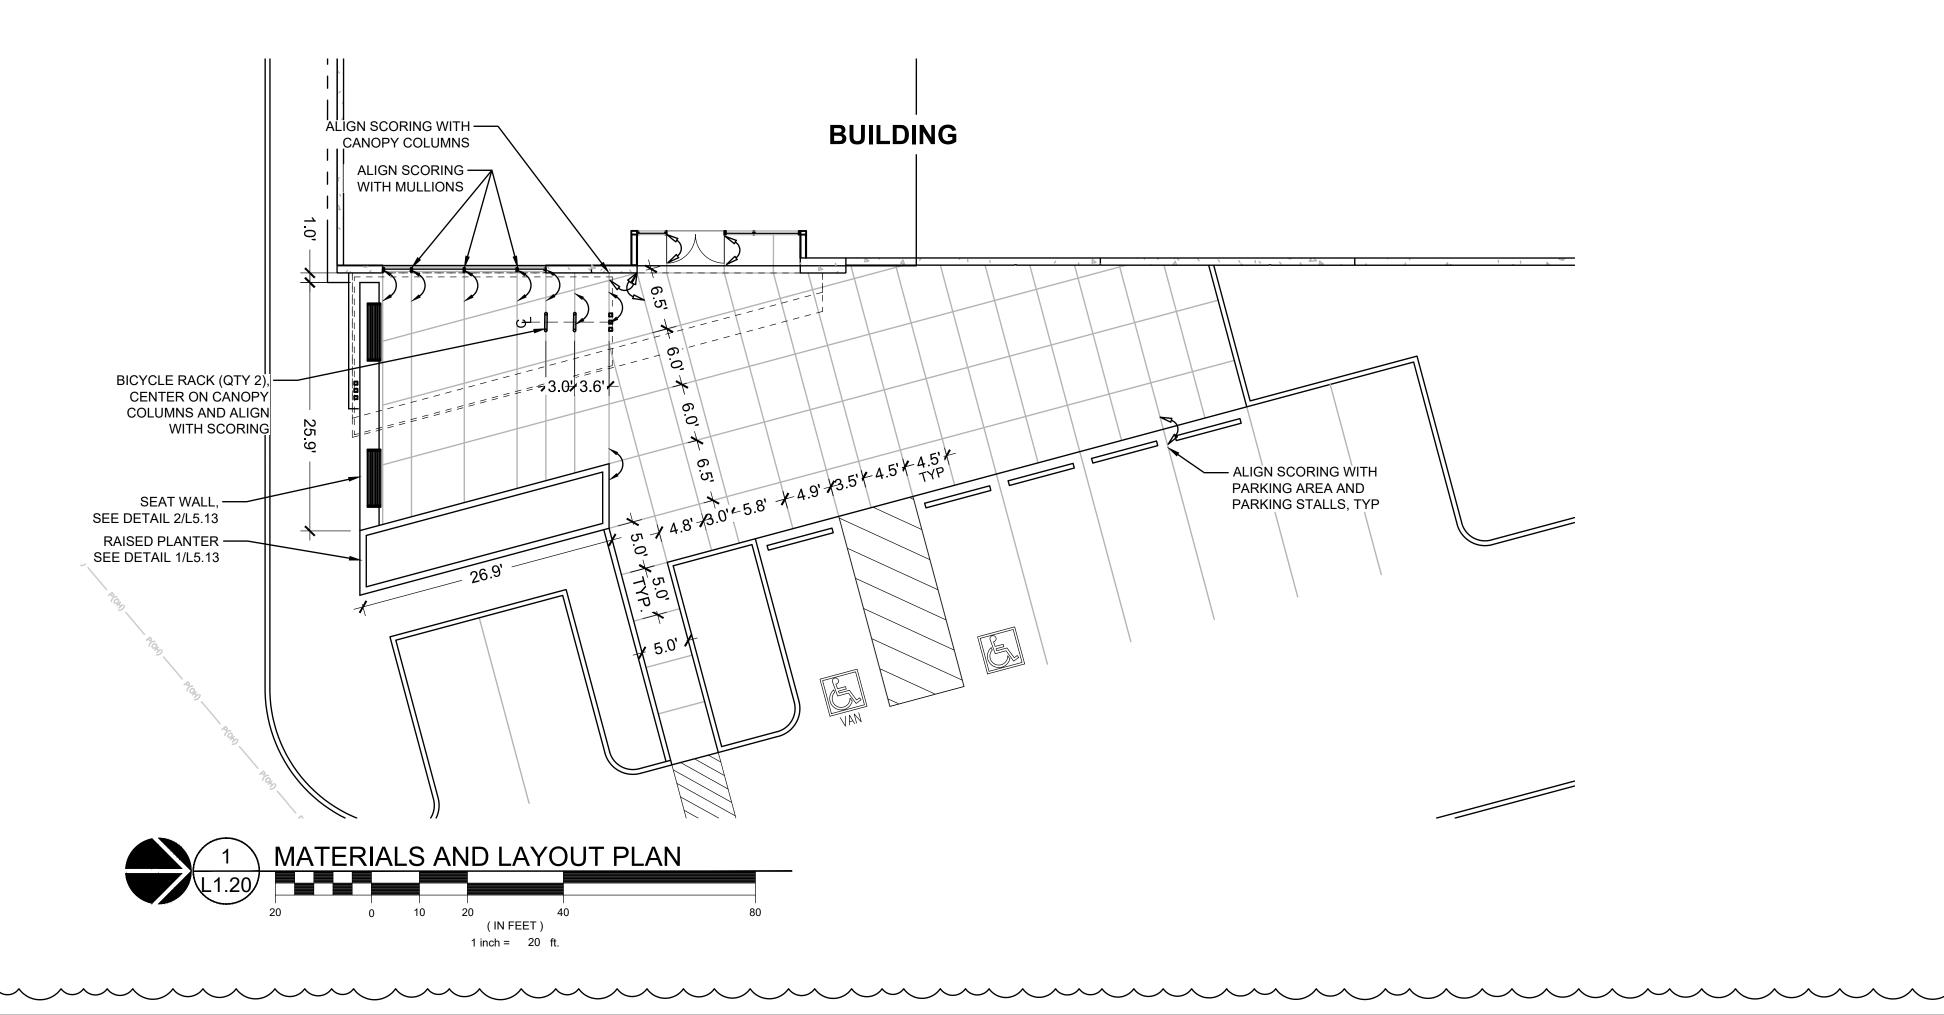


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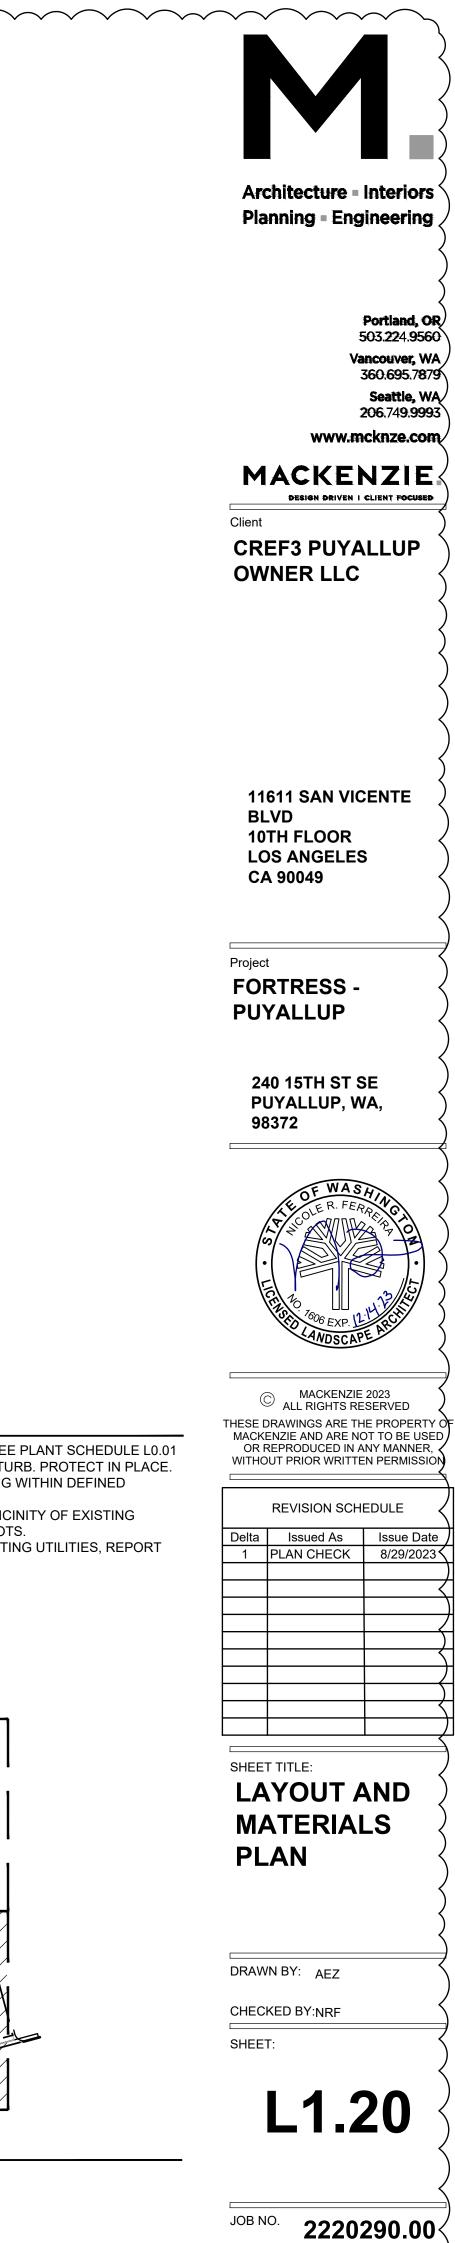


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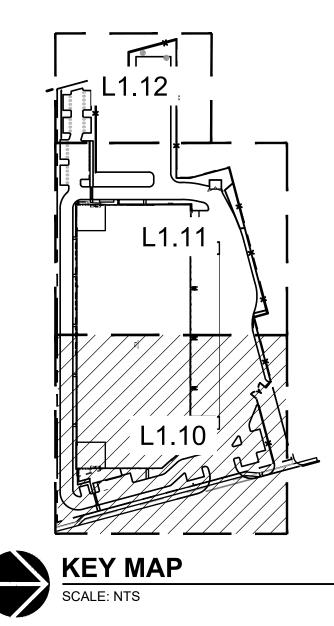
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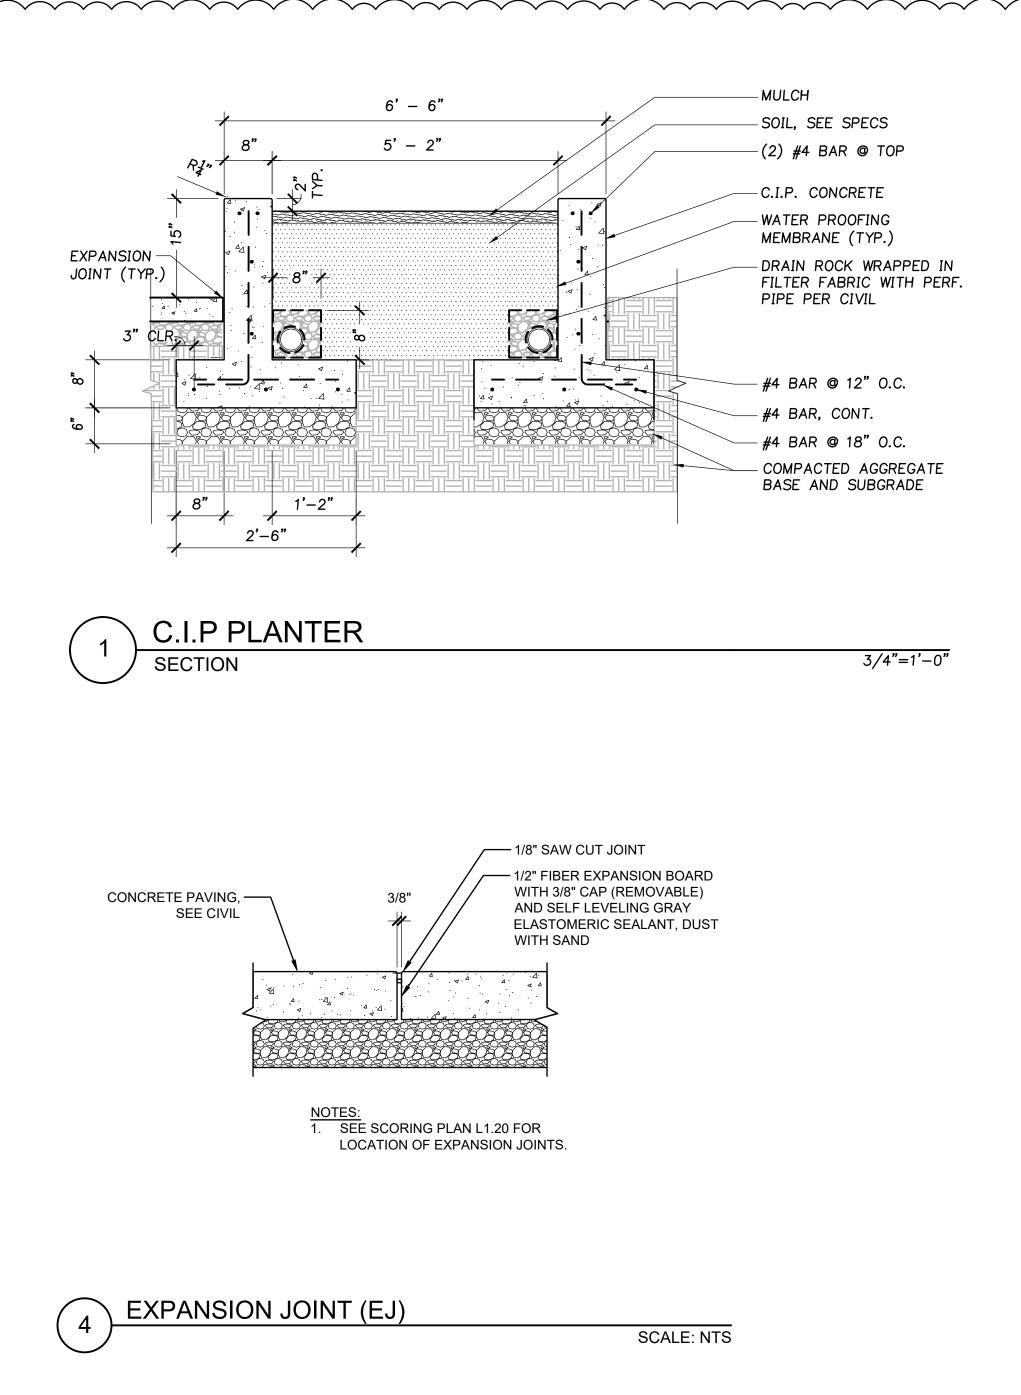



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- PLANT SIZE, SPACING, AND QUANTITY, SEE PLANT SCHEDULE L0.01
 EXISTING TREE TO REMAIN. DO NOT DISTURB. PROTECT IN PLACE.
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- PROPOSED UTILITY BOX. AVOID PLANTING WITHIN DEFINED ACCESS ZONE.
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- COORDINATE SHRUB LAYOUT WITH EXISTING UTILITIES, REPORT CONFLICTS TO LANDSCAPE ARCHITECT.



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— 1/8" SAW CUT JOINT

SCALE: NTS

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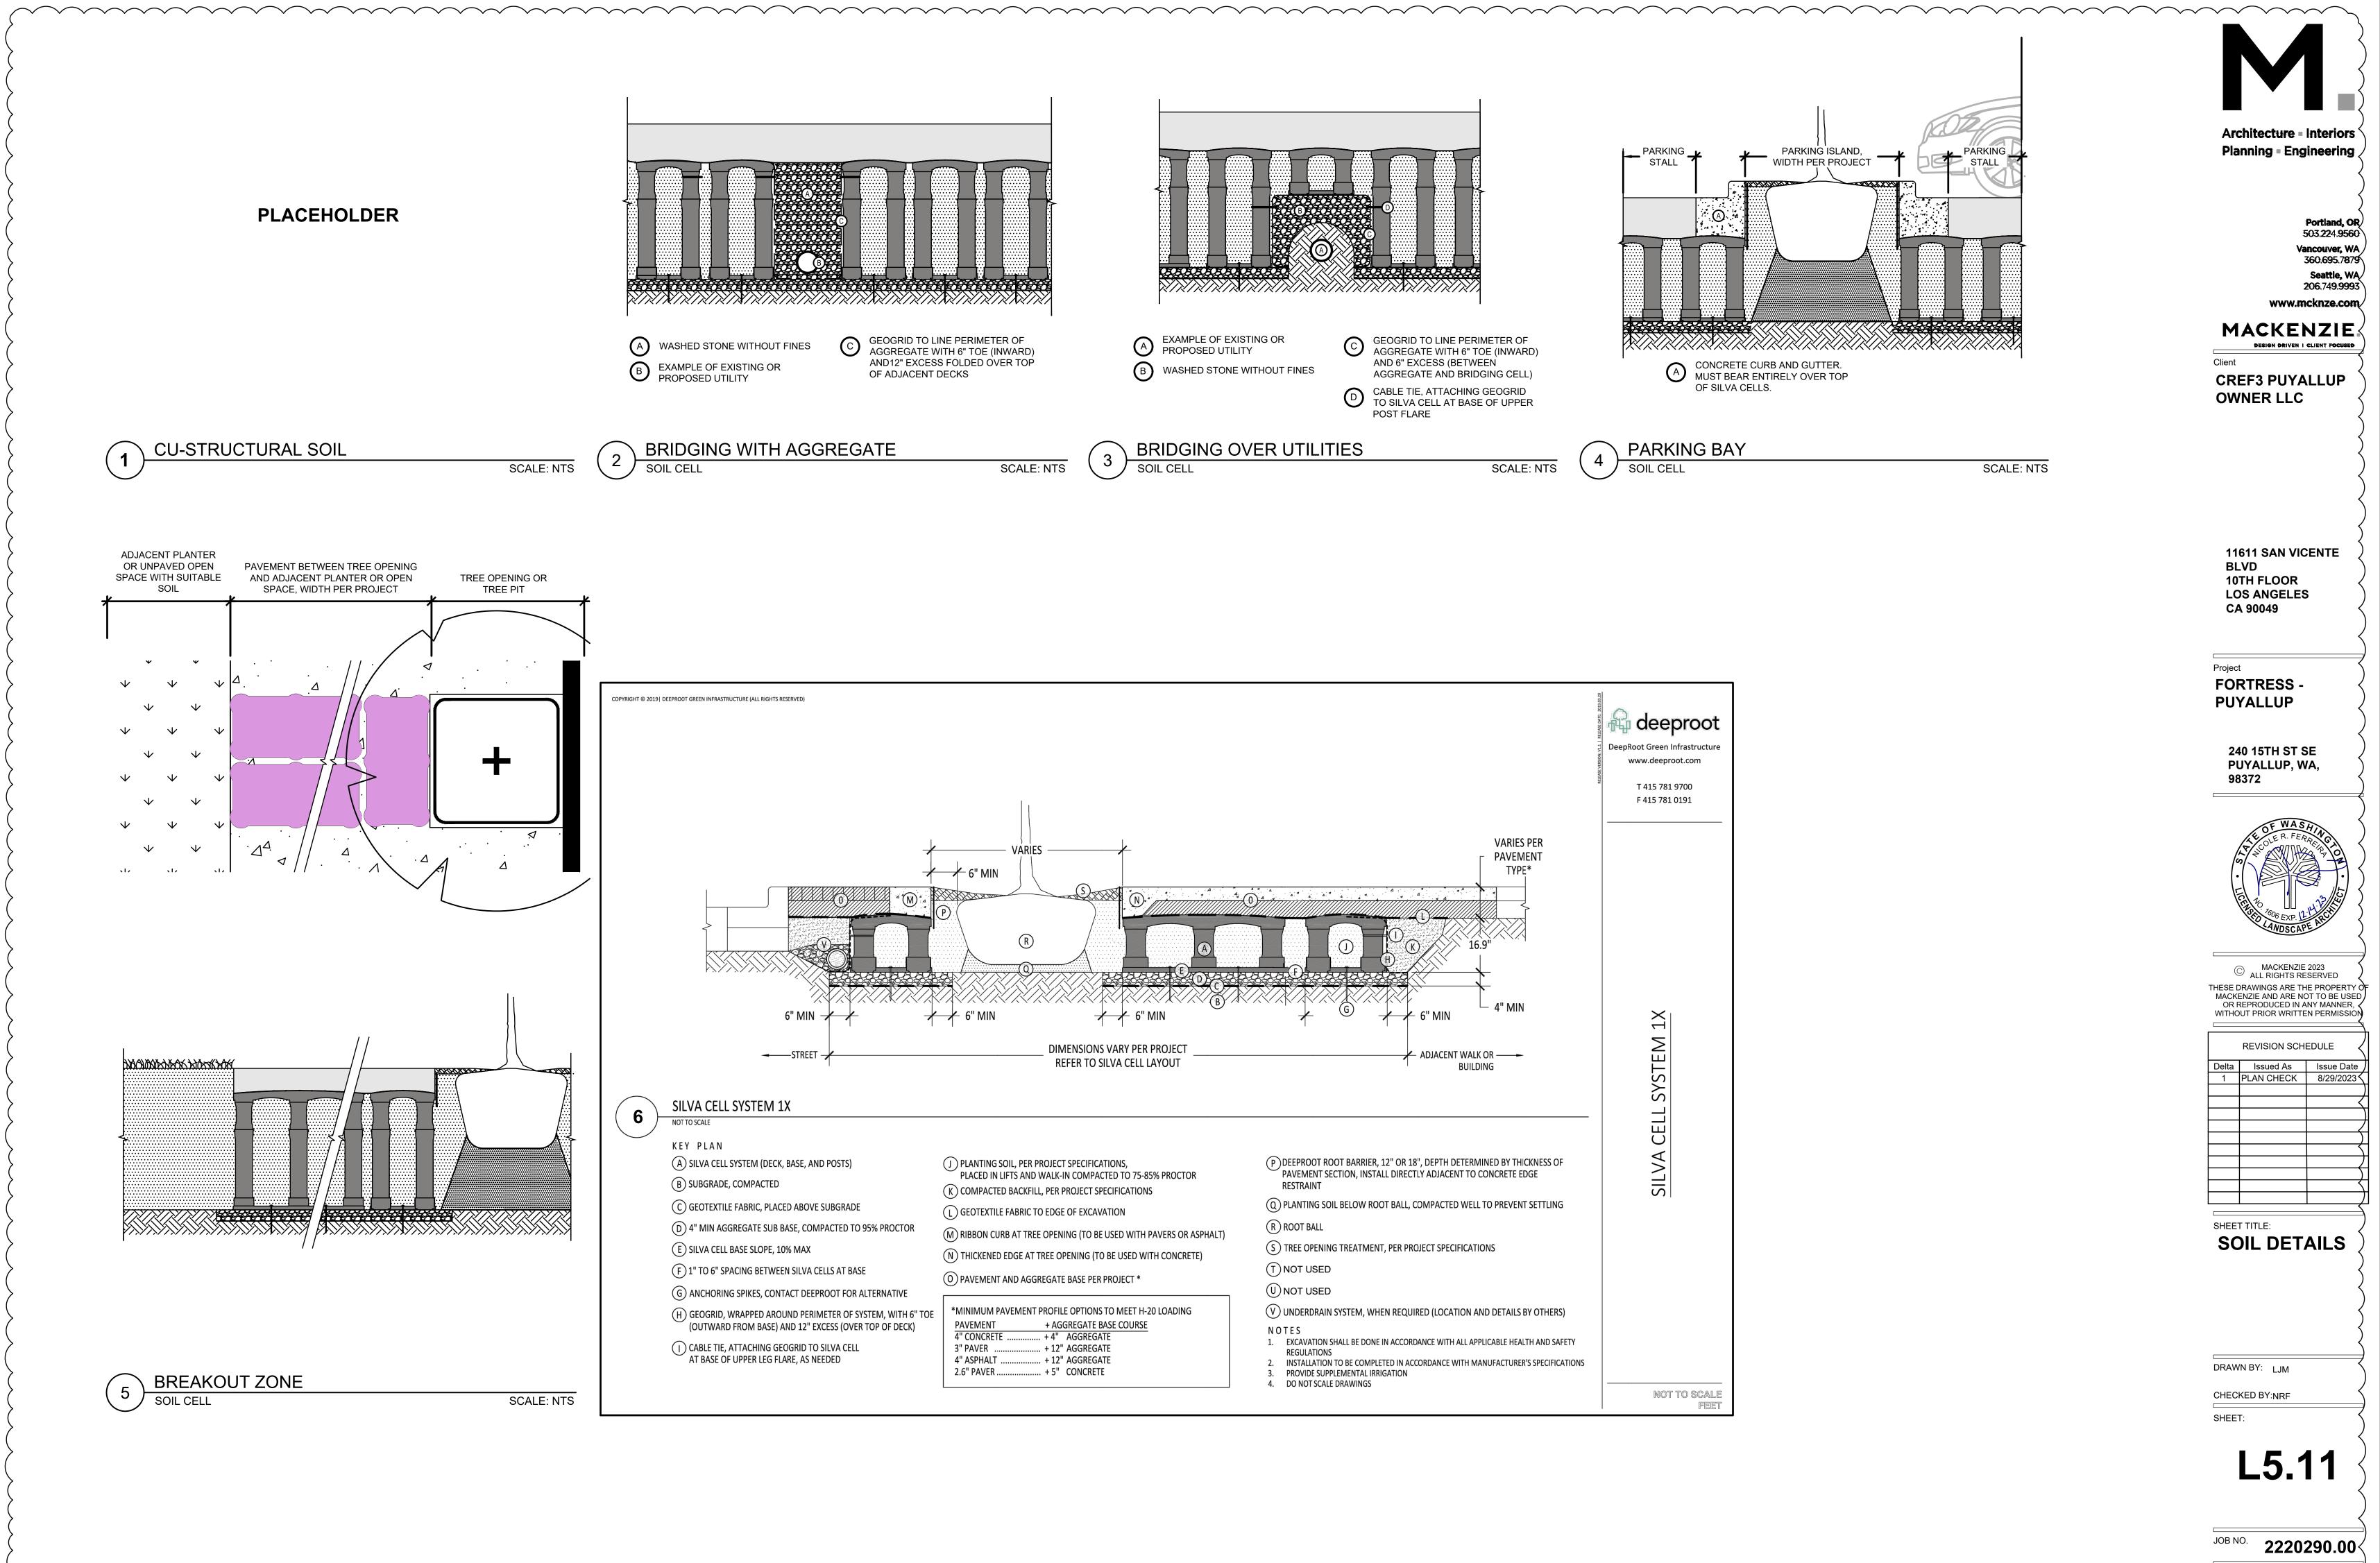
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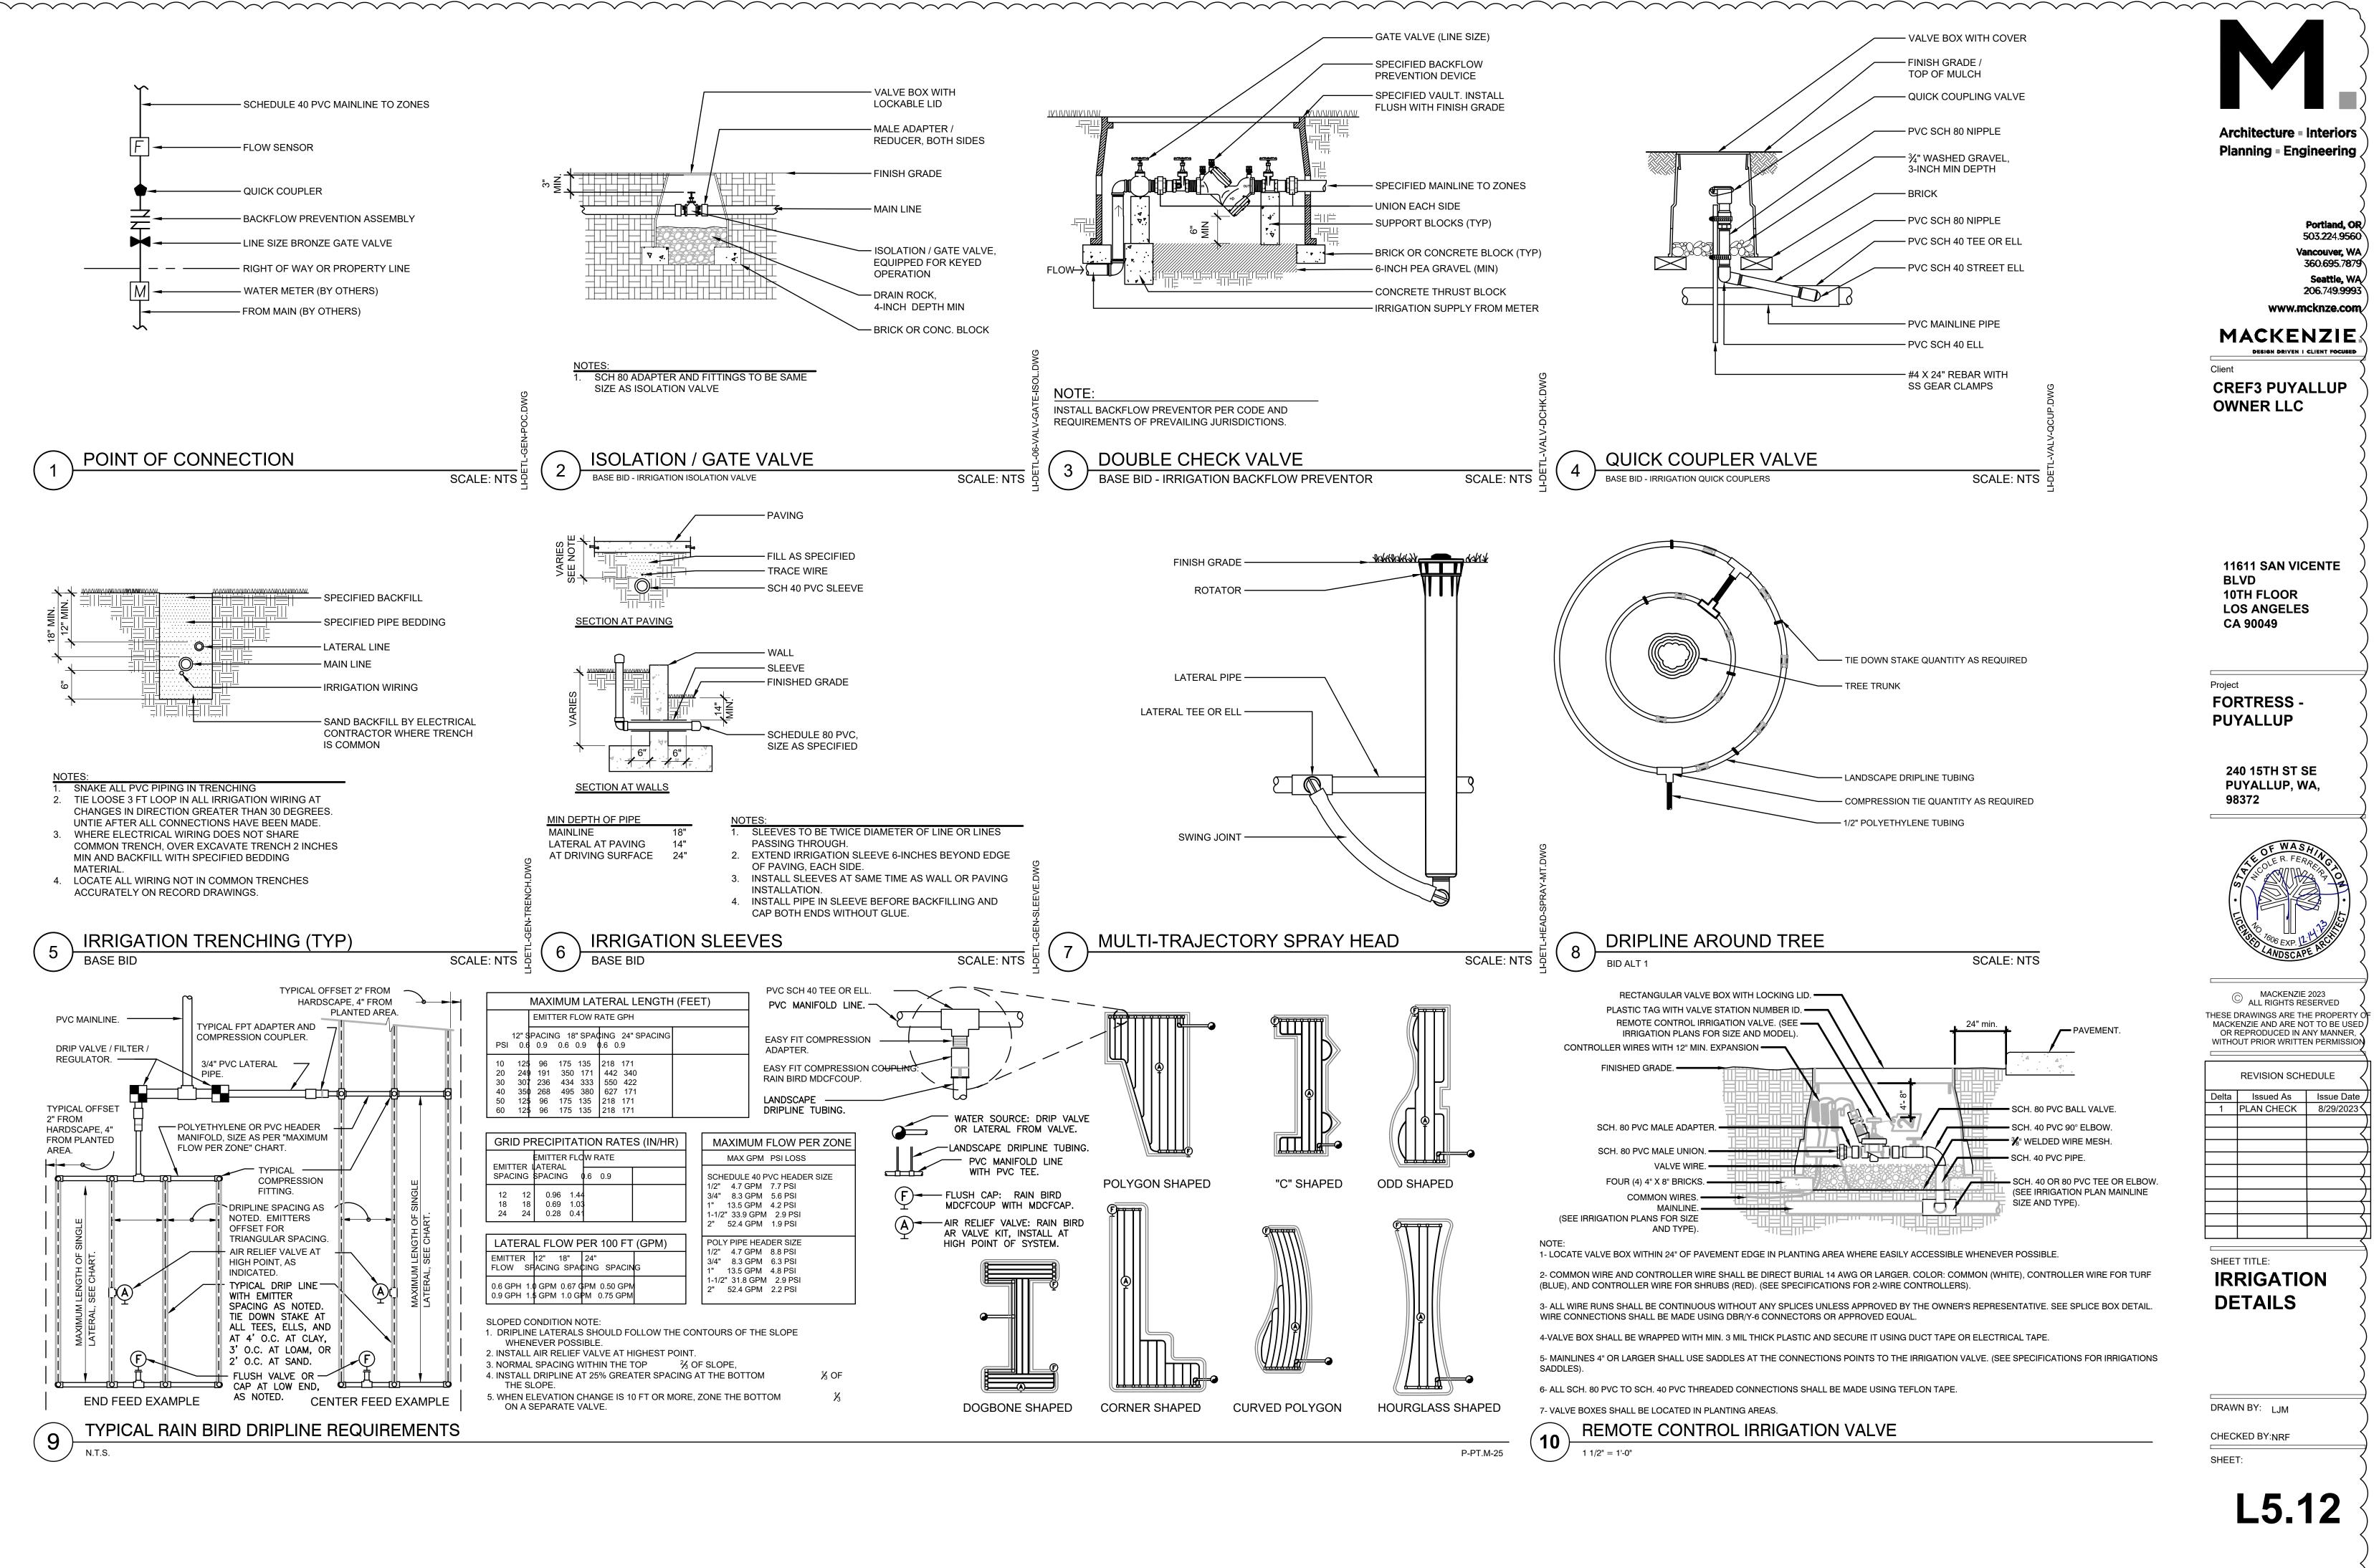

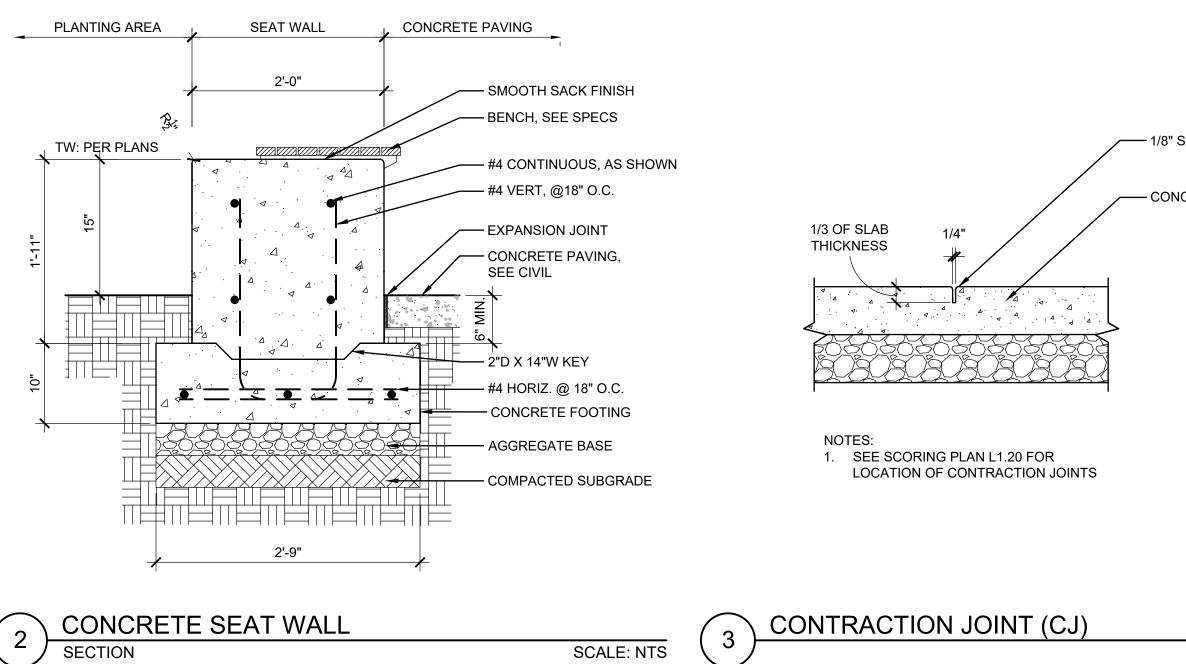
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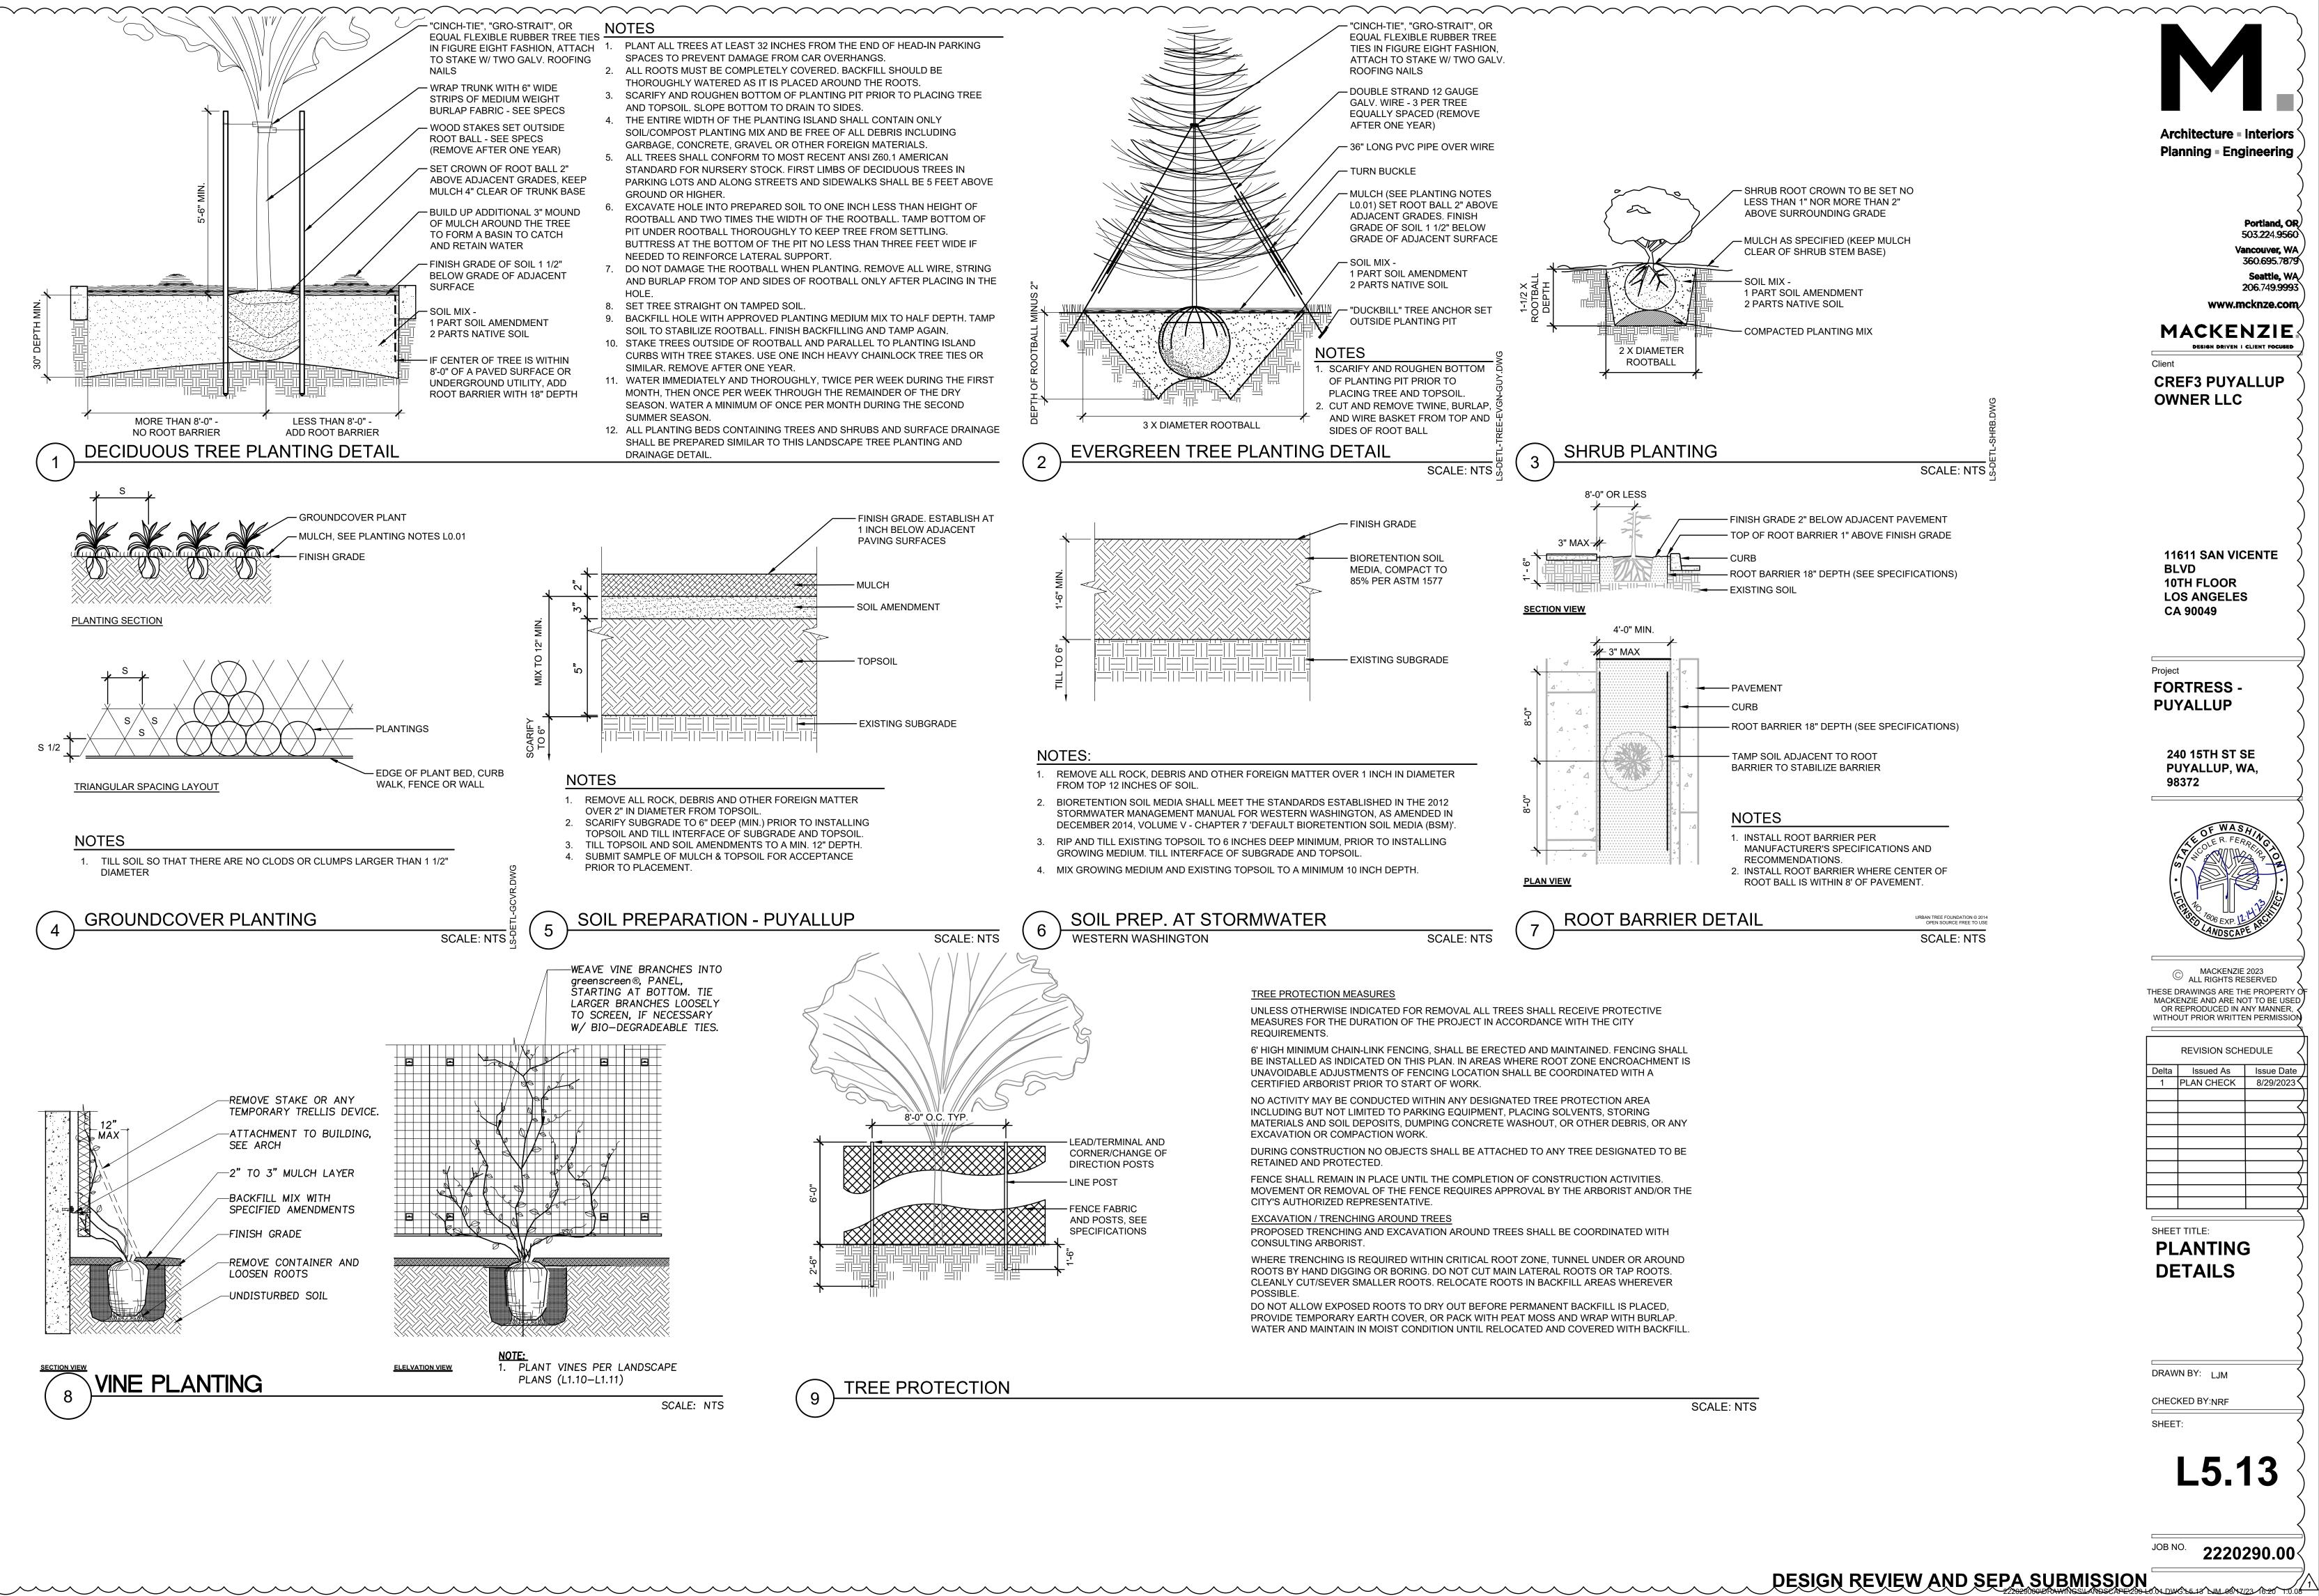
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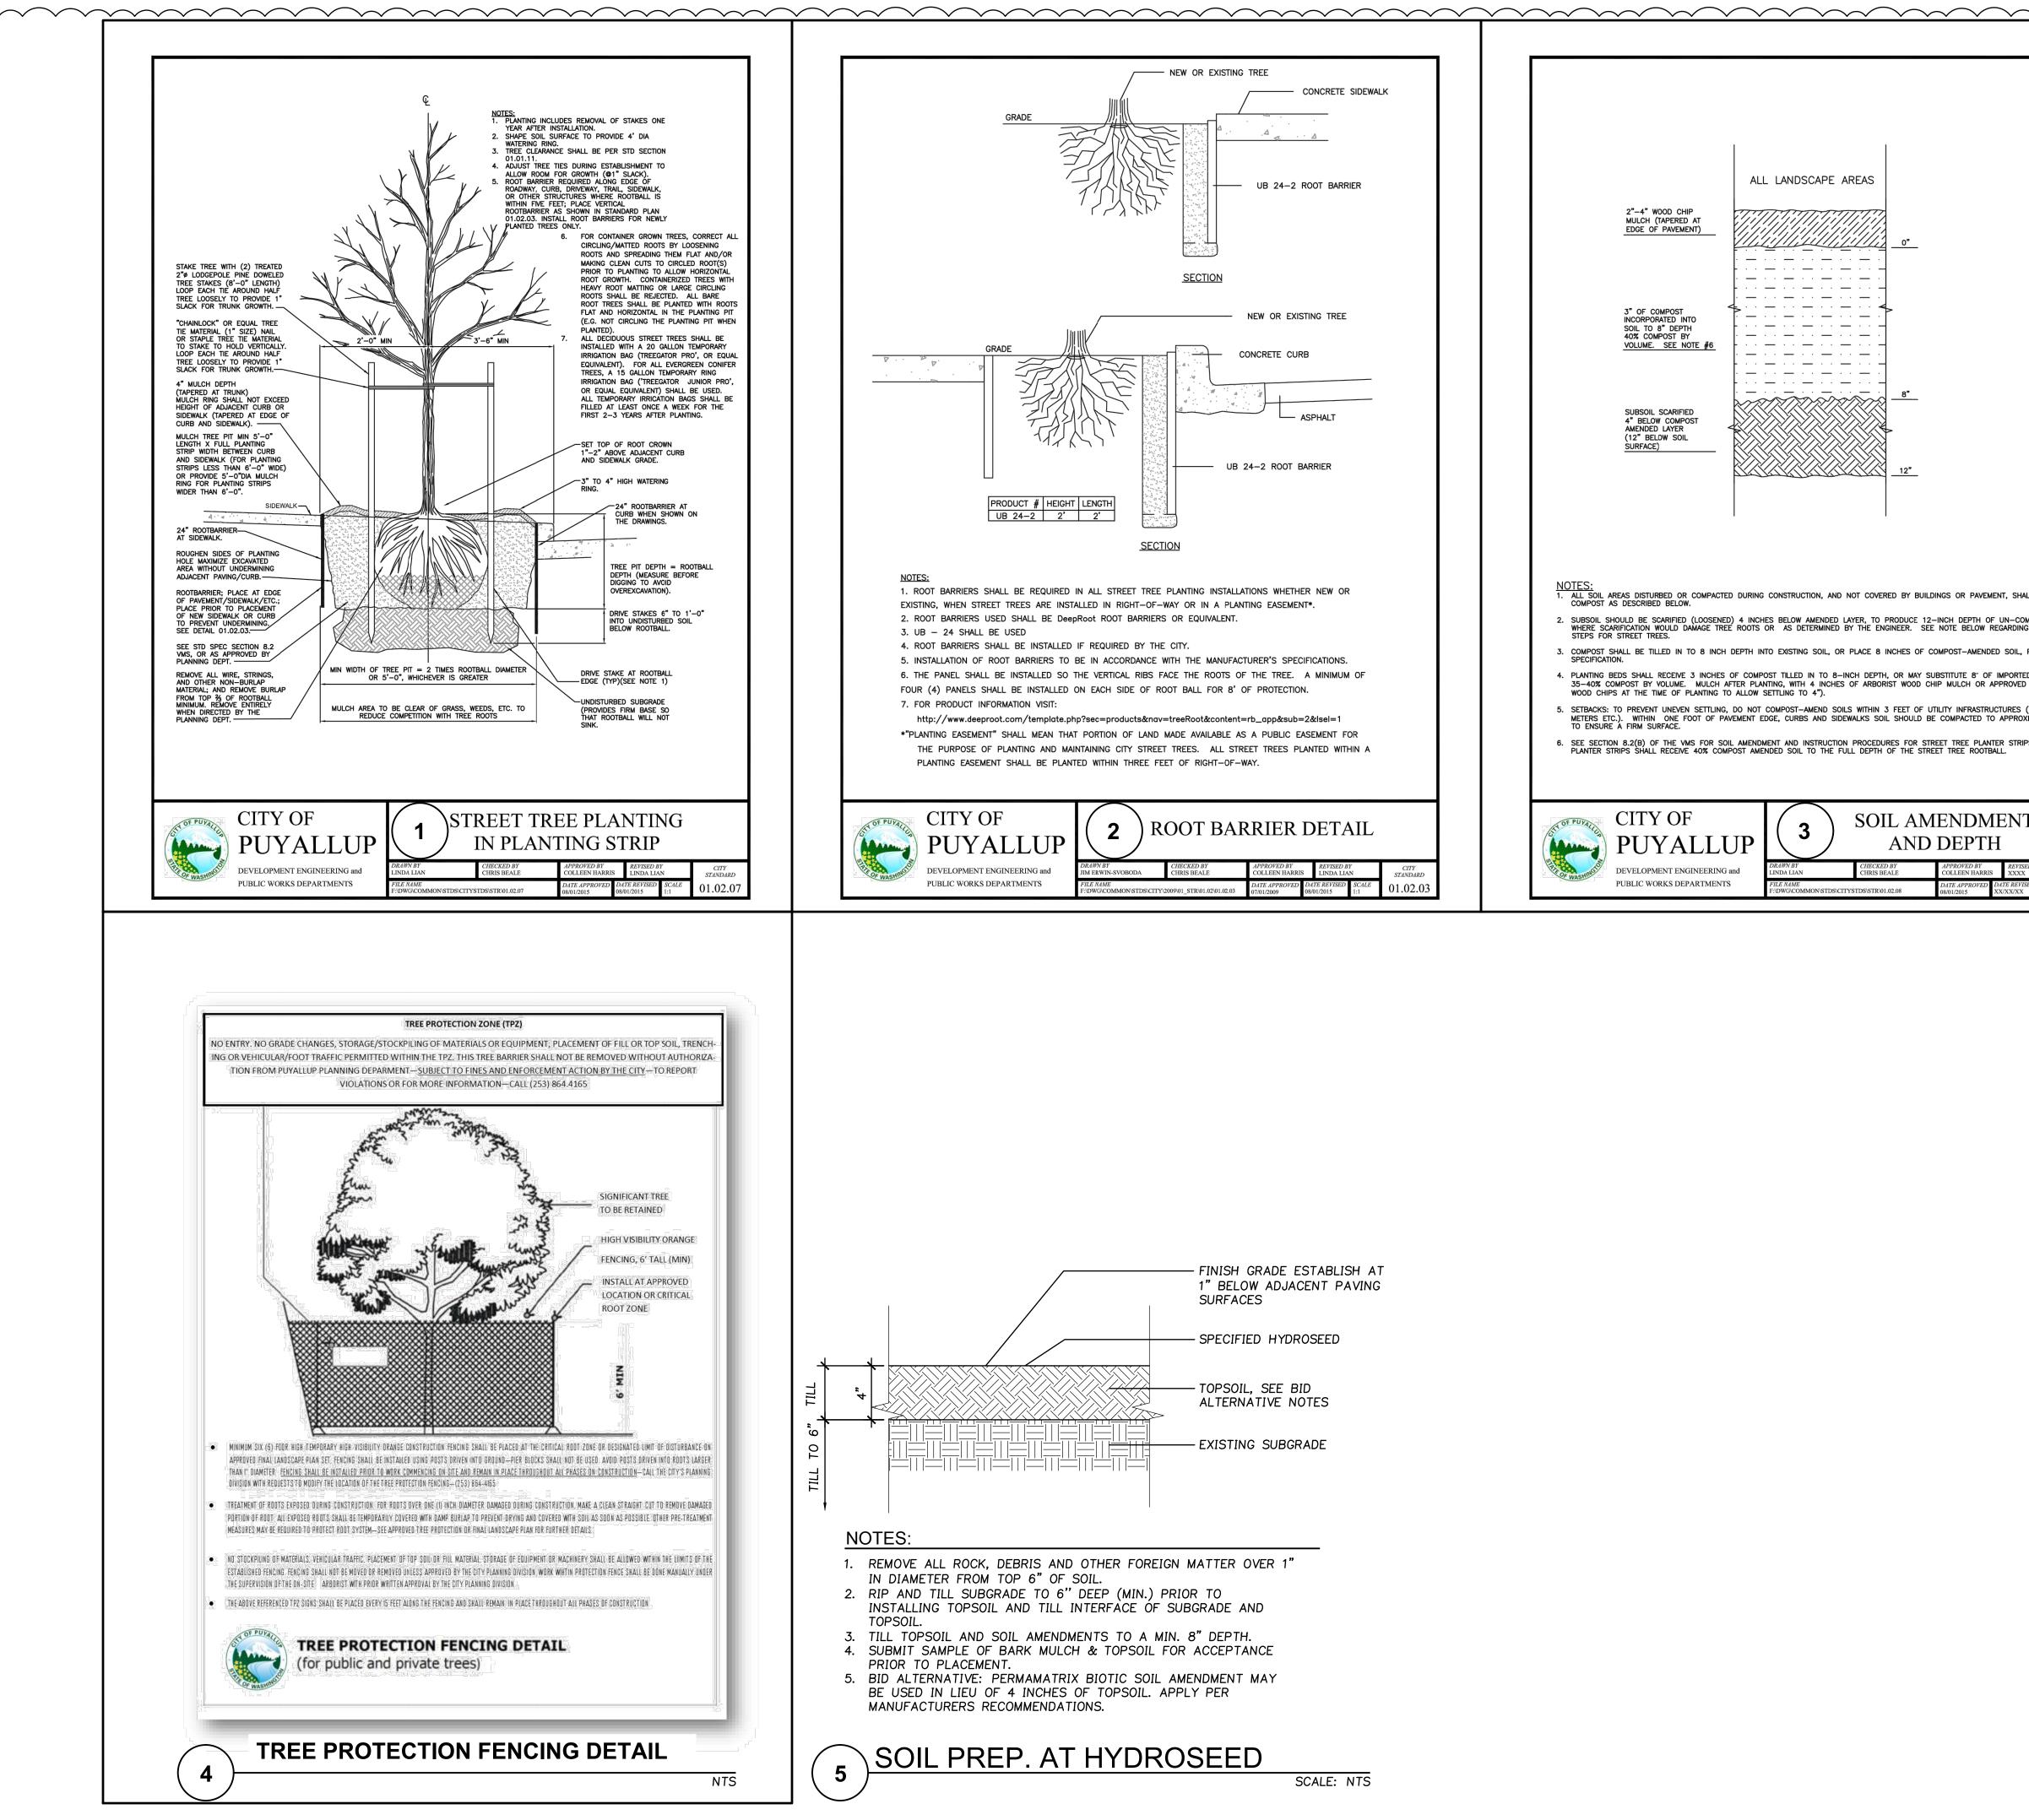
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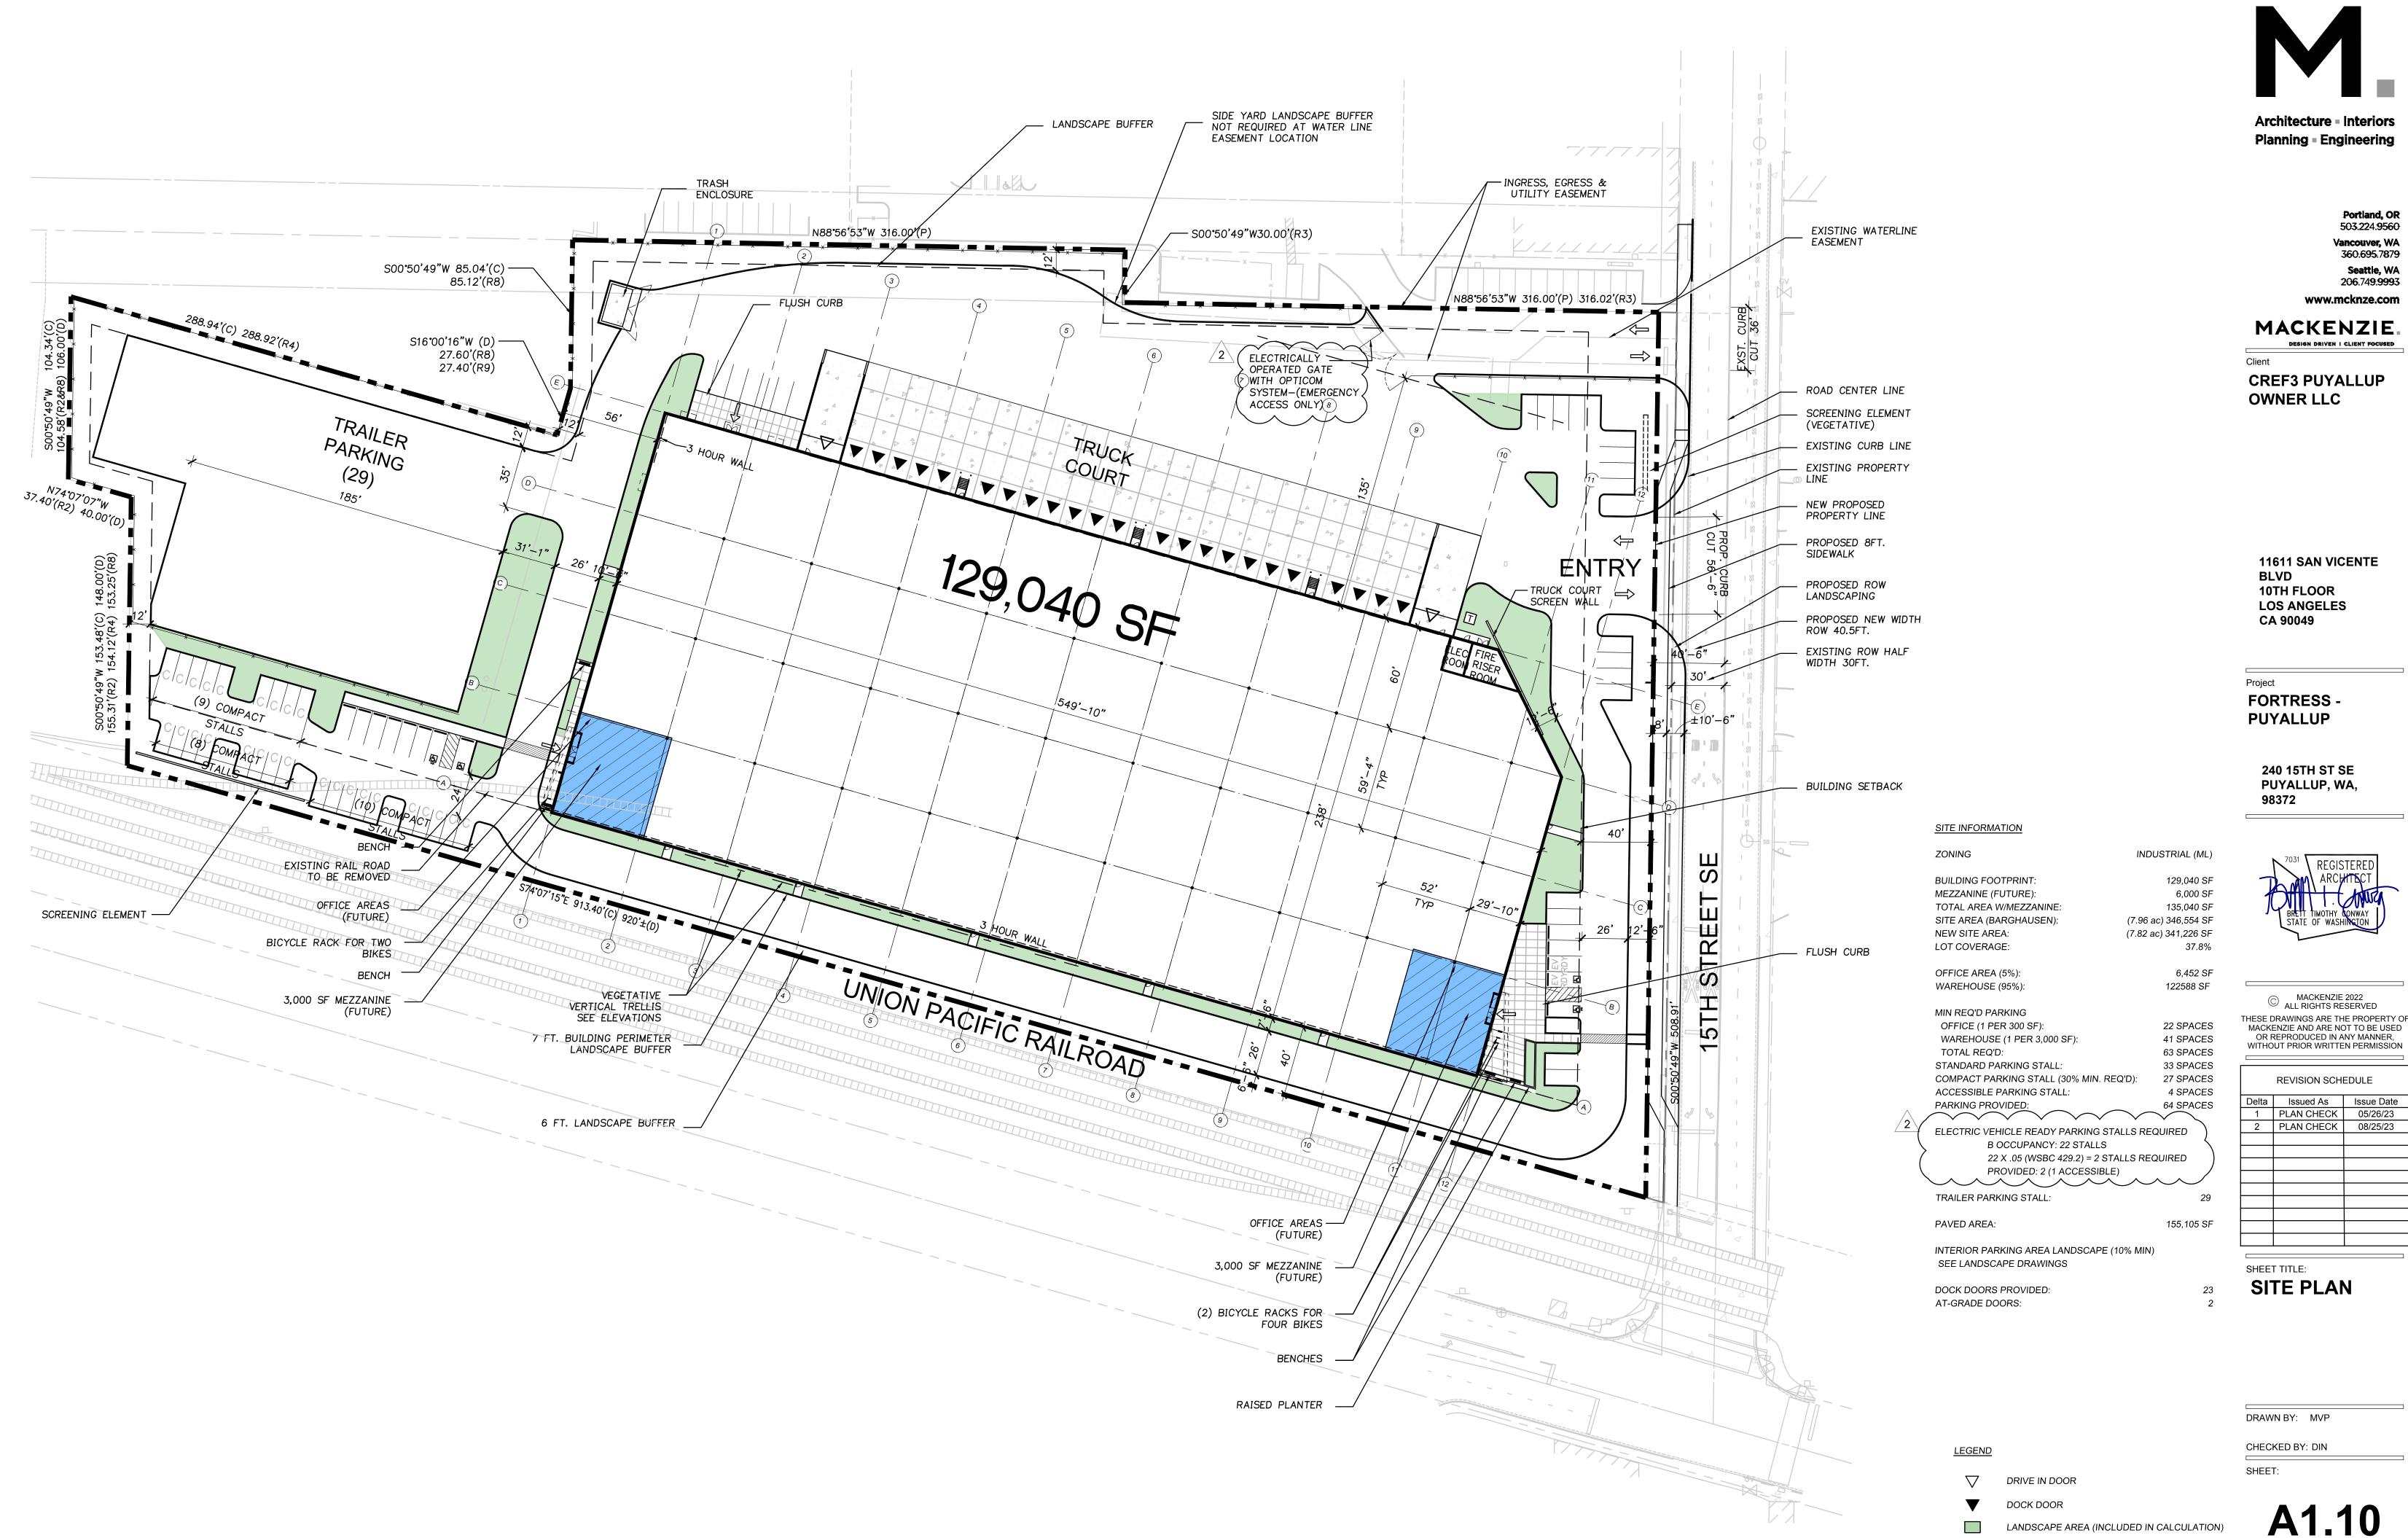


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	Vancouver, WA 360.695.7879 Seattle, WA
	206.749.9993 www.mcknze.com
	Client CREF3 PUYALLUP
	OWNER LLC
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SHALL BE AMENDED WITH	$\langle \rangle$
COMPACTED SOIL, EXCEPT	\sum
L, PER SOIL RTED SOIL CONTAINING /ED EQUAL (6" OF LOOSE	11611 SAN VICENTE
ZED EQUAL (6" OF LOOSE S (POLES, VAULTS, ROXIMATELY 95% PROCTOR	BLVD 10TH FLOOR LOS ANGELES
TRIPS. ALL STREET TREE	CA 90049
	Project
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	SHEET TITLE:
	PLANTING
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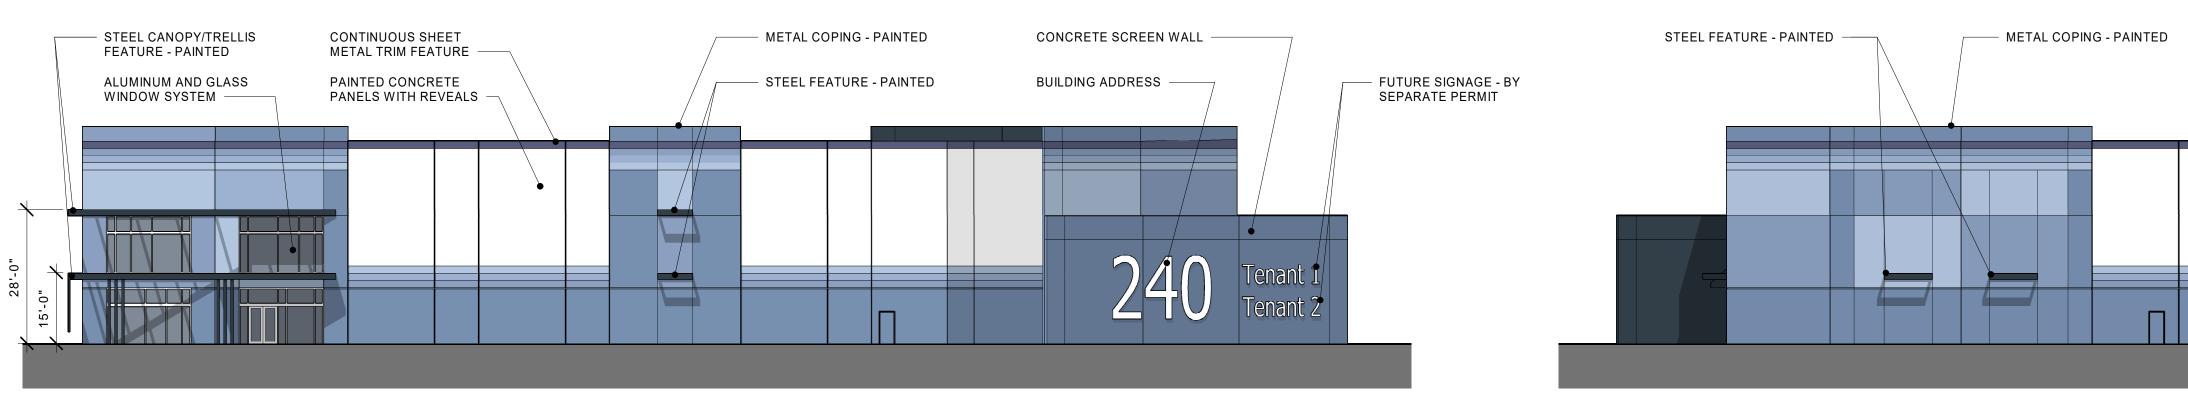
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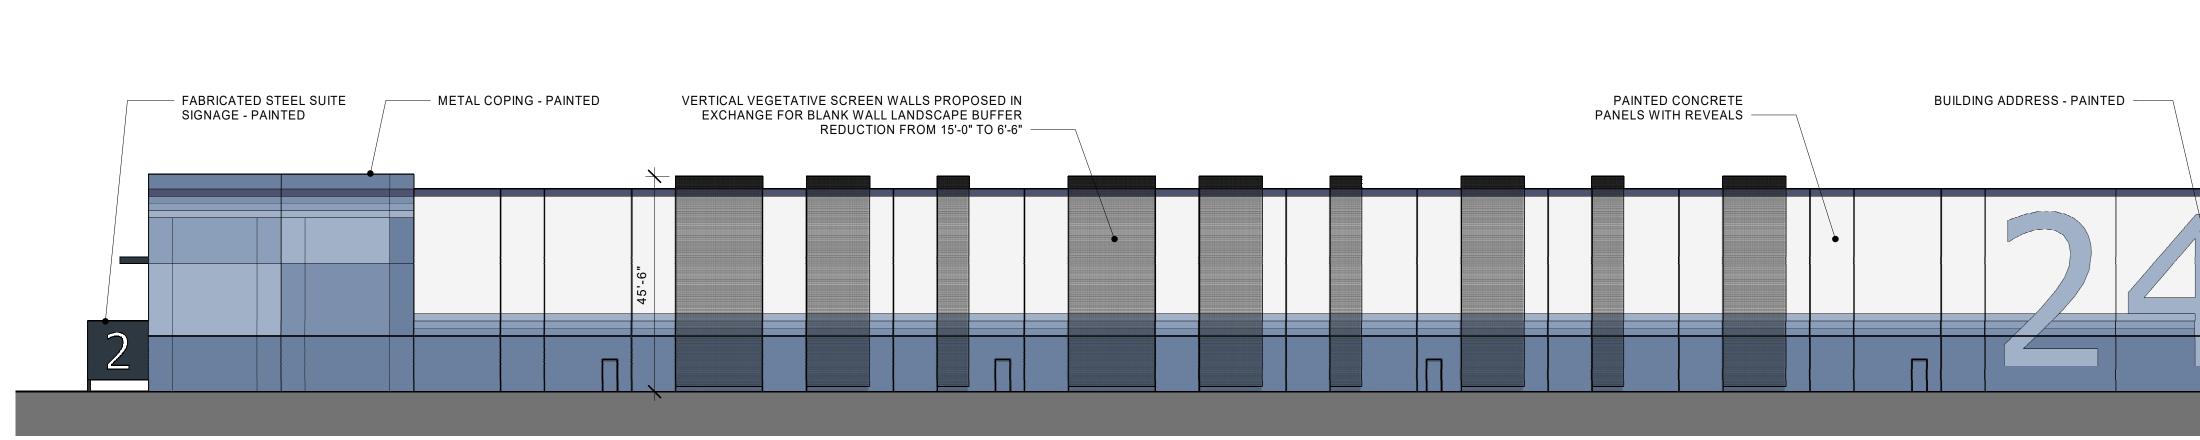
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EAST ELEVATION




SOUTH ELEVATION





NORTH ELEVATION



WEST ELEVATION

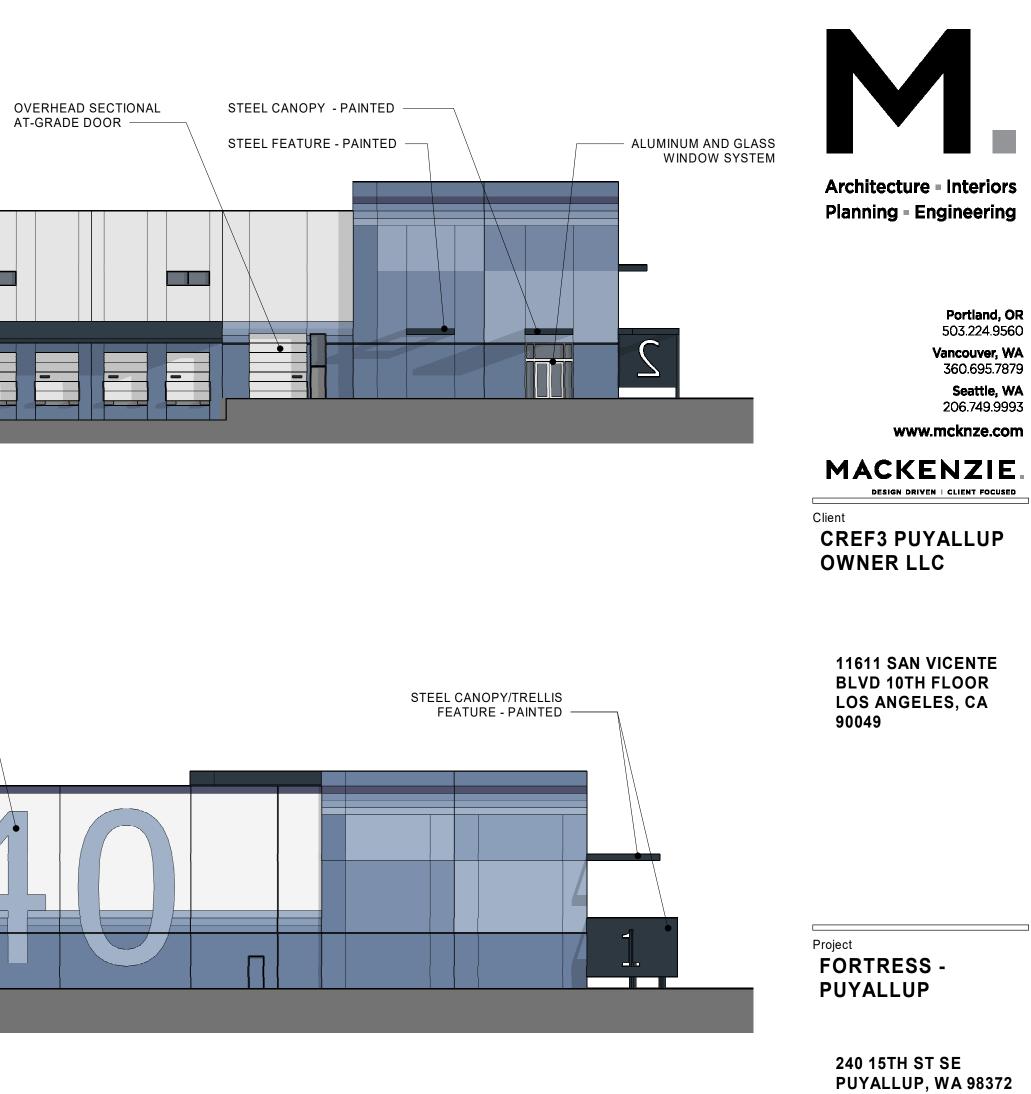

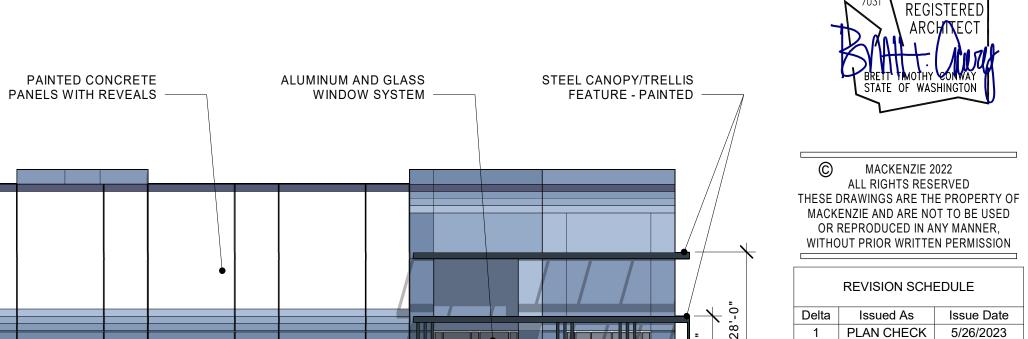

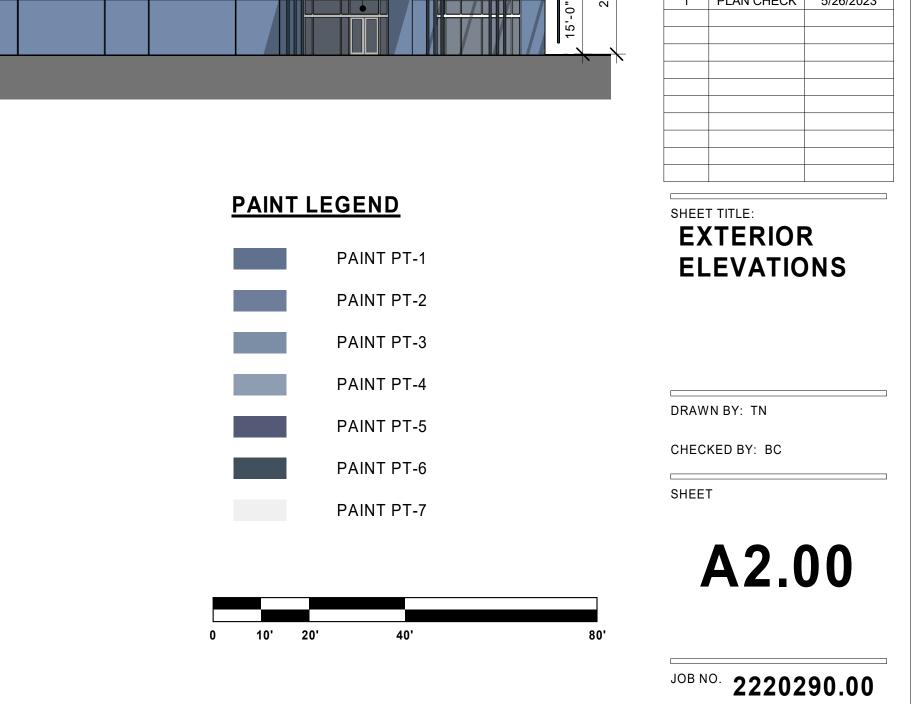

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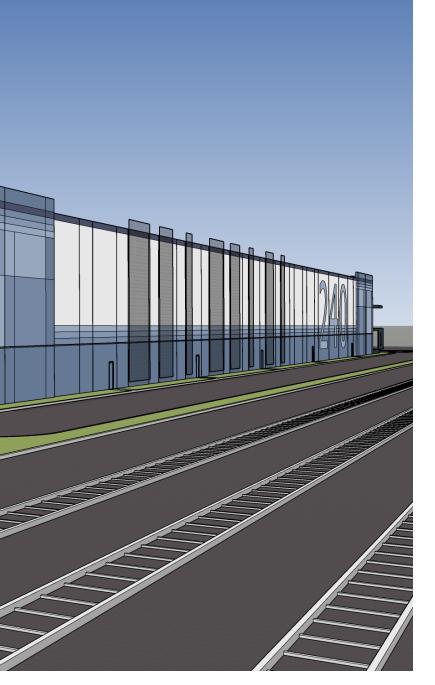
MAIN ENTRANCE

RAILROA

SOUTH WEST CORNER



SOUTH EAST CORNER





NORTH WEST CORNER



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