



PROJECT:


I			PROJECT: FREEMAN ROAD
, I	PLANT LEG	FND	LOGISTICS
	SYMBOL	COMMON NAME	
		STREET TREES (CLASS III-IV) BOULEVARD LINDEN GREEN PILLAR PIN OAK MUSHASHINO ZELCOVA STREET KEEPER HONEYLOCUST MED / LARGE DECIDUOUS TREES (CLASS III-IV) AUTUMN GOLD GINKGO EMERALD QUEEN MAPLE GREENSPIRE LINDEN JEFFERSON ELM	FREEMAN ROAD PUYALLUP, WA CLIENT: VECTOR DEVELOPMENT CO. 11335 NE 122ND WAY, SUITE 105 KIRKLAND, WA 98034
	Ċ	SYCAMORE MAPLE COLUMNAR DECIDUOUS TREES (CLASS II) HORNBEAM PRINCETON SENTRY GINKGO PURPLE DAWYCK BEECH	
MATCHLINE (SEE SHEET	Ŭ.	EVERGREEN TREES (CLASS III-IV) AUSTRIAN PINE DOUGLAS FIR SERBIAN SPRUCE WEEPING ALASKA CEDAR WESTERN RED CEDAR	
		EVERGREEN HEDGE ARBORVITAE HICKS YEW SCHIPKA LAUREL	
		EVERGREEN SHRUBS BOXWOOD DAVIDS VIBURNUM GOSHIKI OSMANTHUS HEAVENLLY BAMBOO HICKS YEW MUGO PINE OREGON GRAPE OTTO LUYKEN LAUREL PORTUGAL LAUREL RED TIPS HONEYSUCKLE SPREADING YEW STRAWBERRY TREE WHITE ROCKROSE	NO. DATE REVISION 11.23.2020 SEPA 19.12.2022 SEPA RESUBMITTAL 11.13.2023 SEPA RESUBMITTAL
		DECIDUOUS SHRUBS ANTHONY WATERER SPIREA JAPANESE BARBERRY NINEBARK REDTWIG DOGWOOD SHRUBBY CINQUEFOIL SNOWBERRY WINGED EUONYMUS	
		GROUNDCOVER BIGROOT CRANESBILL CORAL BEAUTY COTONEASTER DWARF REDTWIG DOGWOOD KINNIKINNICK	DESIGNED CB DRAWN CB CHECKED CB PROFESSIONAL SEAL
		EROSION CONTROL HYDROSEED	
	NOTE: REFER TO SHEET L-3 WITH SIZES. LANDSCAPE CA TOTAL PAVED AREA: REQUIRED PARKING LO PROVIDED PARKING LO	154,300 S.F. T LANDSCAPE AREA: 15,430 S.F. 10%	STATE OF WASHINGTON REGISTERED WILLIAM A. BROWN CERTIFICATE NO. 501 DATE 07.26.2021 PROJECT NO.
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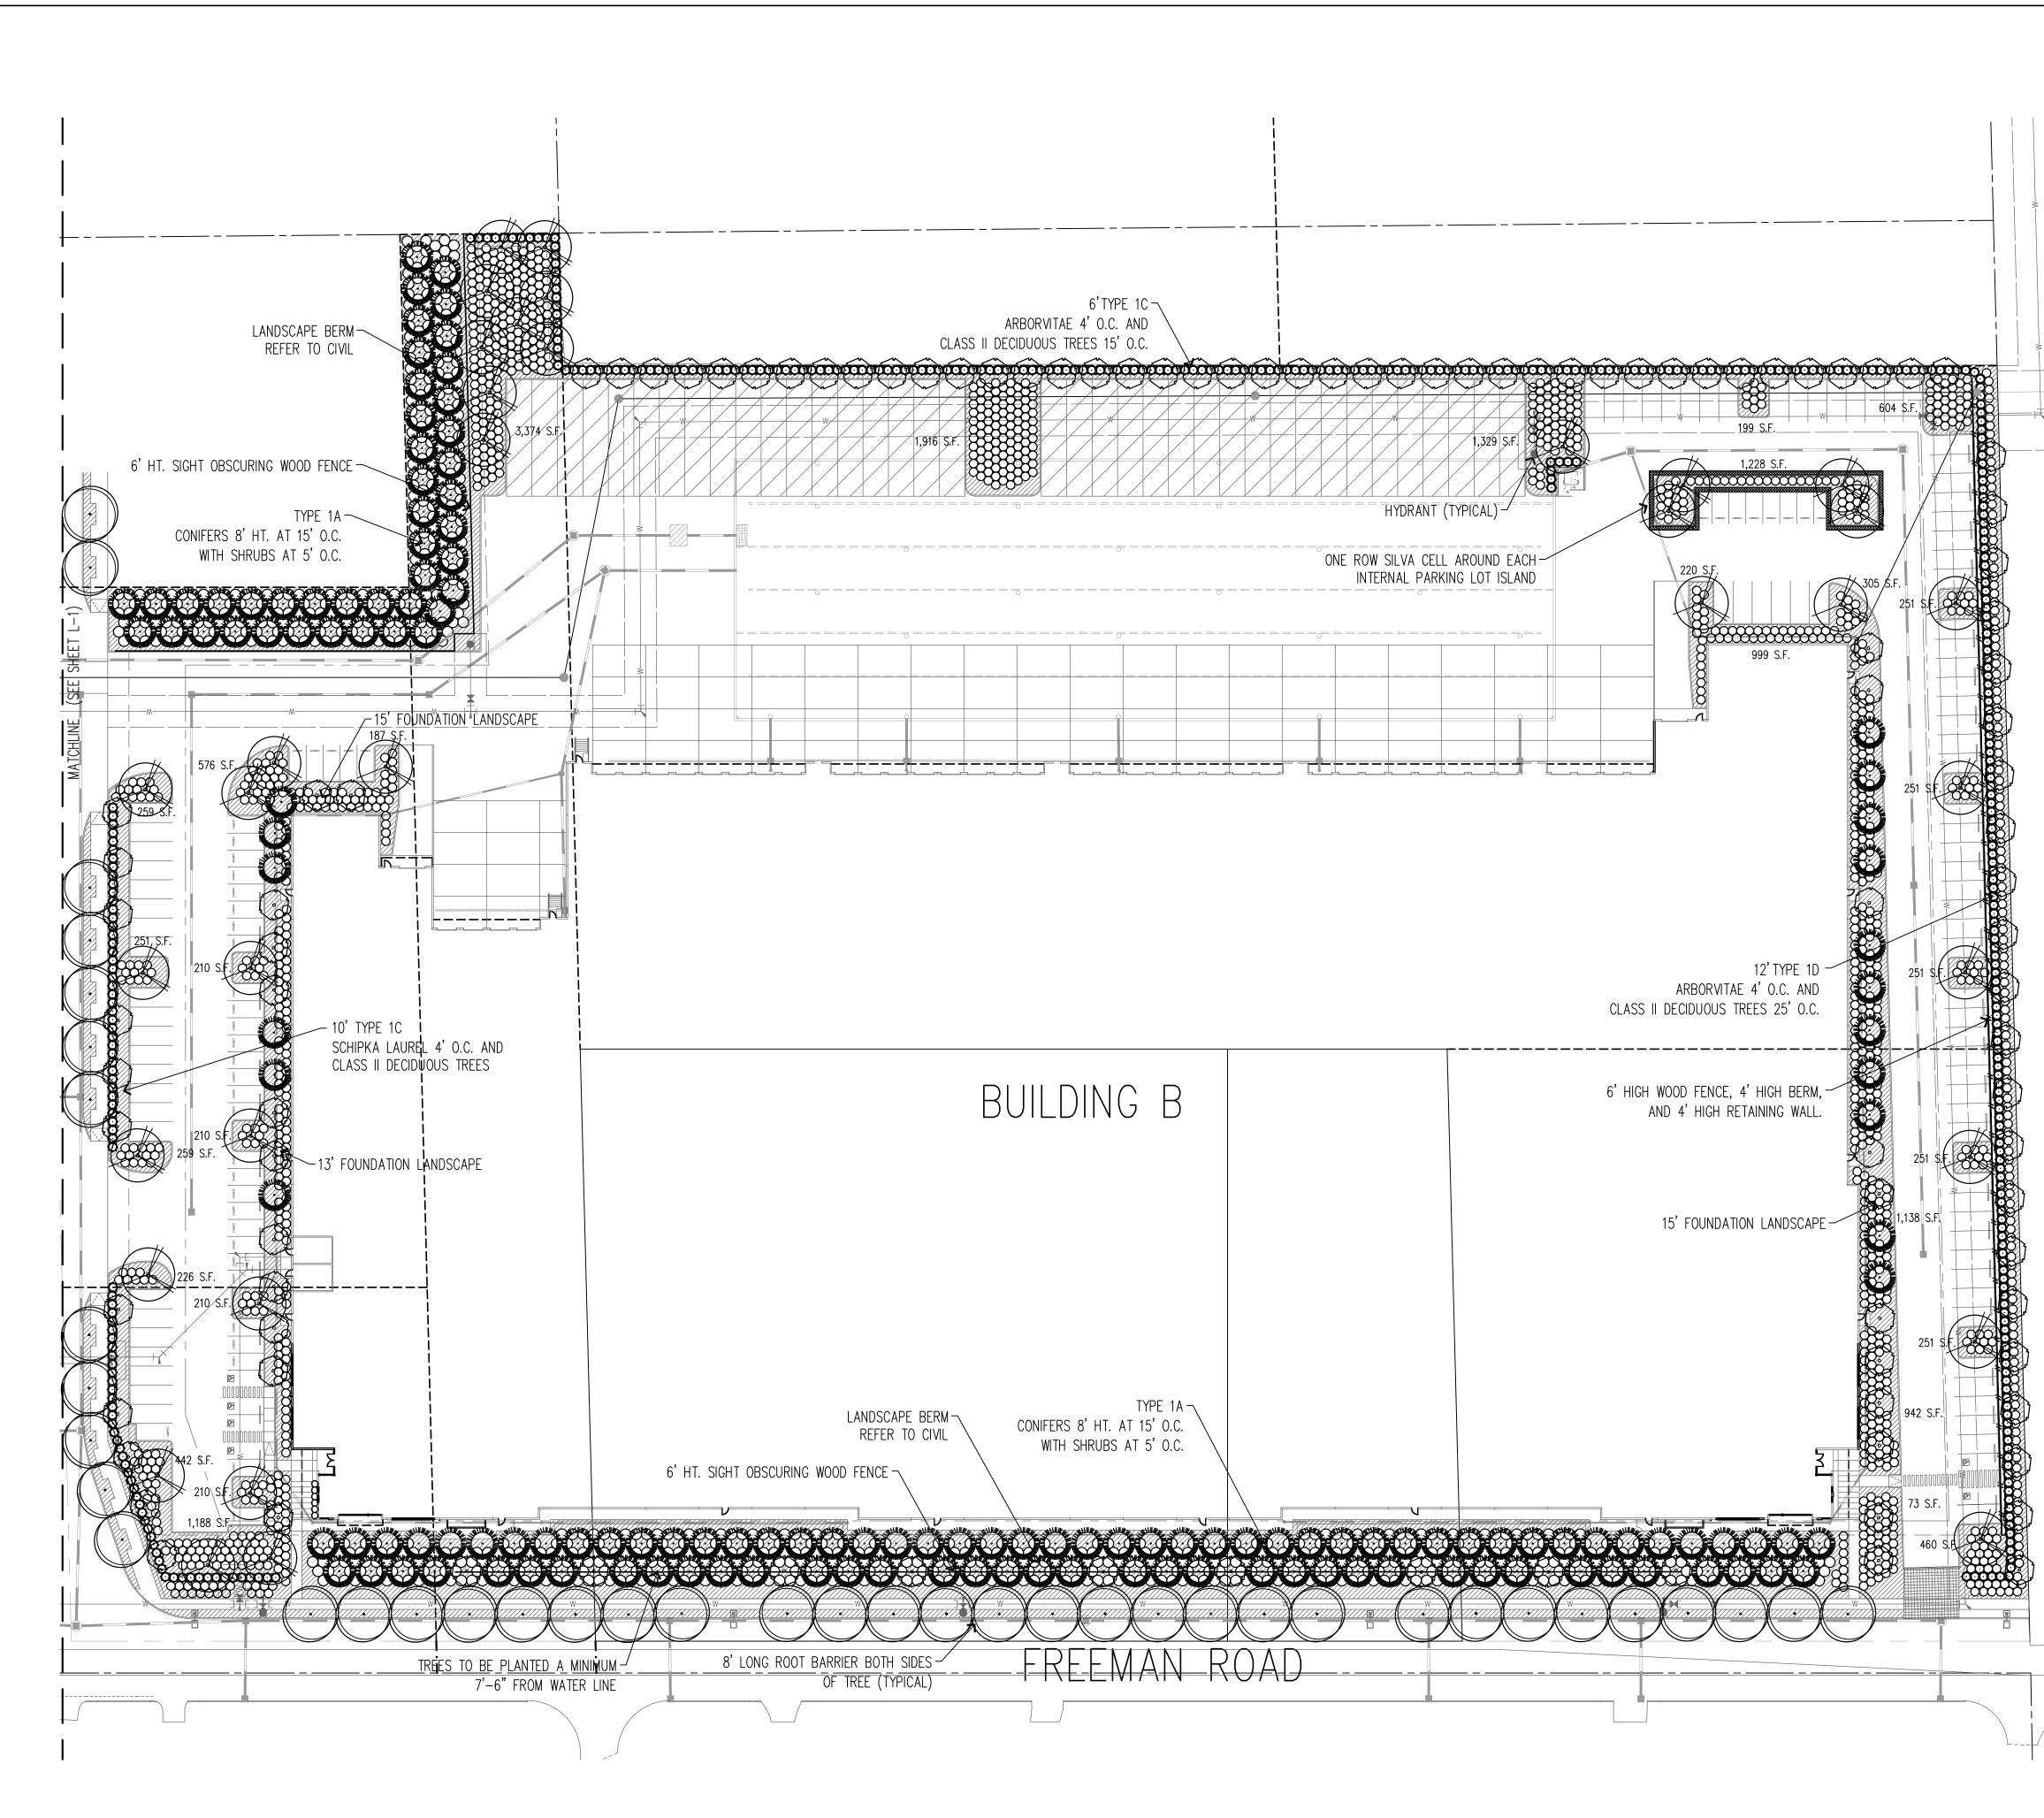
20'

40'

SCALE: 1" = 40' - 0"


SHEET SIZE: 24" x 36" AT 100%



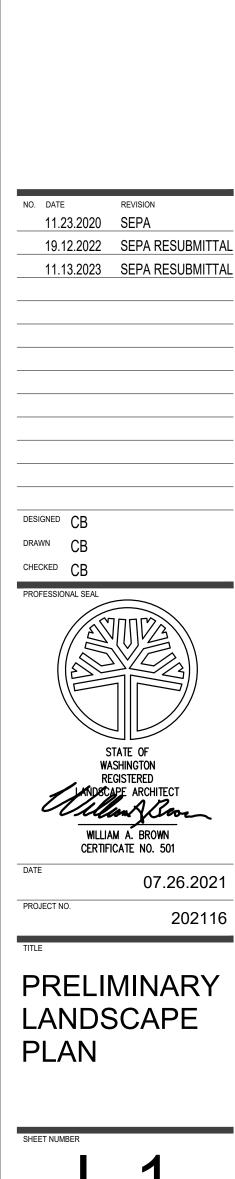




			LA Botnell, WA 98012 phone (425) 417-4609
	PLANT LEG		PROJECT:
	SYMBOL	COMMON NAME	FREEMAN ROAD
		STREET TREES (CLASS III-IV)	LOGISTICS
		BOULEVARD LINDEN GREEN PILLAR PIN OAK MUSHASHINO ZELCOVA STREET KEEPER HONEYLOCUST	LOCATION: FREEMAN ROAD PUYALLUP, WA
		MED / LARGE DECIDUOUS TREES (CLASS III-IV) AUTUMN GOLD GINKGO EMERALD QUEEN MAPLE GREENSPIRE LINDEN JEFFERSON ELM SYCAMORE MAPLE	CLIENT: VECTOR DEVELOPMENT CO. 11335 NE 122ND WAY, SUITE 105
	<u>·</u>	COLUMNAR DECIDUOUS TREES (CLASS II) HORNBEAM PRINCETON SENTRY GINKGO PURPLE DAWYCK BEECH	KIRKLAND, WA 98034
	<u> </u>	EVERGREEN TREES (CLASS III-IV) AUSTRIAN PINE DOUGLAS FIR SERBIAN SPRUCE WEEPING ALASKA CEDAR WESTERN RED CEDAR	
		EVERGREEN HEDGE ARBORVITAE HICKS YEW SCHIPKA LAUREL	
MN		EVERGREEN SHRUBS BOXWOOD DAVIDS VIBURNUM GOSHIKI OSMANTHUS HEAVENLLY BAMBOO HICKS YEW MUGO PINE OREGON GRAPE OTTO LUYKEN LAUREL	
H AVE		PORTUGAL LAUREL RED TIPS HONEYSUCKLE SPREADING YEW STRAWBERRY TREE WHITE ROCKROSE	NO. DATE REVISION
6	000	DECIDUOUS SHRUBS ANTHONY WATERER SPIREA JAPANESE BARBERRY NINEBARK REDTWIG DOGWOOD SHRUBBY CINQUEFOIL SNOWBERRY WINGED EUONYMUS	11.23.2020 SEPA 19.12.2022 SEPA RESUBMITTAL 11.13.2023 SEPA RESUBMITTAL
		GROUNDCOVER BIGROOT CRANESBILL CORAL BEAUTY COTONEASTER DWARF REDTWIG DOGWOOD KINNIKINNICK	DESIGNED CB
	NOTE: REFER TO SHEET L-3 WITH SIZES.	FOR FULL PLANT SCHEDULE	DRAWN CB CHECKED CB
	LANDSCAPE CA	ALCULATIONS 4" X 48" SILVA CELL	PROFESSIONAL SEAL
	LANDSCAPE CA TOTAL PAVED AREA: REQUIRED PARKING LC PROVIDED PARKING LC	ALCULATIONS 166,776 S.F. DT LANDSCAPE AREA: 16,678 S.F. 10%	STATE OF WASHINGTON REGISTERED INNOSCAPE ARCHITECT
			WILLIAM A. BROWN CERTIFICATE NO. 501 DATE 07.26.2021
			PROJECT NO. 202116
	A ∧ 0 20' 40'	NDSCAPE PLAN 80' 160'	PRELIMINARY LANDSCAPE PLAN
	SCALE: 1" =		SHEET NUMBER

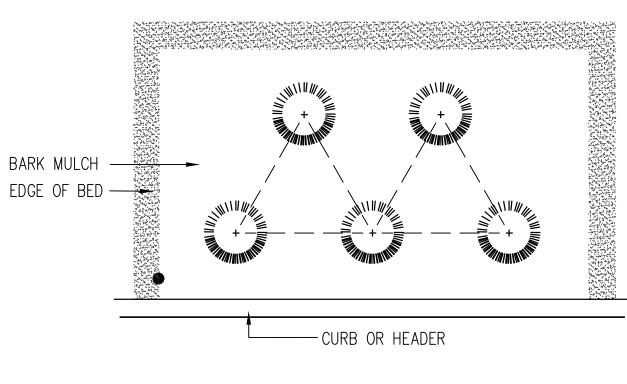

NOTE: SPACING TO BE TRIANG. PER DISTANCE SHOWN ON PLANT SCHEDULE

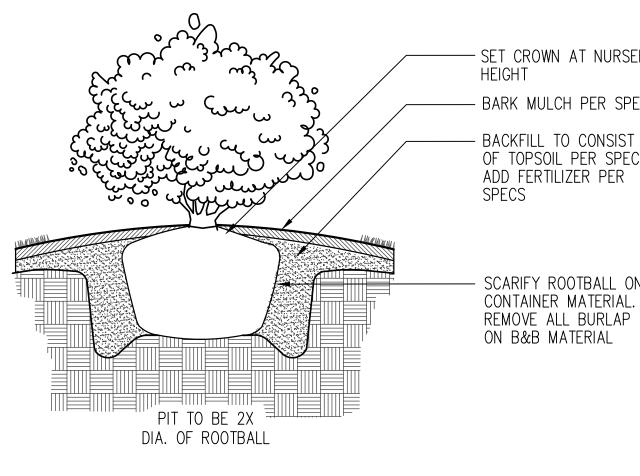

GROUND COVER SPACING NTS

SHRUB PLANTING NTS

2

PLANT SCHEDULE

SYMBOL	BOTANICAL NAME / COMMON NAME		SIZE	REMARKS	SYMBOL	BOTANICAL NAME / COMMON NAME		SIZE	REMARKS	-
SYMBOL SYMBOL	BOTANICAL NAME / COMMON NAME STREET TREES (CLASS III-IV) GLEDITSIA TRIACANTHOS 'DRAVES' / STREET KEEPER HONEYLOCUST QUERCUS PALUSTRIS 'GREEN PILLAR' GREEN PILLAR PIN OAK TILIA AMERICANA 'BOULEVARD' / BOULEVARD LINDEN ZELCOVA SERRATA 'MUSASHINO' / MUSAHSINO COMUNAR ZELCOVA MEDIUM DECIDUOUS TREES (CLASS III-IV) ACER PLATANOIDES 'EMERALD QUEEN' / EMERALD QUEEN MAPLE ACER PSEUDOPLATANUS / SYCAMORE MAPLE GINKGO BILOBA 'AUTUMN GOLD' / AUTUMN GOLD GINKGO TILIA CORDATA 'GREENSPIRE' / GREENSPIRE LINDEN ULMUS AMERICANA 'JEFFERSON' / JEFFERSON ELM COLUMNAR DECIDUOUS TREES (CLASS III-IV) CARPINUS BETULUS 'FRANS FONTAINE' / HORNBEAM AMELANCHIER X G. 'AUTUMN BRILLANCE' / SERVICEBERRY FAGUS SYLVATICA 'DAWYCK' / DAWYCK BEECH EVERGREEN TREES (CLASS II-IV) CHAMAECYPARIS NOOTKATENSIS 'PENDULA' / ALASKA CEDAR PICEA OMORIKA / SERBIAN SPRUCE PINUS NIGRA / AUSTRIAN PINE PSEUDOTSUGA MENZIESII / DOUGLAS FIR THUJA PLICATA 'EXCELSA' / EXCELSA WESTERN RED CEDAR	TBD TBD TBD TBD TBD TBD TBD TBD TBD TBD	MIN. 1" CAL. MIN. 1" CAL. MIN. 1" CAL. MIN. 1" CAL. MIN. 1-1/2" CAL.	REMARKS B & B	STMBOL	EVERGREEN SHRUBS ARBUTUS UNEDO 'COMPACTA' / STRAWBERRY TREE AUCUBA JAPONICA 'ROZANNIE' / JAPANESE AUCUBA BUXUS S. 'GRAHAM BLANDY' / ENGLISH BOXWOOD CISTUS X HYBRIDUS / WHITE ROCKROSE LONIERCA N. 'RED TIPS' / RED TIPS HONEYSUCKLE MAHONIA AQUIFOLIUM 'COMPACTA' / OREGON GRAPE MYRICA CALIFORNICA / PACIFIC WAX MYRTLE NANDINA D. 'SIENNA SUNRISE' / HEAVENLY BAMBOO OSMANTHUS H. 'GOSHIKI'/ VARIEGATED OSMANTHUS PRUNUS L. 'OTTO LUYKEN' / OTTO LUYKEN LAUREL PRUNUS LUSITANICA / PORTUGAL LAUREL TAXUS X MEDIA 'DENSIFORMIS' / SPREADING YEW VIBURNUM DAVIDII / DAVID'S VIBURNUM VIBURNUM T. 'SPRING BOUQUET' / SPRING BOUQUET DECIDUOUS SHRUBS BERBERIS T. ATROPURPUREA 'PYGMY RUBY' / JAPANESE BARBERRY CORNUS SERICEA 'BAILEY' / REDTWIG DOGWOOD EUONYMUS ALATUS 'COMPACTUS' / WINGED EUONYMUS PHYSOCARPUS O. 'SUMMER WINE' / NINEBARK POTENTILLA 'GOLDFINGER' / SHRUBBY CINQUEFOIL SPIRAEA X BUMALDA 'ANTHONY WATERER' / SPIREA SYMPHORICARPOS ALBUS / SNOWBERRY	QIYTBD	5 GAL. 5 GAL.	KEMAKKS	1 2 3 4 6 7 7 8 8 9 9 1
000	EVERGREEN HEDGE PRUNUS L. 'SCHIPKAENSIS' / SCHIPKA LAUREL TAXUS MEDIA X 'HICKSII' / HICKS YEW THUJA OCCIDENTALIS 'FASTIGIATA' / ARBORVITAE	TBD TBD TBD	MIN. 48"HT. MIN. 48"HT. MIN. 48"HT.	B & B B & B B & B	\ <u>\///////////////////////////////////</u>	ORNAMENTAL GRASSES CALAMAGROSTIS X ACUTIFLORA 'KARL FOERSTER' / FEATHER REED GRASS HELICTOTRICHON SEMPERVIRENS / BLUE OAT GRASS GROUNDCOVER ARCHTOSTAPHYLOS UVA–URSI / KINNIKINNICK CORNUS SERICA 'KELSYI' / DWARF REDTWIG DOGWOOD COTONEASTER D. 'CORAL BEAUTY' / COTONEASTER	TBD TBD TBD TBD TBD	1 GAL. 1 GAL. 1 GAL. 1 GAL.	24" O.C. 24" O.C. 36" O.C. 24" O.C. 36" O.C.	1
						GERANIUM MACRORRHIZUM / BIGROOT CRANESBILL EROSION CONTROL SEED MIX: 45% FESTUCA ARUNDINACEA VAR. / DWARF TALL FESCUE 30% LOLIUM PERENNE VAR. BARCLAY / DWARF PERENNIAL RYE (BARCLAY) 20% FESTUCA RUBRA / RED FESCUE 5% AGROSTIS TENUIS 'HIGHLAND STRAIN / COLONIAL BENTGRASS	TBD	1 GAL. HYDROSEED	24"O.C. SEED-80 LBS / ACRE MULCH-1,500 LBS / ACRE	


- SET CROWN AT NURSERY

- BARK MULCH PER SPECS

OF TOPSOIL PER SPECS. ADD FERTILIZER PER

SCARIFY ROOTBALL ON CONTAINER MATERIAL. REMOVE ALL BURLAP ON B&B MATERIAL

PLANT TREES HIGH ENOUGH TO ALLOW POSITIVE DRAINAGE AWAY FROM ROOTBALL

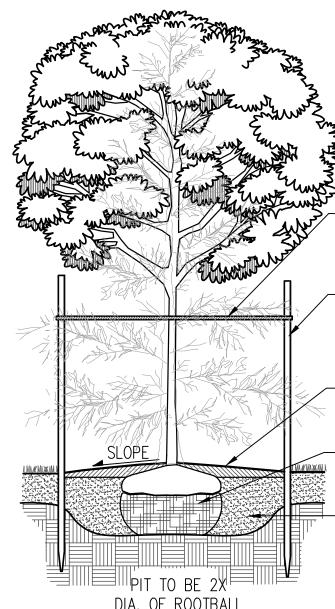

DIA. OF ROOTBALL

SECURE TRUNK WITH DOUBLE STRAND OF 14 GAUGE GALV. WIRE WRAPPED IN CLEAR VINYL. TWIST TIGHT - 2" DIA. "BVC" LODGEPOLE PINE TREE STAKES WITH 6" CONICAL POINT

36" DIA. TREE WELLS IN LAWN AREAS. FILL WITH 2" OF SPECIFIED MULCH - REMOVE ALL BURLAP AND WIRE BASKETS


BACKFILL PIT WITH 50% TOPSOIL AND 50% NATIVE SOIL. ADD SPECIFIED FERTILIZER TO MIX

TREE STAKING 3 NTS

PLANT SCHEDULE

- LANDSCAPE ARCHITECT.
- DESIGN.
- TREE.

- SITE ET SENSOR.

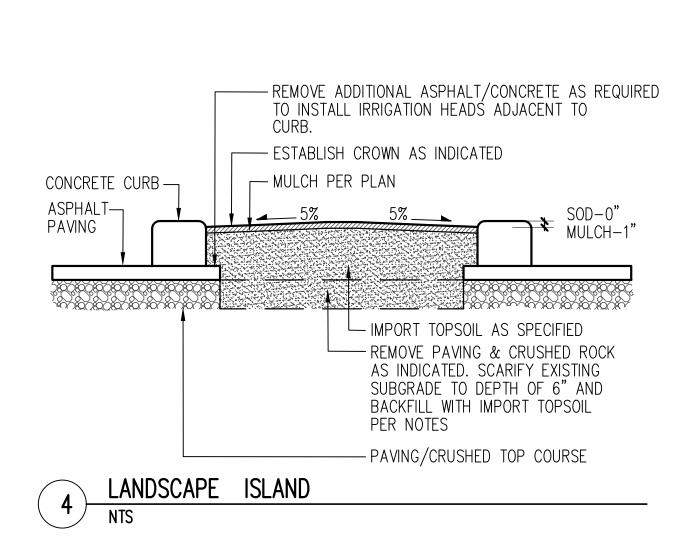

LANDSCAPE NOTES

1. ALL NEW PLANTING BEDS TO RECEIVE A MINIMUM 18" OF TOPSOIL. INSTALLED IN THREE LIFTS OF 6" DEPTH, WITH THE FIRST LIFT ROTOTILLED INTO THE SUBGRADE TO A MINIMUM DEPTH OF 8". TOPSOIL TO CONSIST OF 40% BY VOLUME NATIVE LOAM SOIL, 40% BY VOLUME SAND, AND 20% BY VOLUME COMPOST. TOPSOIL TO BE UNIFORMLY AMENDED FOR FERTILITY AND PH AS RECOMMENDED BY A CURRENT SOILS TEST PROVIDED BY A APPROVED SOIL TEST LABORATORY FOR NEW LANDSCAPE PLANTING.

2. ALL NEW PLANTER BEDS TO HAVE MEDIUM/FINE (3" MINUS) BARK MULCH INSTALLED TO A MINIMUM DEPTH OF 2". MAINTAIN A 6" MULCH FREE RING AROUND TRUNKS OF ALL TREES AND SHRUBS

3. GROUNDCOVER TO EXTEND UNDER ALL DECIDUOUS TREE CANOPIES AT THE SPECIFIED SPACING TO PROVIDE COMPLETE COVERAGE IN ALL PLANTING BEDS SHOWN TO RECEIVE GROUNDCOVER. GROUNDCOVER BENEATH EVERGREEN TREES TO MAINTAIN A 3' CLEARANCE FROM BASE OF TREE.

4. TREES TO MAINTAIN A MINIMUM 5' CLEARANCE FROM FIRE HYDRANTS, 7.5' FROM WATER AND SEWER LINES, 7.5' FROM DRIVEWAYS AND BUILDINGS (TYPE I AND TYPE II), 10' FROM UTILITY POLES AND SIGNS, 30' FROM INTERSECTIONS (FACE OF CURB) AND STREET SIGNS (LEADING SIDE). SHRUBS TO MAINTAIN A MINIMUM 3' CLEARANCE FIRE HYDRANTS, BACKFLOW DEVICES, AND METERS.

5. ALL PLANT MATERIAL HAS BEEN SELECTED TO BE DROUGHT TOLERANT. SUBSTITUTIONS IF REQUIRED TO ALSO BE DROUGHT TOLERANT, BE OF THE SAME GENERAL CHARACTER OF PLANT SUBSTITUTED. AND TO BE APPROVED BY

6. ALL NEW PLANTING TO BE FERTILIZED WITH STARTER FERTILIZER 2–4–2. OR APPROVED EQUAL, APPLIED AT MANUFACTURERS RECOMMENDED RATE. TREES AND SHRUBS TO BE FERTILIZED WITH AGSAFE 20–10–5, 21 GRAM PLANT TABS, APPLIED AT MANUFACTURERS RECOMMENDED RATE. 7. LANDSCAPE DRAWINGS ARE BASED ON THE SITE PLANS PREPARED BY SYNTHESIS ARCHITECTS PLLC. IMMEDIATELY NOTIFY LANDSCAPE ARCHITECT OF ANY FIELD CHANGES TO THE SITE PLAN THAT MAY REQUIRE ADJUSTMENT OF

8. REFER TO CIVIL ENGINEERING DRAWINGS FOR GRADING AND DRAINAGE INFORMATION. IMMEDIATELY NOTIFY LANDSCAPE ARCHITECT ON ANY ADVERSE DRAINAGE CONDITIONS WHICH MAY AFFECT HEALTH OF PLANT MATERIAL.

9. ALL TREES IN PLANTER STRIPS AND TREES WITHIN 4' OF SIDEWALK TO HAVE ROOT BARRIER INSTALLED MEETING CITY OF PUYALLUP STANDARDS. 24" DEEP PANELS A MINIMUM 8' LENGTH CENTERED ON TREE ON SIDEWALK SIDE OF

10. WARRANTY ALL PLANTING FOR 1 YEAR FROM FINAL ACCEPTANCE. REPLACE PLANTING THAT HAS DIED OR DYING. 11. ALL NEW LANDSCAPE TO BE IRRIGATED WITH A HIGH EFFICIENCY IRRIGATION SYSTEM. EROSION CONTROL HYDROSEED TO HAVE TEMPORARY ABOVE GRADE IRRIGATION. TREES AND SHRUBS WITHIN EROSION CONTROL AREAS TO HAVE DRIP POINT SOURCE EMITTERS. IRRIGATION TO BE PROVIDED WITH A ET ADJUSTED IRRIGATION CONTROLLER WITH A ON

12. NO IRRIGATION TO BE INSTALLED WITHIN R.O.W. OR FUTURE R.O.W.



PROJECT: FREEMAN ROAD LOGISTICS

LOCATION: FREEMAN ROAD PUYALLUP, WA

CLIENT: VECTOR DEVELOPMENT CO. 11335 NE 122ND WAY, SUITE 105 KIRKLAND, WA 98034

NO.	DATE	REVISION
	11.23.2020	SEPA
	19.12.2022	SEPA RESUBMITTAL
	11.13.2023	SEPA RESUBMITTAL
DESI	GNED CB	
DRAV	vn CB	
CHEC		
PROF	ESSIONAL SEAL	
DATE	WA RE UNDEC WILLIA CERTIFI	TATE OF SHINGTON GISTERED APE ARCHITECT MA. BROWN ICATE NO. 501 07.26.2021 202116
TITLE	-	
L		SCAPE LS

-3