

119 MAIN ST, STE #200 SEATTLE, WA 98104-2579 (206) 322-3322

PIONEER PARK RESTROOM UPDATES

GENERAL NOTES

1. DRAWINGS AND SPECIFICATIONS ARE COMPLIMENTARY AND WHAT IS CONTAINED IN ONE SHALL BE CONSIDERED TO BE INCLUDED IN BOTH. 2. THE CONTRACT DOCUMENTS ARE COMPRISED OF THE DRAWINGS, PROJECT MANUAL AND ADDENDA (IF

ANY). THE CONTRACT DOCUMENTS ARE CONSIDERED INCOMPLETE UNLESS ALL ELEMENTS LISTED ARE

3. IN THE CASE OF A CONFLICT BETWEEN ANY ASPECT OF THE CONTRACT DOCUMENTS AND ANOTHER, CONTACT THE ARCHITECT IMMEDIATELY FOR DIRECTION. 4. ALL WORK SHALL COMPLY WITH APPLICABLE CODES AND ORDINANCES. IF A CONFLICT ARISES BETWEEN WHAT IS SHOWN IN THE CONTRACT DOCUMENTS AND AN APPLICABLE CODE, PROMPTLY NOTIFY ARCHITECT

FOR DETERMINATION OF HOW TO PROCEED 5. DO NOT SCALE DRAWINGS

6. PERFORM EXCAVATION & FOUNDATION WORK IN CONFORMANCE WITH THE SOILS REPORT AND CONSTRUCTION DOCUMENTS 7. DRAWINGS INDICATE GENERAL & TYPICAL DETAILS OF CONSTRUCTION. WHERE CONDITIONS ARE NOT

SPECIFICALLY INDICATED BUT ARE OF SIMILAR CHARACTER, TYPICAL DETAILS SHALL APPLY.

VICINITY MAP



— PROJECT SITE

PROJECT TEAM

OWNER: CITY OF PUYALLUP

333 SOUTH MERIDIAN PUYALLUP, WA 98371

CONTACT: SARAH HARRIS EMAIL: SARAH@PUYALLUP.GOV PHONE: 253-841-5516

STRUCTURAL ENGINEER: KPFF CONSULTING ENGINEERS

1601 FIFTH AVE, SUITE 1600 SEATTLE, WA 98101

CONTACT: JEFF CREAGAN EMAIL: JEFF.CREAGAN@KPFF.COM PHONE: 206-926-0455

ELECTRICAL ENGINEER: TFWB ENGINEERS 1200 WESTLAKE AVE NORTH, SUITE 509 SEATTLE WA, 98109

CONTACT: KEVIN WARTELLE EMAIL: KEVIN@TF-WB.COM PHONE: 206-413-5022

COST ESTIMATE:

CONTACT: BRITTANY GELLERI EMAIL: BRITTANY@DCWCOST.COM PHONE: 206-259-2997

DCW COST MANAGEMENT 500 YALE AVE NORTH, SUITE 100

SEATTLE, WA 98109

ARCHITECT: ARC ARCHITECTS, INC. 119 S MAIN ST. SUITE 200 SEATLE, WA 98104

PHONE: 206-322-3322 CONTACT: JEFF WANDASIEWICZ, PRINCIPAL EMAIL: WANDASIEWICZ@ARCARCHITECTS.COM

615 2ND AVE SEATTLE, WA 98104

CONTACT: MARK DAVIES EMAIL: MDAVIES@MIGCOM.COM PHONE: 206-223-0326

MECHANICAL ENGINEER: NOTKIN P2S ENGINEERING 920 5TH AVE, SUITE 2300 SEATTLE, WA 98104

CONTACT: PETER EBERLE EMAIL: PETER.EBERLE@P2SINC.COM PHONE: 206-267-6940

ADDITIONAL DOCUMENTS

PROJECT DESCRIPTION

SCOPE OF WORK:

THIS PROJECT IS A CONTINUATION OF ARCHITECTURAL AND ENGINEERING SERVICES STEMMING FROM A PROJECT STUDY. IT INVOLVES AN APPROXIMATE 1,200 SF RENOVATION/ EXPANSION TO THE CURRENT RESTROOM BUILDING WITHIN THE CITY OF PUYALLUP'S PIONEER PARK. ORIGINALLY CONSTRUCTED IN 1974, THE EXISTING BUILDING IS APPROXIMATELY 21' x 28', FEATURING A WOOD SHAKE HIP ROOF, SPLIT FACE MASONRY, AND GLASS BLOCK. THE PREVIOUSLY COMPLETED ASSESSMENT CONCLUDED THAT THE EXISTING INFRASTRUCTURE HAS THE CAPACITY TO ALLOW FOR ADDITIONAL PLUMBING FIXTURES. THE RENOVATION WILL ENSURE A STRUCTURE THAT WILL SERVE A LARGER POPULATION AND ONE THAT WILL SIT IN COHESION WITH THE OTHER EXISTING STRUCTURES LOCATED AT THE SITE.

GOVERNING CODES

SEATTLE MUNICIPAL CODE 2018 SEATTLE BUILDING CODE 2018 SEATTLE EXISTING BUILDING CODE ICC/ ANSI 117.1 - 2009 ACCESSIBILITY CODE

2018 SEATTLE ENERGY CODE 2018 SEATTLE MECHANICAL CODE 2018 SEATTLE PLUMBING CODE

2020 NATIONAL ELECTRICAL CODE W/ SEATTLE ELECTRICAL CODE REPLACEMENT PAGES

2018 SEATTLE FIRE CODE

SHEET INDEX

A3.1

T1.0 PROJECT INFO

ARCHITECTURE

A1.1 SITE PLAN A1.2 DEMO FLOOR PLAN

FLOOR PLAN A2.1 DEMO ROOF PLAN A2.2 A2.3 **ROOF PLAN**

EXTERIOR ELEVATIONS

REFLECTED CEILING PLAN

DESIGN DEVELOPMENT

ISSUE DATE:	APRIL 4	, 2022
REVISION	DATE	DESCRIPTION

COVER SHEET

1/4" = 1'-0" PRC/ EGW **SWL** 0000000.00

\ × × × * ELM PL. EX. PARKING TO REMAIN SEE CIVIL FOR EXTENTS OF DEMO/ NEW PAVING IN RELATION TO NEW UNDERGROUND/ SURFACE WORK EX. FOUNTAIN EX. ELEC WIRE BOX TO BE RELOCATED 57' - 3 1/2" EX. METAL STATUE ~ EX. PARK SIGNAGE -EX. PLAQUE AT EX. TREE EX. BENCH AND LAMPPOST TO BE RELOCATED EX. CONC. SEAT WALL EX. STAGE STRUCTURE EX. STATUE _ & BENCHES

SITE PLAN NOTES:

1. ALL PARTITIONS ARE TYPE A-1 U.O.N.

2. REFER TO T1.0 FOR GENERAL NOTES.

3. SEE CIVIL & LANDSCAPE DRAWINGS FOR EXTERIOR OF BUILDING CONDITIONS BEYOND THE BUILDING PERIMETER.

4. NOT ALL STRUCTURAL, MECHANICAL, AND ELECTRICAL ITEMS ARE SHOWN, REFER TO STRUCTURAL, ELECTRICAL, AND MECHANICAL DWG. COORDINATE LOCATIONS W/ ARCHITECT, IF CONFLICTS ARISE.

5. SEE A3.3 AND A3.4 FOR TYPICAL WALL, FLOOR, AND SLAB ASSEMBLIES, U.O.N.

6. SEE BUILDING ELEVATIONS FOR EXTERIOR MATERIALS.7. REFER TO SCHEDULE SHEETS FOR ADDITIONAL INFORMATION.

8. NOT ALL REQUIRED ACCESS PANELS HAVE BEEN SHOWN. PROVIDE ACCESS PANELS AS REQUIRED. COORDINATE THEIR LOCATION WITH ALL MECHANICAL AND ELECTRICAL ITEMS LOCATED IN CEILINGS AND PAINT TO MATCH ADJACENT

9. SEE FINISH PLANS FOR CONTROL JOINT AND EXPANSION JOINT LOCATIONS AT EXPOSED TO VIEW CONCRETE FLOORS.

10. ROOMS WITH CAPACITY GREATER THAN 50 OCCUPANTS SHALL HAVE CLEARLY VISIBLE SIGNAGE INDICATING OCCUPANT CAPACITY FOR THAT ROOM.

11. THE 1/8"/FT AND 1/4"/FT SLOPES SHOWN @ CONCRETE SLABS FOR FLOOR AND TRENCH DRAINS SET THE DRAIN LOCATIONS. SLOPES SHALL NOT EXCEED 1/4"/FT OR BE LESS THAN 1/8"/FT.

architecture resource collaboration

119 MAIN ST, STE #200 SEATTLE, WA 98104-2579 (206) 322-3322

PIONEER PARK RESTROOM UPDATES

DESIGN DEVELOPMENT

: APRIL 4	, 2022
DATE	DESCRIPTION
	DATE

SITE PLAN

 SCALE:
 As indicated

 DRAWN:
 Author

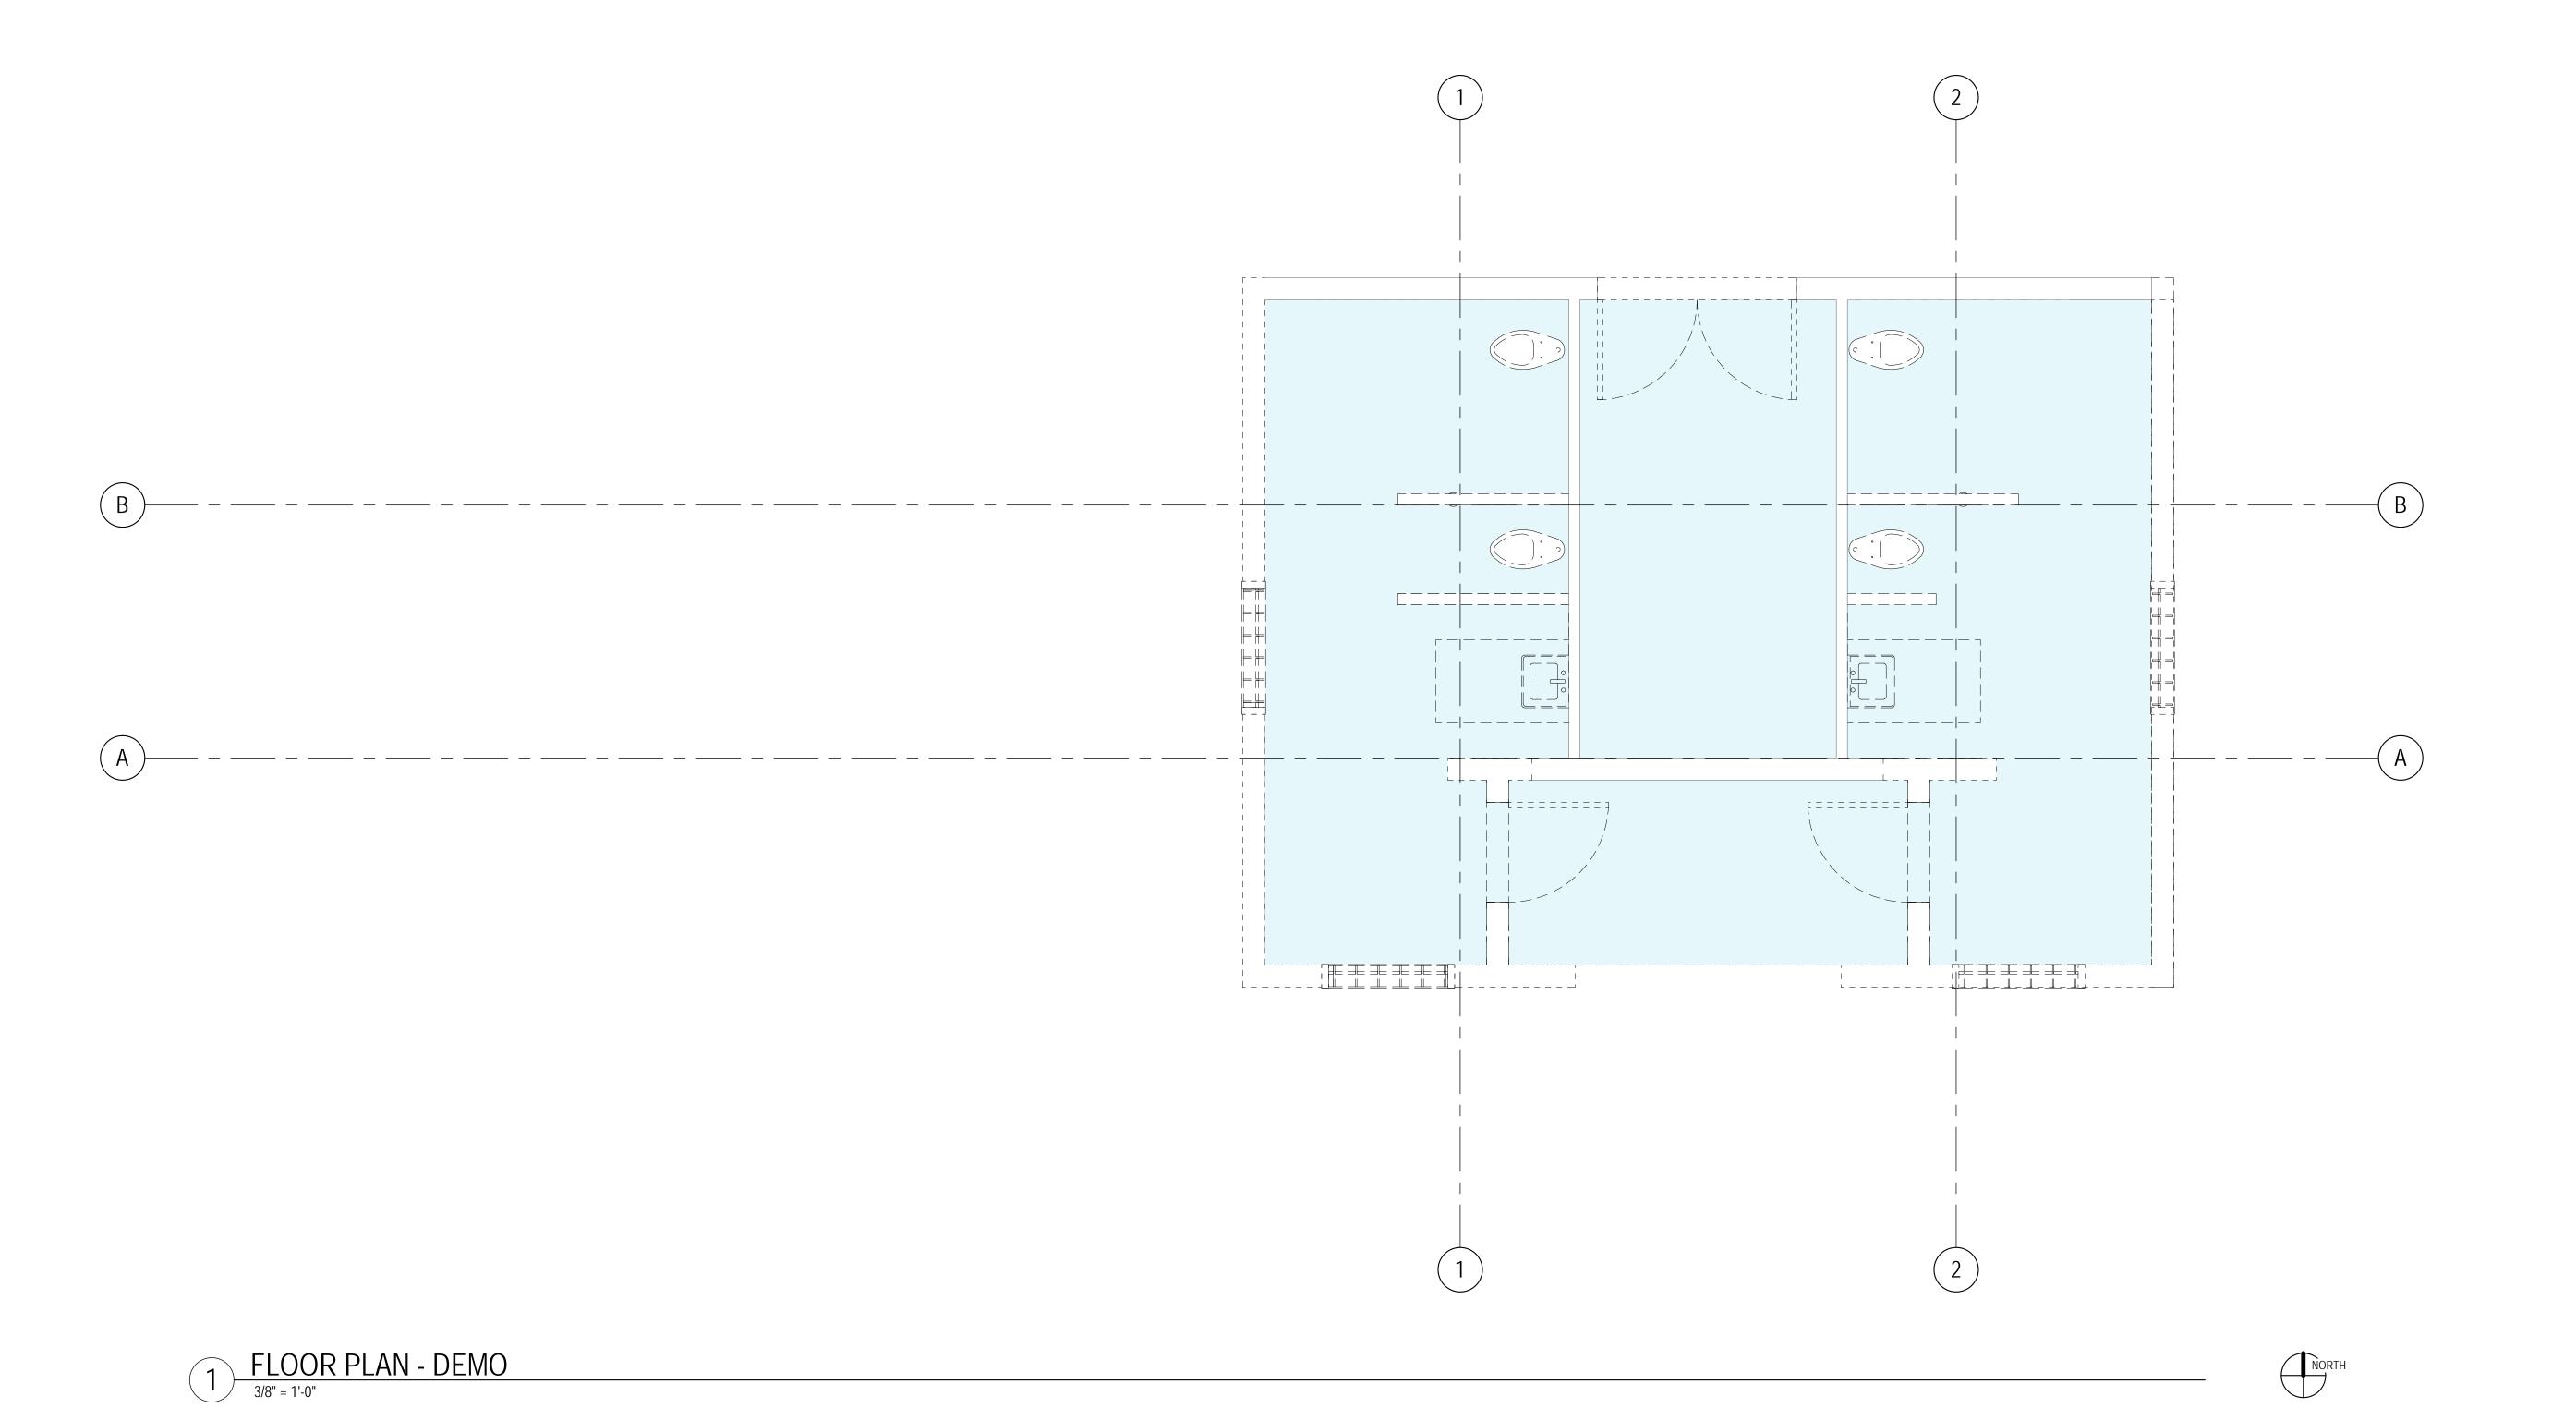
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 PROJECT NO:
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A11



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PIONEER PARK RESTROOM UPDATES

DESIGN DEVELOPMENT

SSUE DATE:	APRIL 4	APRIL 4, 2022	
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DEMO FLOOR
PLAN

 SCALE:
 3/8" = 1'-0"

 DRAWN:
 Author

 CHECKED:
 Checker

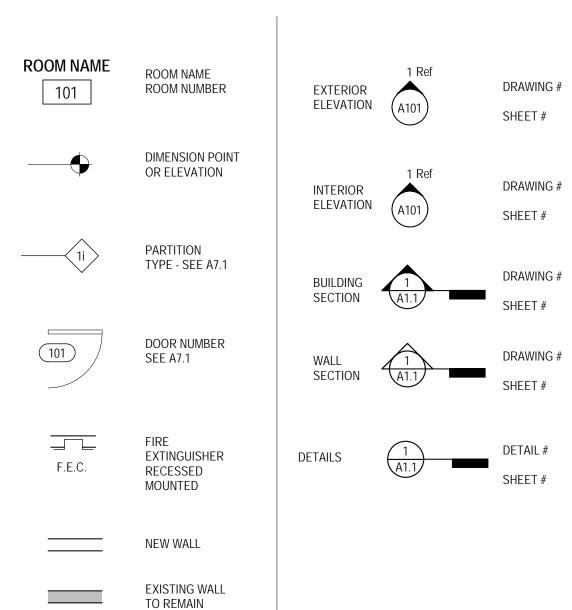
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A1.2

LEGEND



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PLAN NOTES:

1. REFER TO T1.0 FOR GENERAL NOTES.

2. SEE CIVIL & LANDSCAPE DRAWINGS FOR EXTERIOR OF BUILDING CONDITIONS BEYOND THE BUILDING PERIMETER.

3. SEE A3.4, A3.5 AND A3.6 FOR TYPICAL WALL, FLOOR, AND SLAB BUILDING ASSEMBLIES, U.O.N.

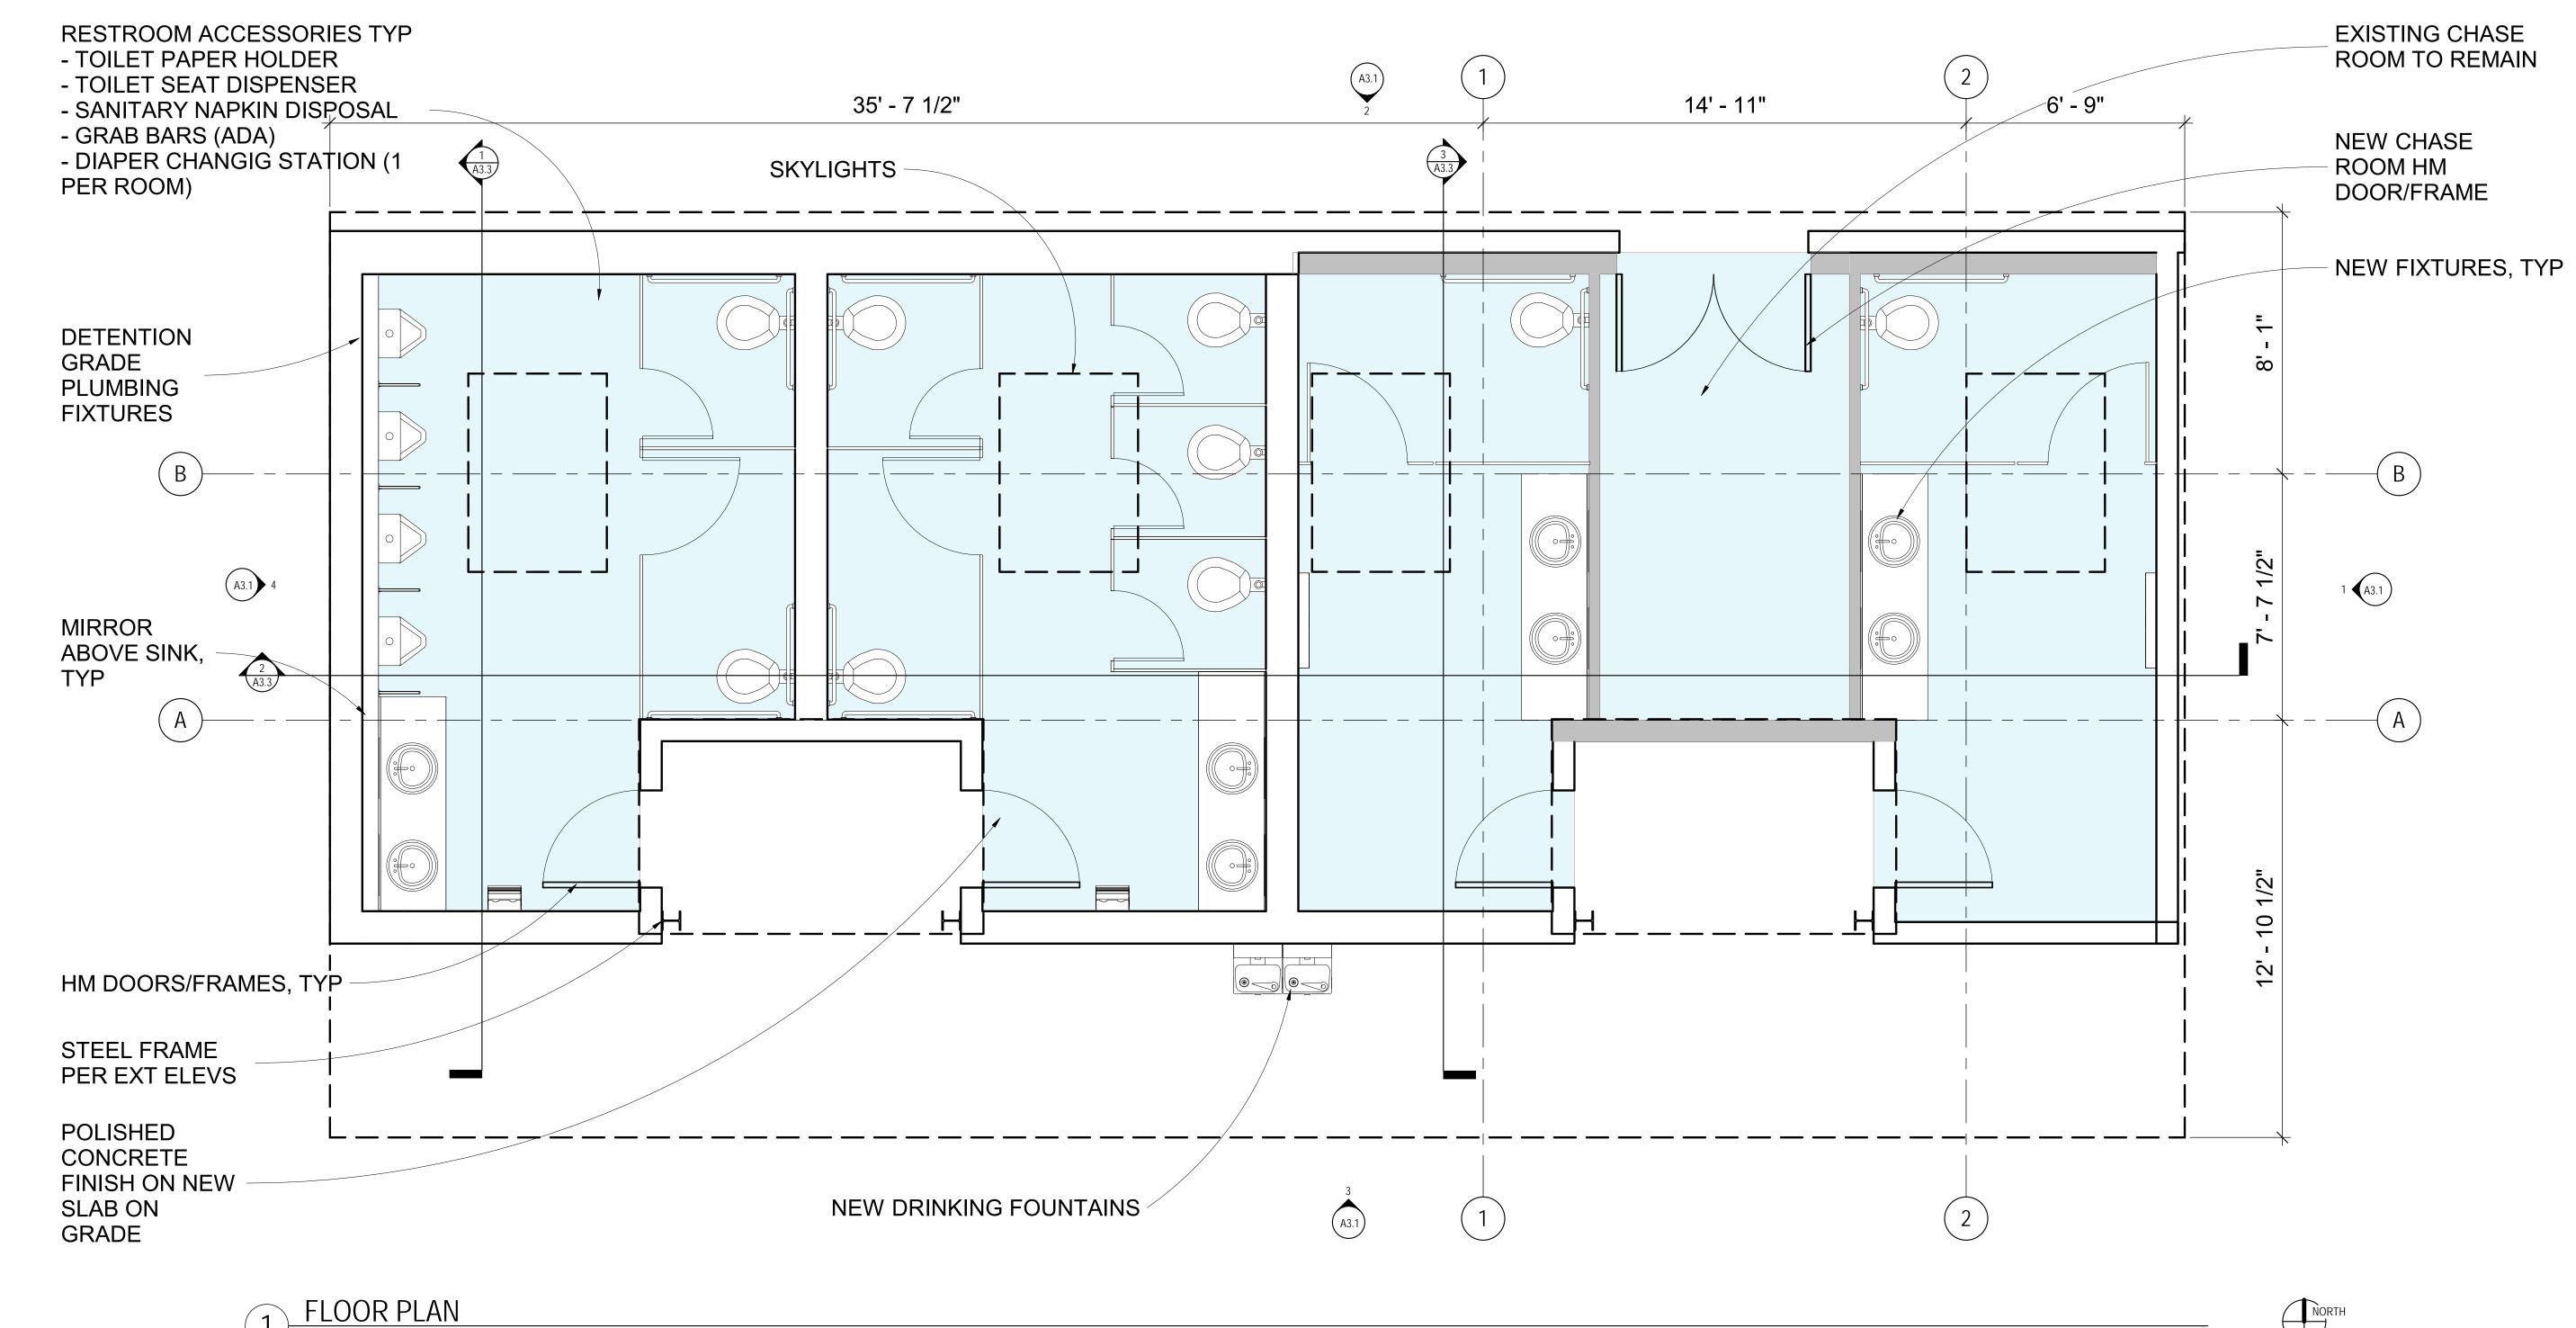
4. SEE BUILDING ELEVATIONS FOR EXTERIOR MATERIALS & DETAILS

5. REFER TO SCHEDULE SHEETS FOR ADDITIONAL INFORMATION.

6. NOT ALL REQUIRED ACCESS PANELS HAVE BEEN SHOWN. PROVIDE ACCESS PANELS AS REQUIRED. COORDINATE THEIR LOCATION WITH ALL MECHANICAL AND ELECTRICAL ITEMS LOCATED IN CEILINGS AND PAINT TO MATCH ADJACENT SURFACES.

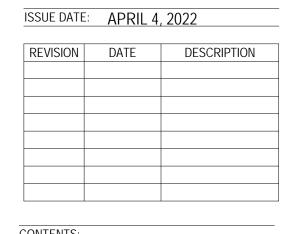
7. SEE FINISH PLANS FOR CONTROL JOINT AND EXPANSION JOINT LOCATIONS AT EXPOSED TO VIEW CONCRETE FLOORS.

8. ROOMS WITH CAPACITY GREATER THAN 50 OCCUPANTS SHALL HAVE CLEARLY VISIBLE SIGNAGE INDICATING OCCUPANT CAPACITY FOR THAT ROOM.



IONEER PARK ESTROOM UPDATES

DESIGN DEVELOPMENT



FLOOR PLAN

 SCALE:
 As indicated

 DRAWN:
 Author

 CHECKED:
 Checker

 PROJECT NO:
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A2.1



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DEMO ENTIRE ROOF ASSEMBLY 1 ROOF PLAN 3/8" = 1'-0"

ONEER PARK ESTROOM UPDATES

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DEMO ROOF PLAN

 SCALE:
 3/8" = 1'-0"

 DRAWN:
 Author

 CHECKED:
 Checker

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A2.2

ROOF PLAN NOTES:

1. FOR ROOF TYPE ASSEMBLIES - SEE BUILDING SECTIONS

2. FLAT STOCK INSULATION AT ALL AREAS, EXCEPT CRICKETS AT EQUIPMENT & SKYLIGHTS, ETC.

3. SEE EXTERIOR ELEVATIONS FOR DOWNSPOUT LOCATIONS.

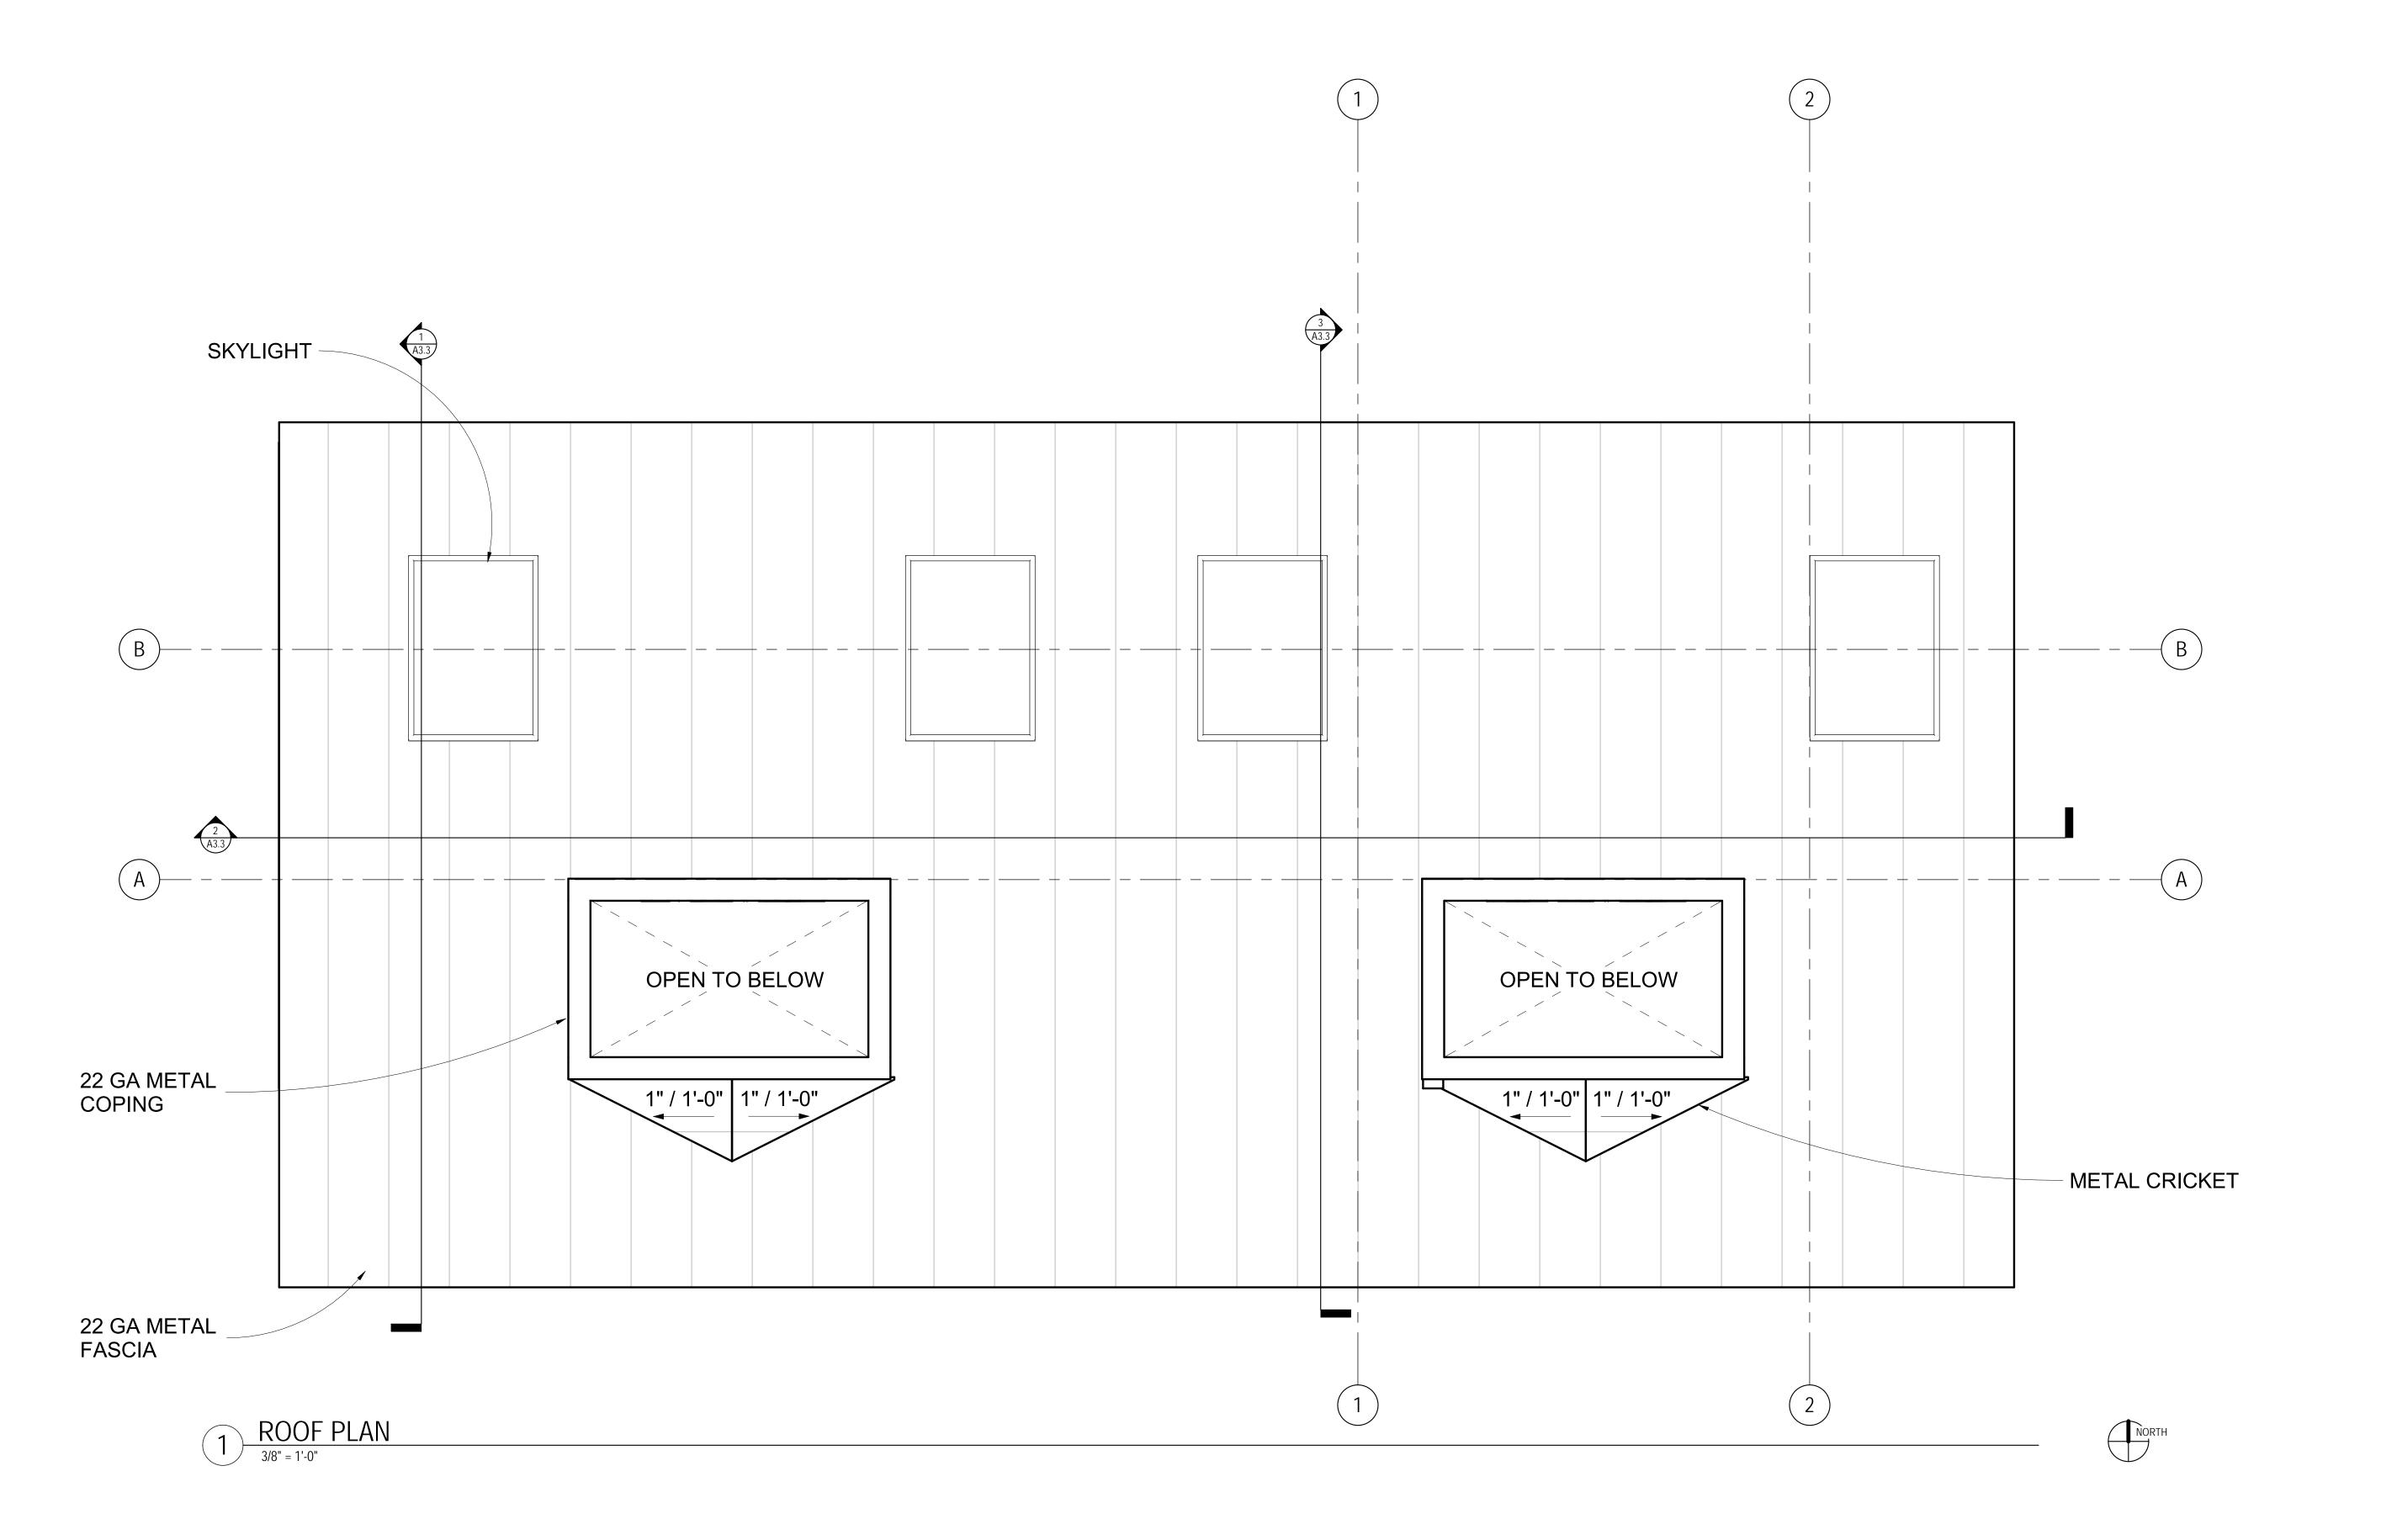
4. FOR STEEL ELEVATIONS, SEE STRUCTURAL. FOR BOTTOM OF DECK ELEVATIONS, SEE ARCHITECTURAL BUILDING AND WALL SECTIONS.

5. DRAWINGS INDICATE GENERAL & TYPICAL DETAILS OF CONSTRUCTION. WHERE CONDITIONS ARE NOT SPECIFICALLY INDICATED BUT ARE OF SIMILAR CHARACTER, TYPICAL DETAILS SHALL APPLY.

6. ROOF PIPING AND VENT PENETRATION LOCATIONS ARE SHOWN FOR CONTRACTOR COORDINATION AND FOR DESIGN INTENT. FOR ACTUAL PENETRATION QUANTITIES REQUIRED, SEE MECH SHEETS



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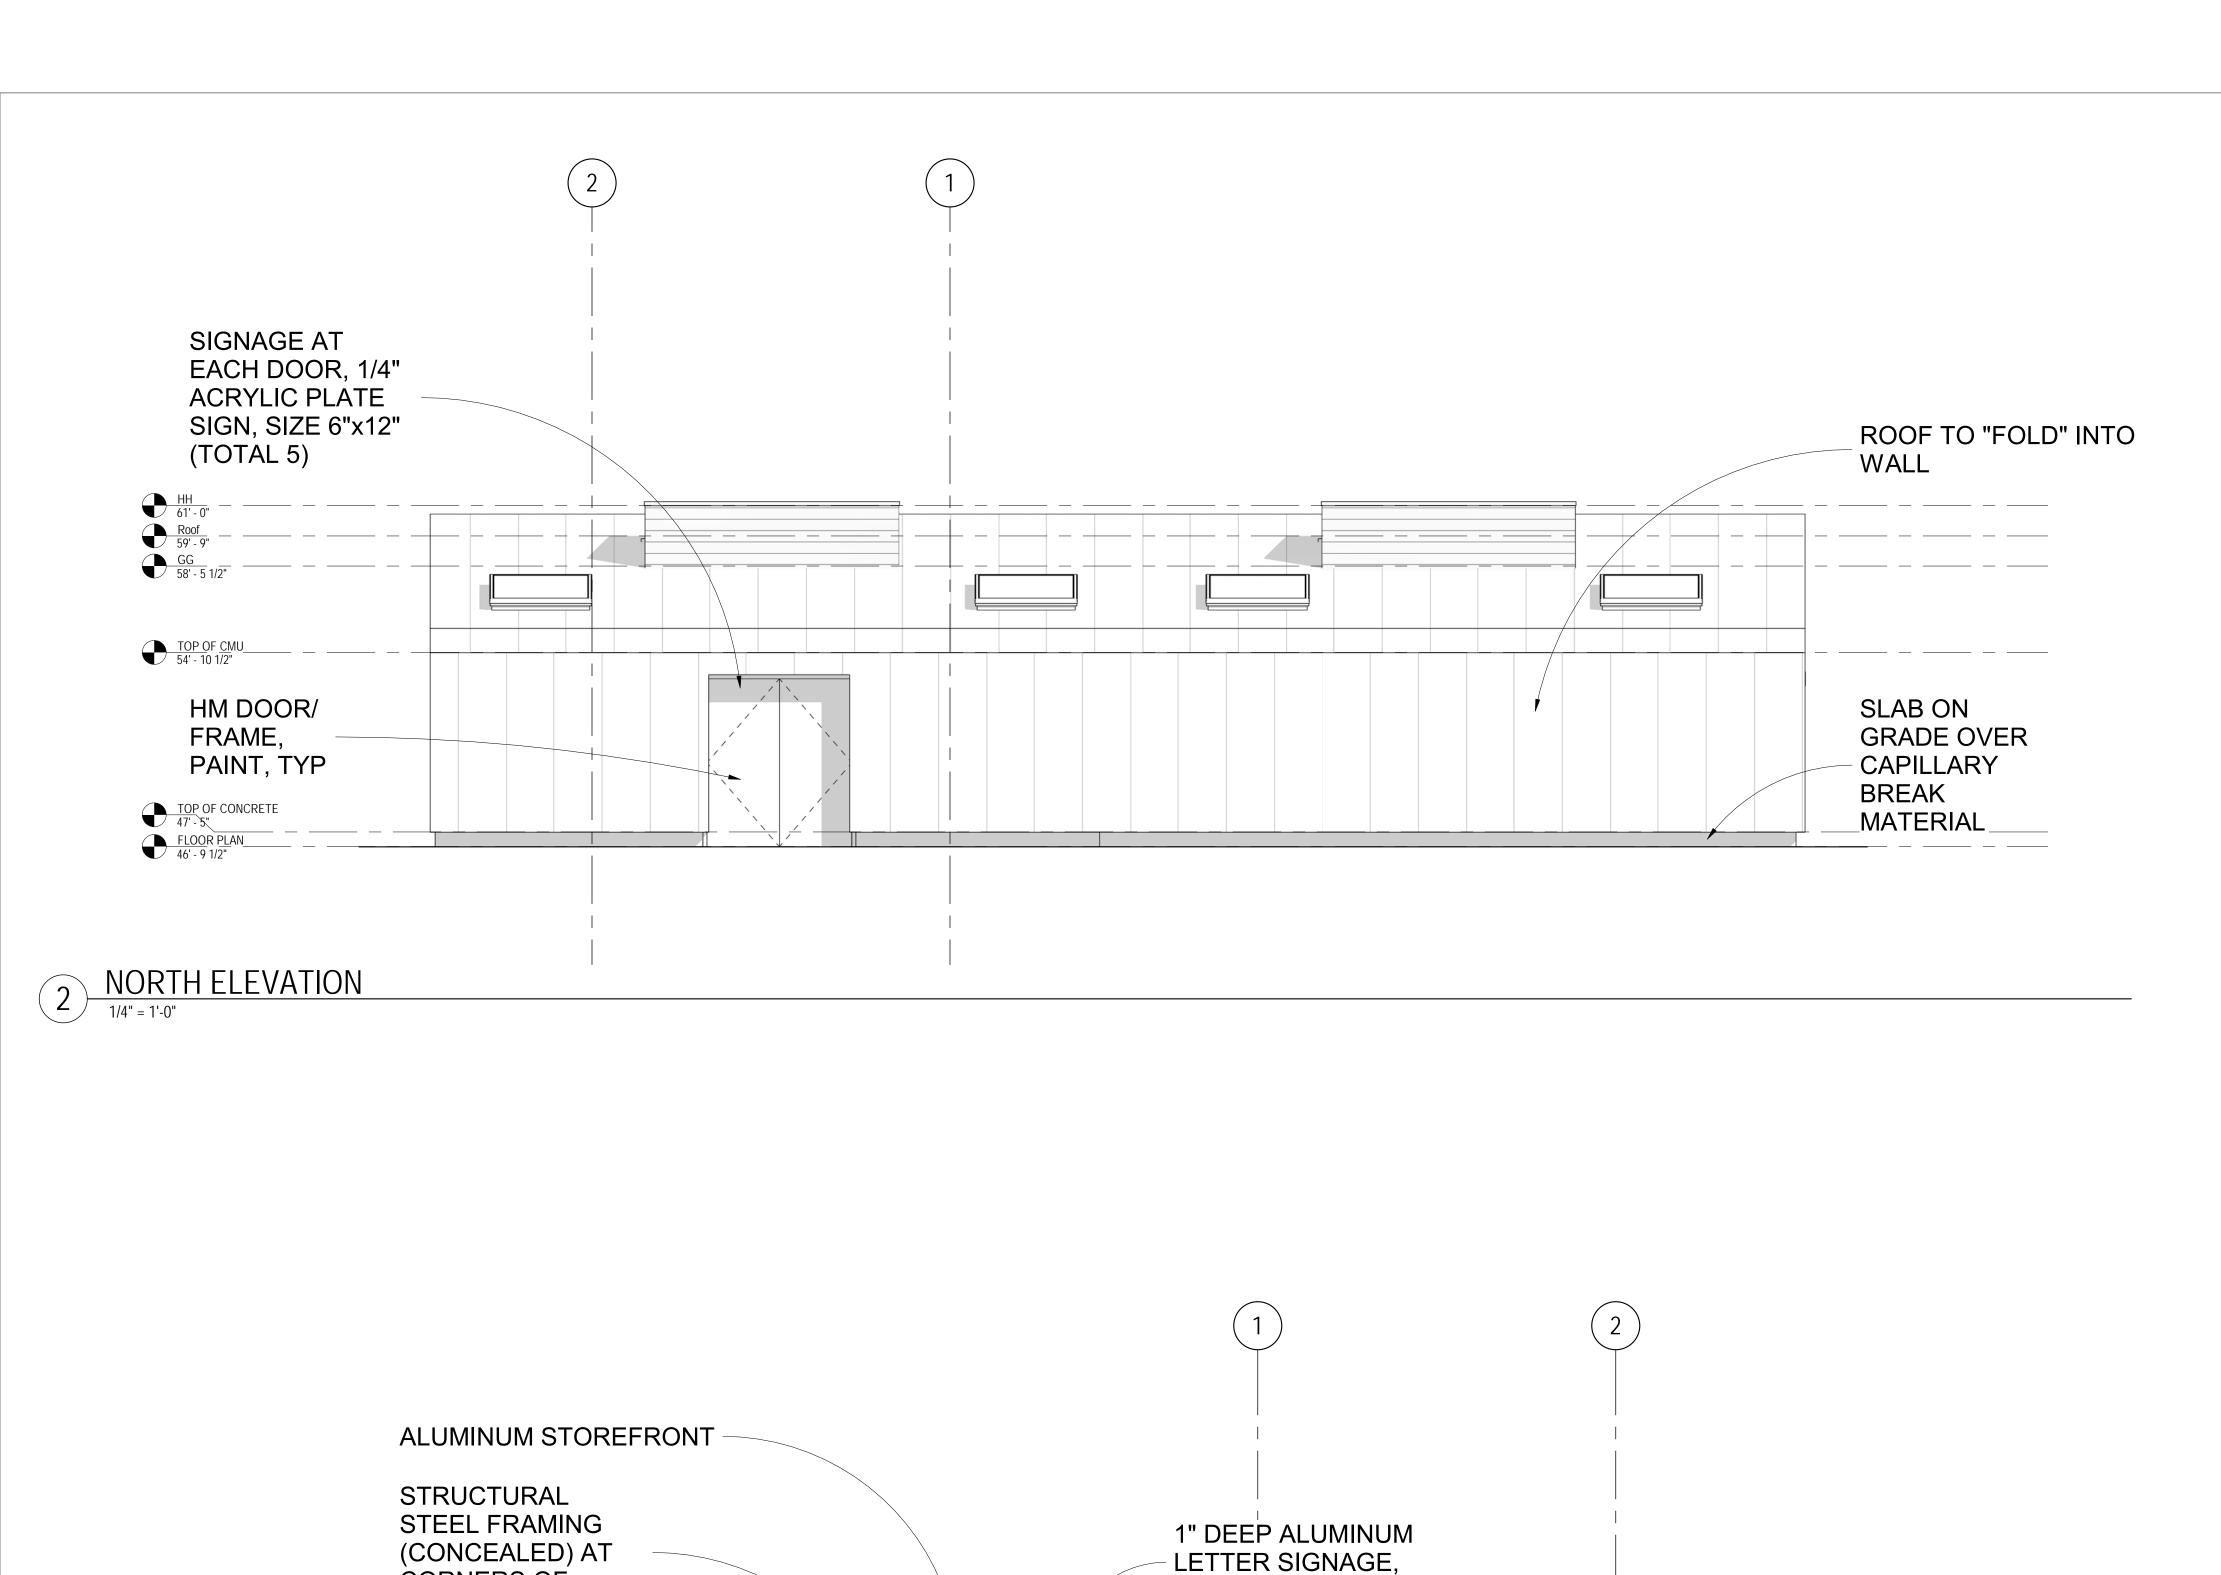
VEER PARK TROOM UPDATES

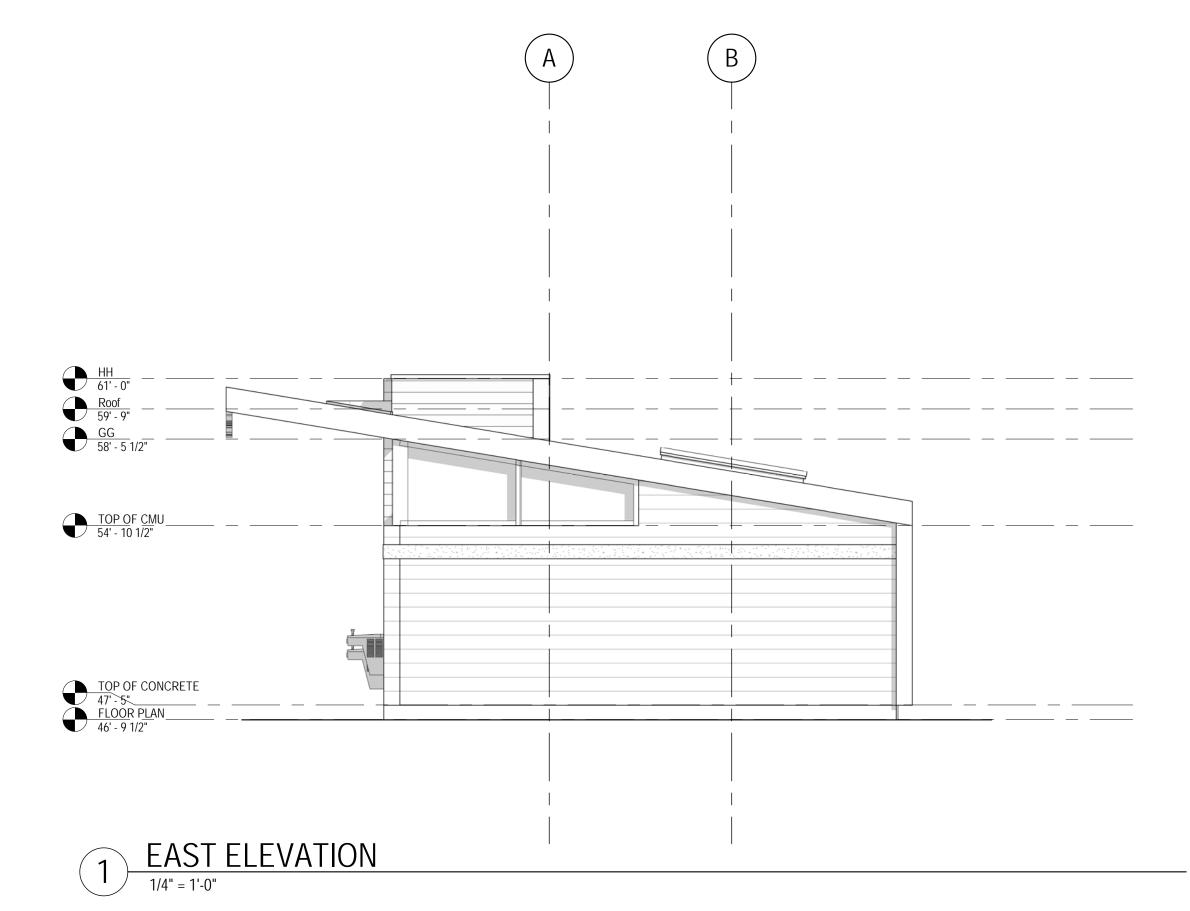
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A2.3



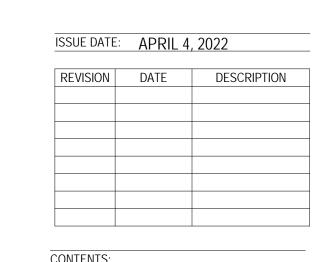




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> DESIGN DEVELOPMENT



EXTERIOR ELEVATIONS

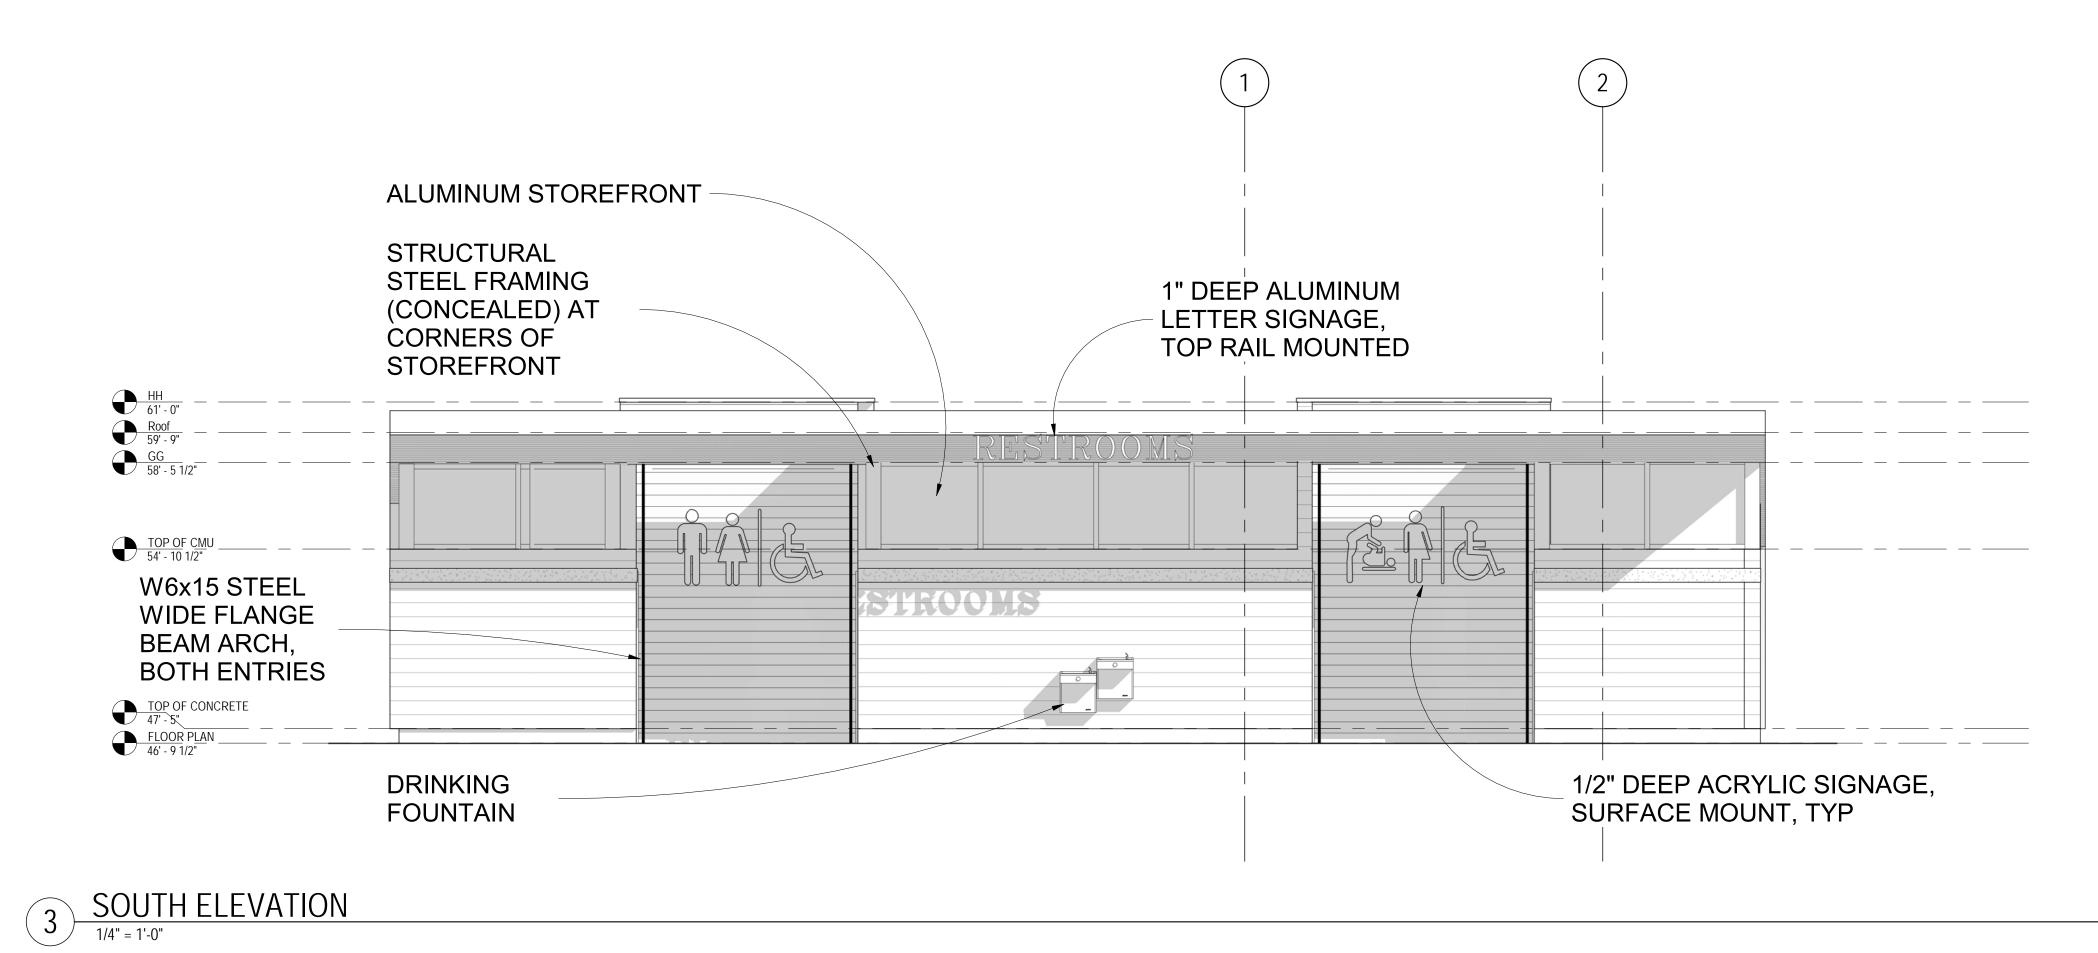
 SCALE:
 1/4" = 1'-0"

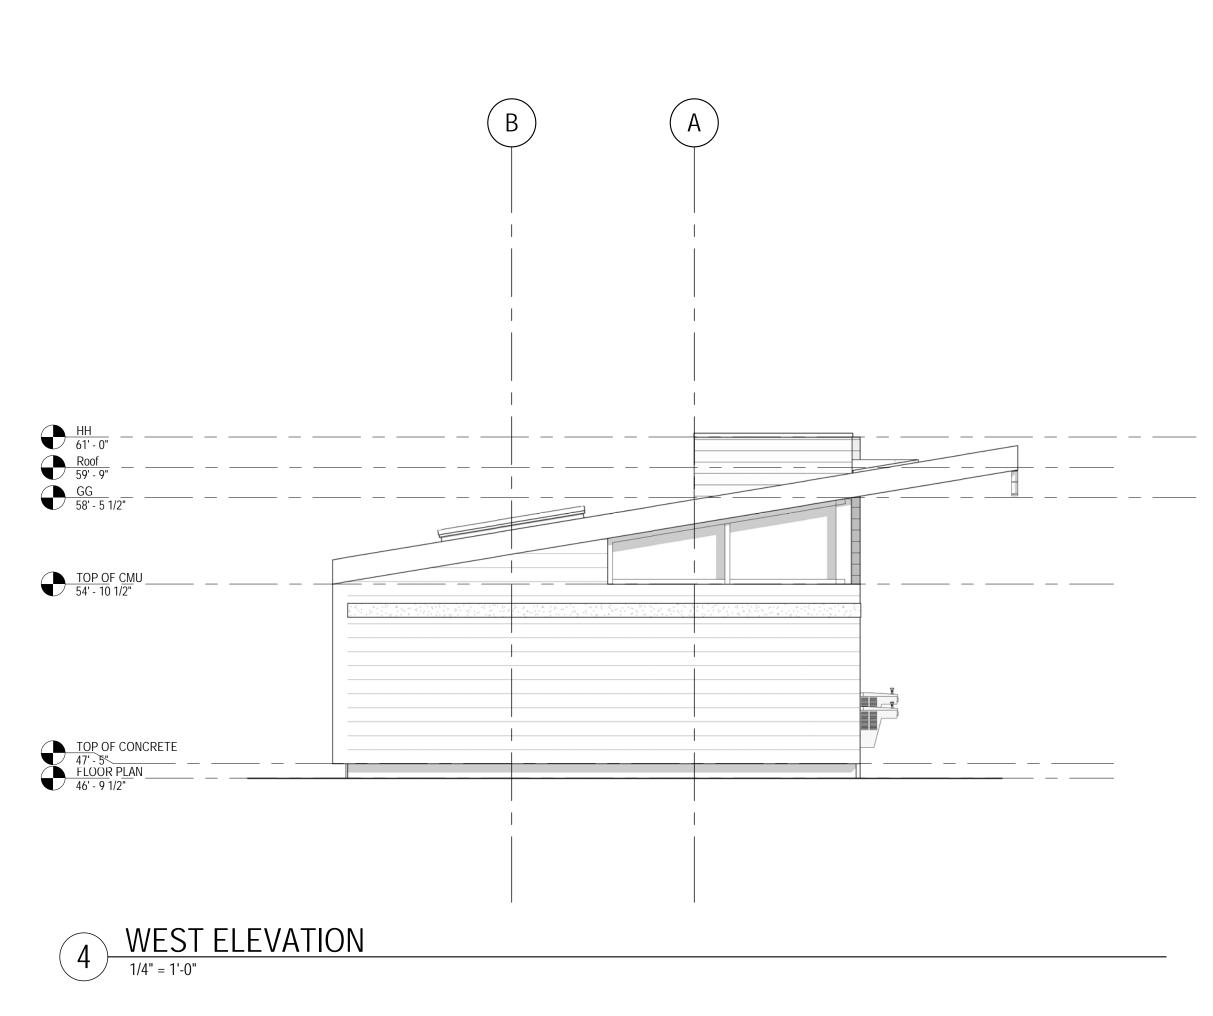
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A3.1

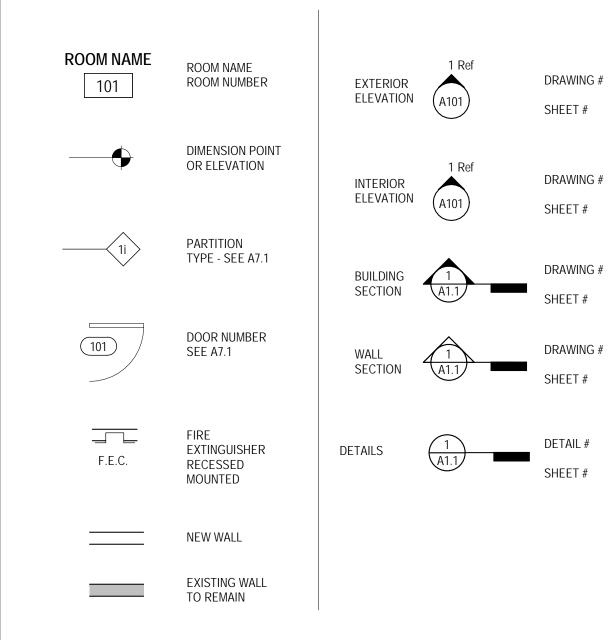




CEILING PLAN NOTES:

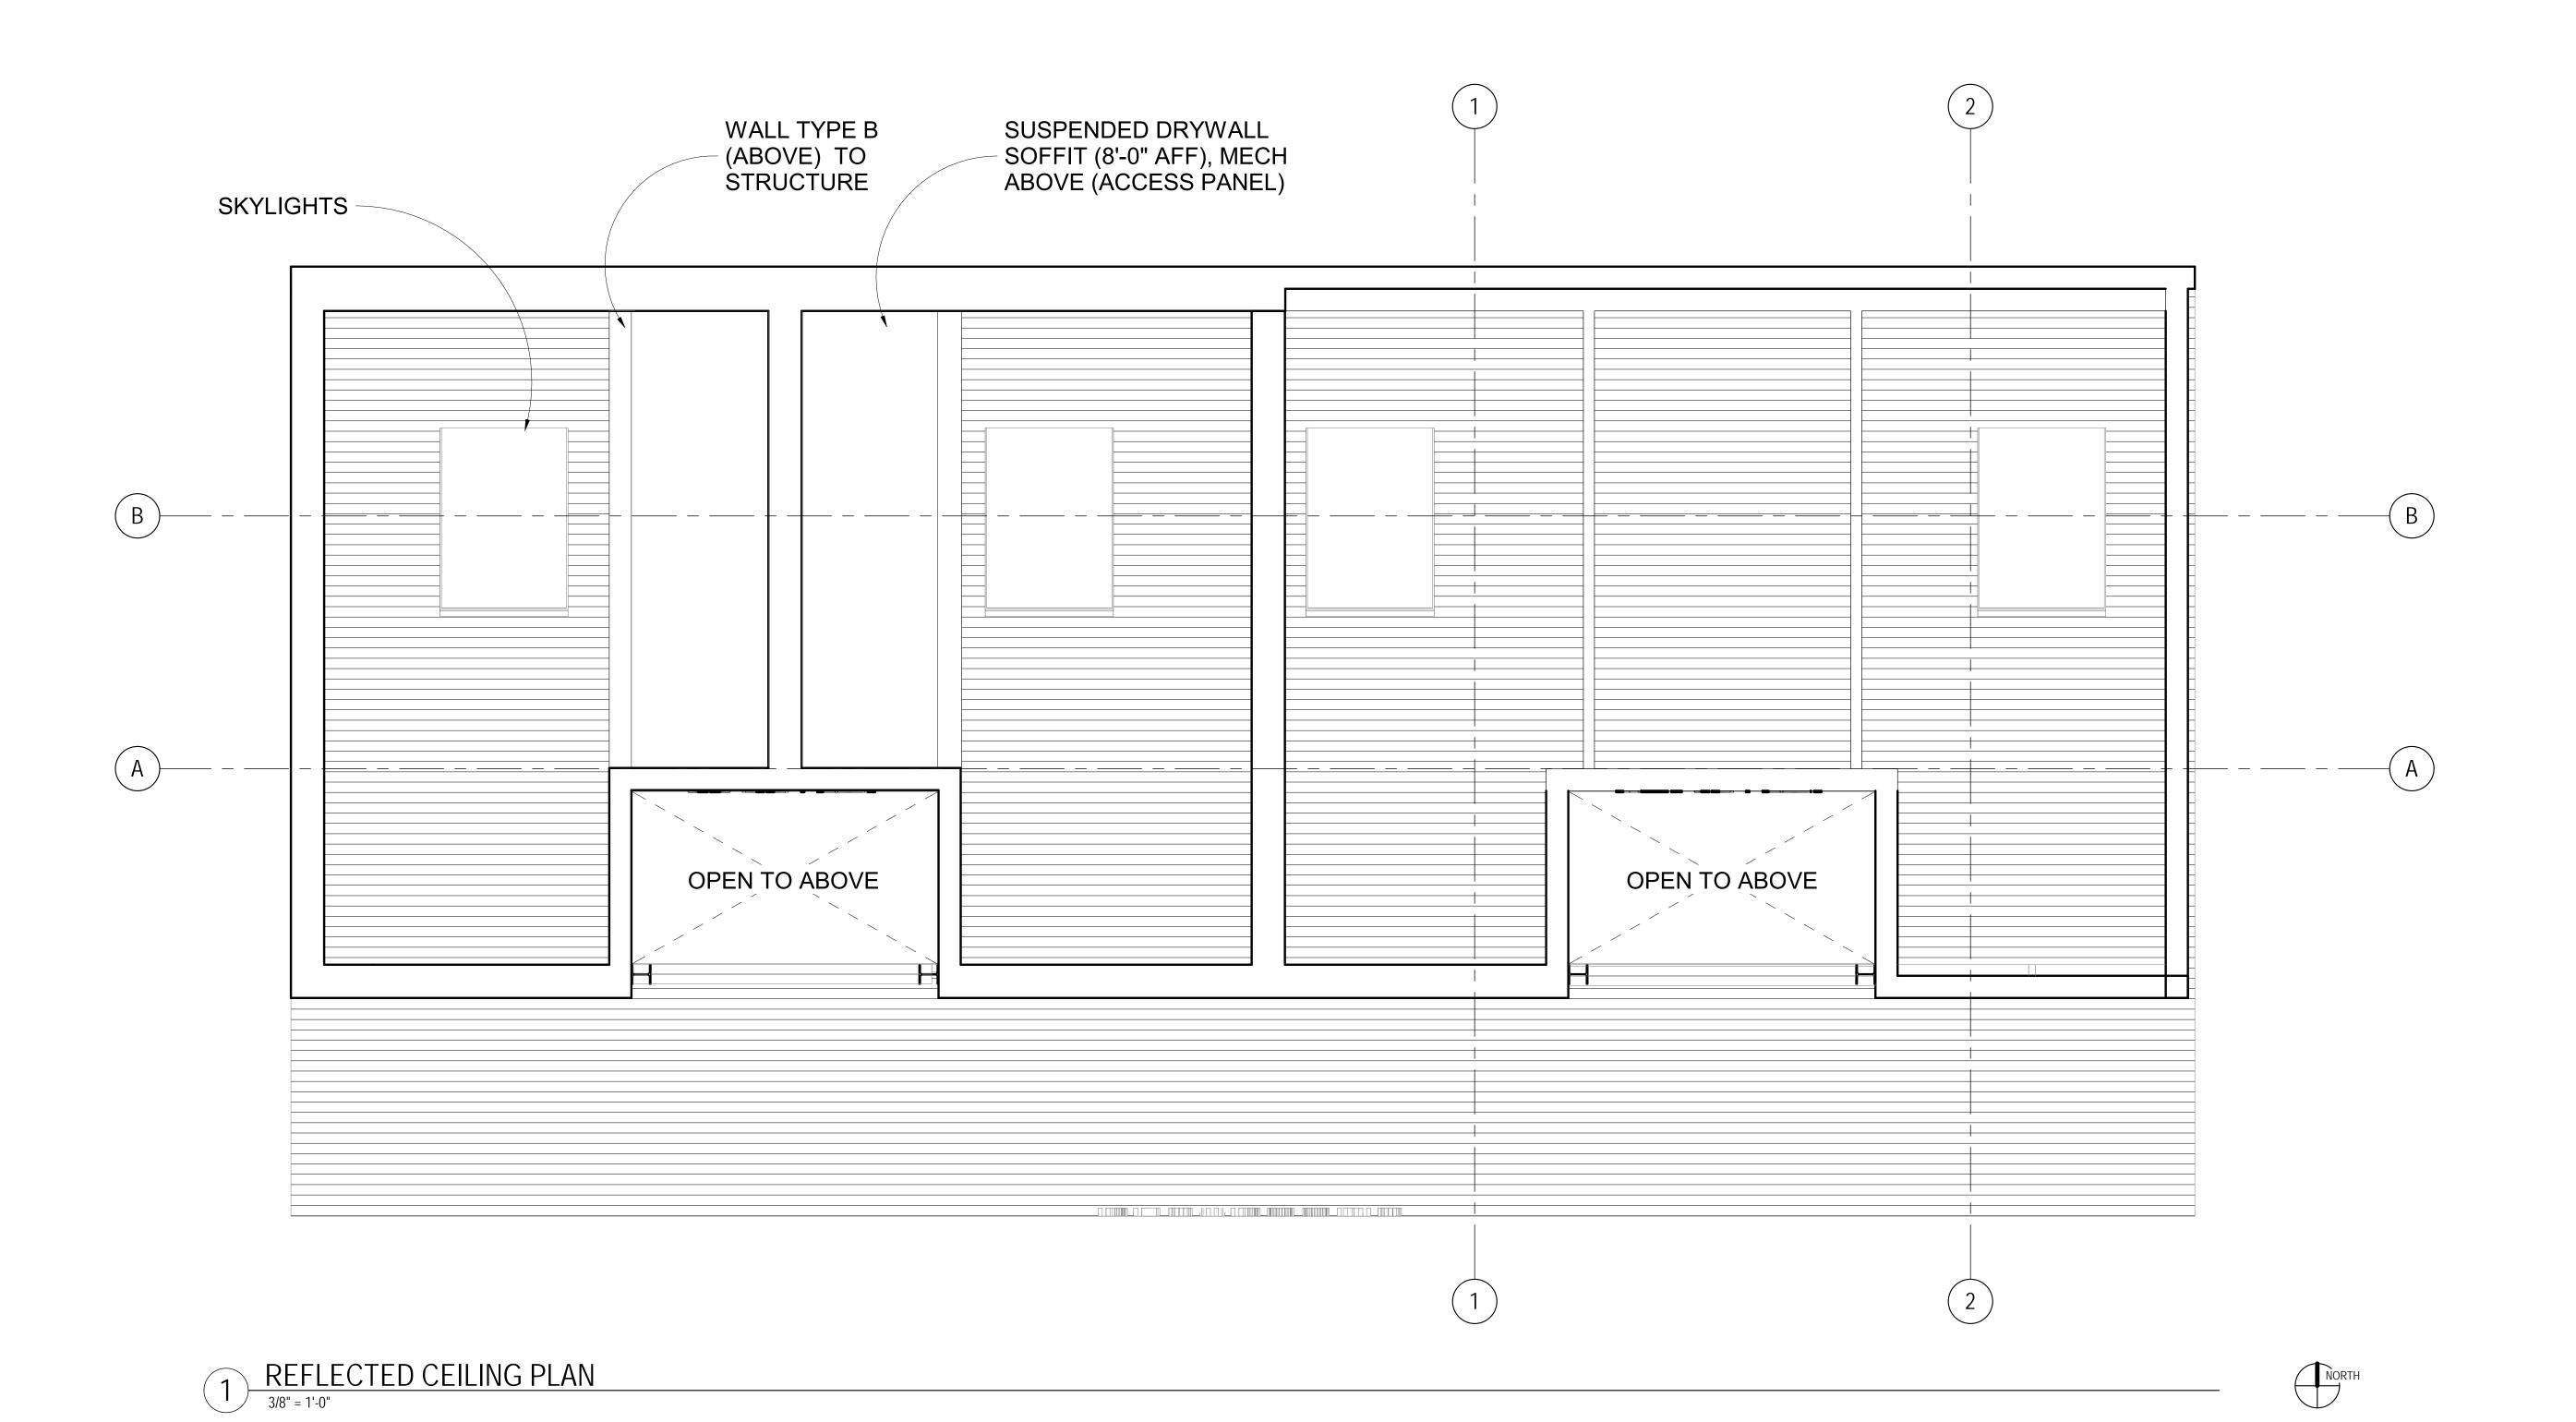
- 1. REFER TO T1.0 FOR GENERAL NOTES.
- 2. SEE ELECTRICAL AND MECHANICAL DRAWINGS FOR ADDITIONAL INFORMATION, INCLUDING DEVICES NOT SHOWN ON THESE DRAWINGS.
- 3. ALL GWB CEILINGS AND SOFFITS ARE SUSPENDED ON CEILING JOISTS OF DESIGN-BUILD COLD FORMED METAL FRAMING. REFER TO SPECIFICATION SECTION 05 40 00 "COLD FORMED METAL FRAMING" AND STRUCTURAL NOTES.
- 4. REFER TO FINISH SCHEDULE FOR FINISHES INCLUDING, BUT NOT LIMITED TO THOSE AT CEILINGS, EXPOSED STRUCTURE, EXPOSED DUCTS AND EXPOSED PIPING.
- 5. FOR EXTERIOR LIGHTING AND ELECTRICAL DEVICES NOT MOUNTED DIRECTLY TO EXTERIOR WALLS, CONDUITS ARE TO BE INSTALLED WITHIN THE RIGID INSULATION LAYER ABOVE THE ROOF
- 7. MOTORIZED SHADES @ WINDOWS NOT SHOWN; REFER TO SPECIFICATIONS FOR LOCATIONS & QUANTITIES REQUIRED. SEE ELEVATIONS FOR HEIGHTS OF WINDOWS. COORDINATE WITH
- 8. CEILING DESTRATIFICATION FANS BY MECHANICAL DESIGNER AT MULTIPLE LOCATIONS IN FITNESS ROOM 204 AND GYM 121. COORDINATION FINAL PLACEMENT WITH ARCHITECT.
- 9. MECHANICAL EQUIPMENT SHOWN IS FOR COORDINATION PURPOSES ONLY. ACTUAL MECHANICAL DESIGN SHALL BE BY PUBLISHED MECHANICAL DRAWINGS.
- 10. WOOD SLAT CEILING SLOPE TYPICAL. LOCATE 5'-2" BELOW DECK. DESIGN INTENT FOR MEMBERS TO BE 5/4" X 3" X 8' UNLESS OTHERWISE NOTED.

LEGEND





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VEER PARK TROOM UPDATE

DESIGN DEVELOPMENT

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REFLECTED
CEILING PLAN

SCALE: As indicated
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A6.1