Please complete and submit a nonresidential design review application and the required design review narrative as a part of your re-submittal. A review of the permit application for conformance with PMC 20.26.300 Non-Residential Design Review has been provided below. Please reference these notes when updating your plans.

> Please provide the proposed siding materials. Per PMC 20.26.300 (4), acceptable siding materials include brick, stone, marble, split-face cement block, shingles, and horizontal lap siding. Other materials, such as stucco, may also be used as an accent if: (a) they are used as accent materials in conjunction with acceptable siding materials; and (b) said accent materials are characterized by details or variations in the finish that create a regular pattern of shapes, indentations, or spaces that are accented or highlighted with contrasting shades of color. [elevations, A3.0]

buildings which contain two or more stories and that will be visible from a public street shall not be wider than two and one-half times the height of the wall plane per PMC 20.26.300 (1)(a). Please adjust elevations accordingly to meet this standard. [elevations, A3.0]

The wall plane for

The north elevation is required to have no less than 60% of the surface area of the surface area of the wall consist of windows and/or transparent doorways (PMC 20.26.300 (3)(d)). Please update the elevations to meet this requirement and provide calculations on the elevation plans proving that the 60% requirement is being met. [elevations, A3.0]

2 North 1/4" = 1'-0"


Per PMC 20.26.300 (1)(c), for continuous rooflines that exceed 50


feet in length on buildings with a flat, gabled, hopped, or similar roof, or on a roofline with slopes of less than three feet vertical to 12 feet horizontal, the following methods shall be used:

(i) The height of the visible roofline must change at least four feet if the adjacent roof segments are less than 50 feet in length.

(ii) The height of the visible roofline must change at least eight feet if the adjacent roof segments are 50 feet or more in length.

Please adjust plans accordingly. [elevations, A3.0]

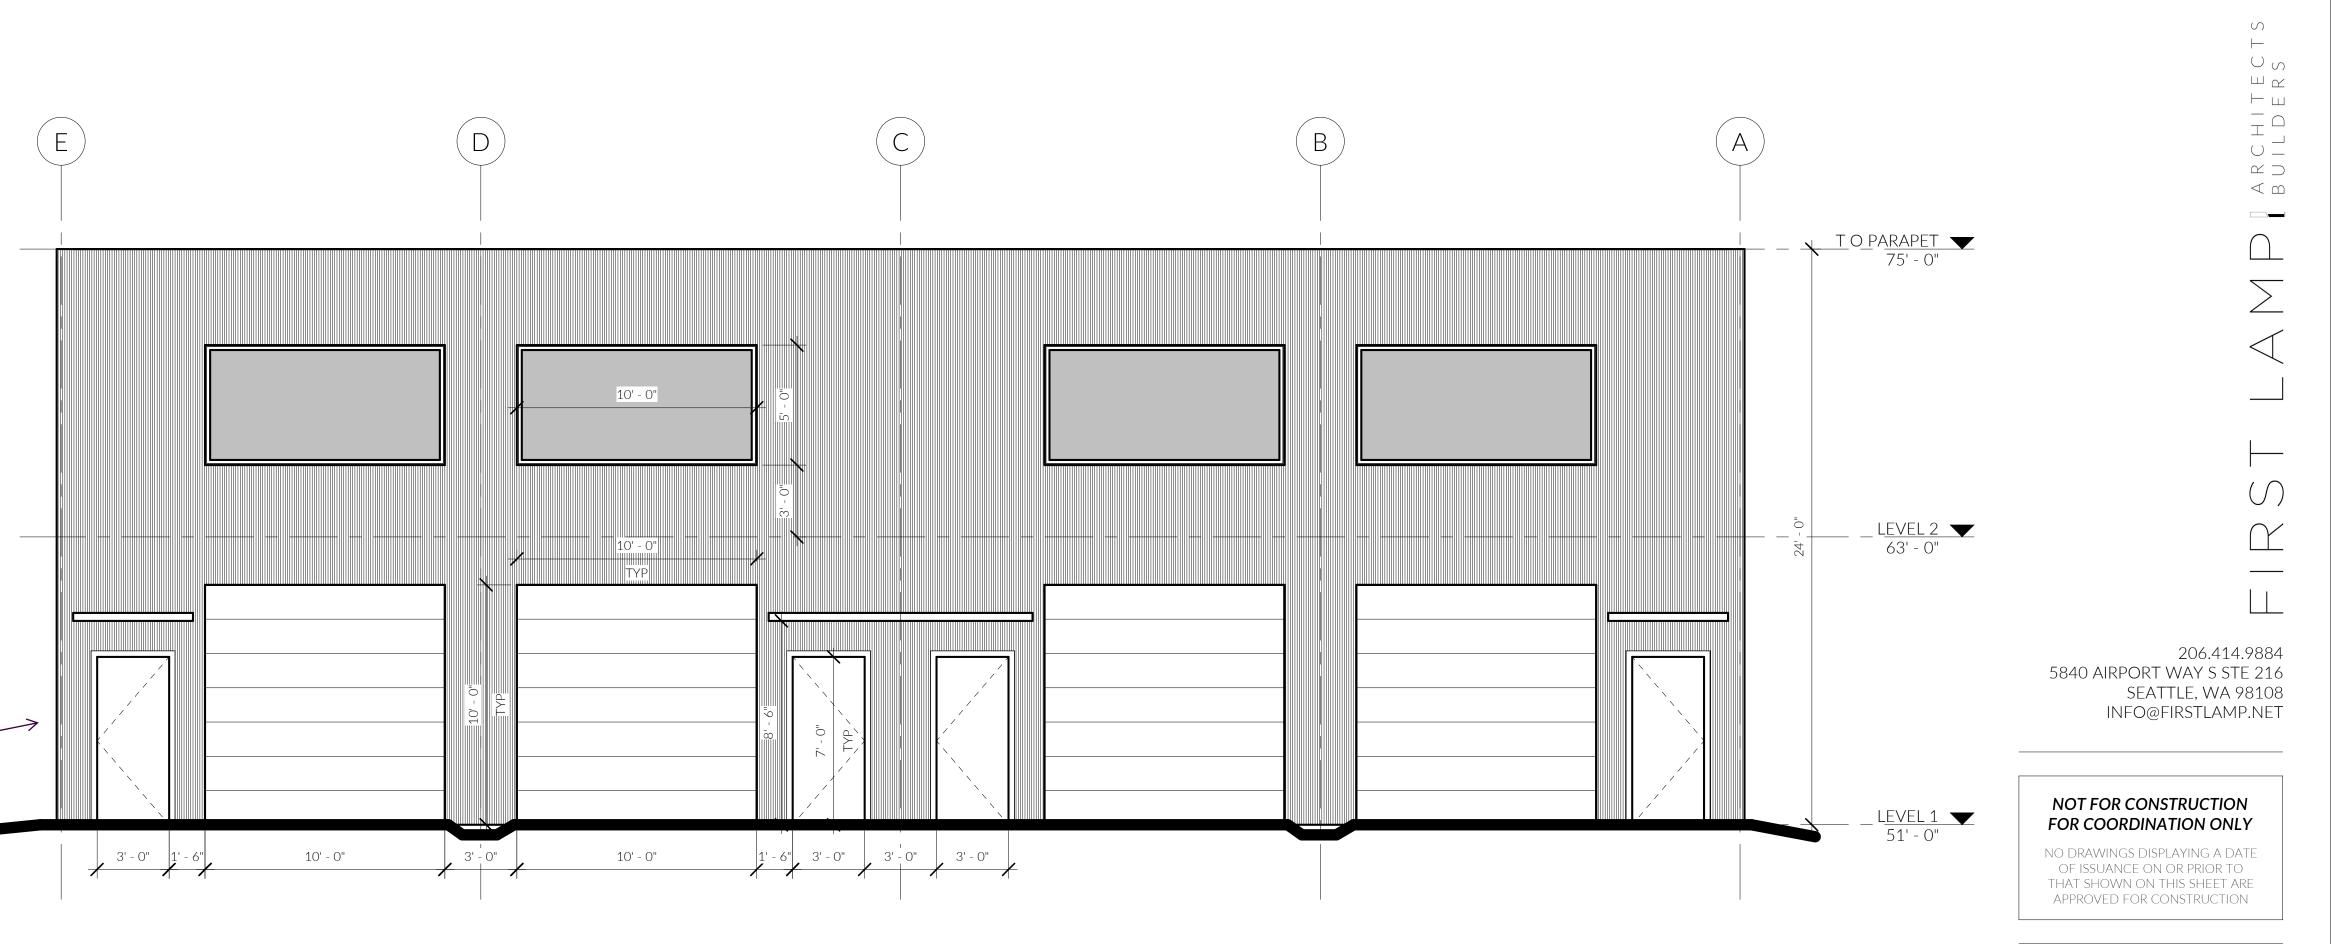

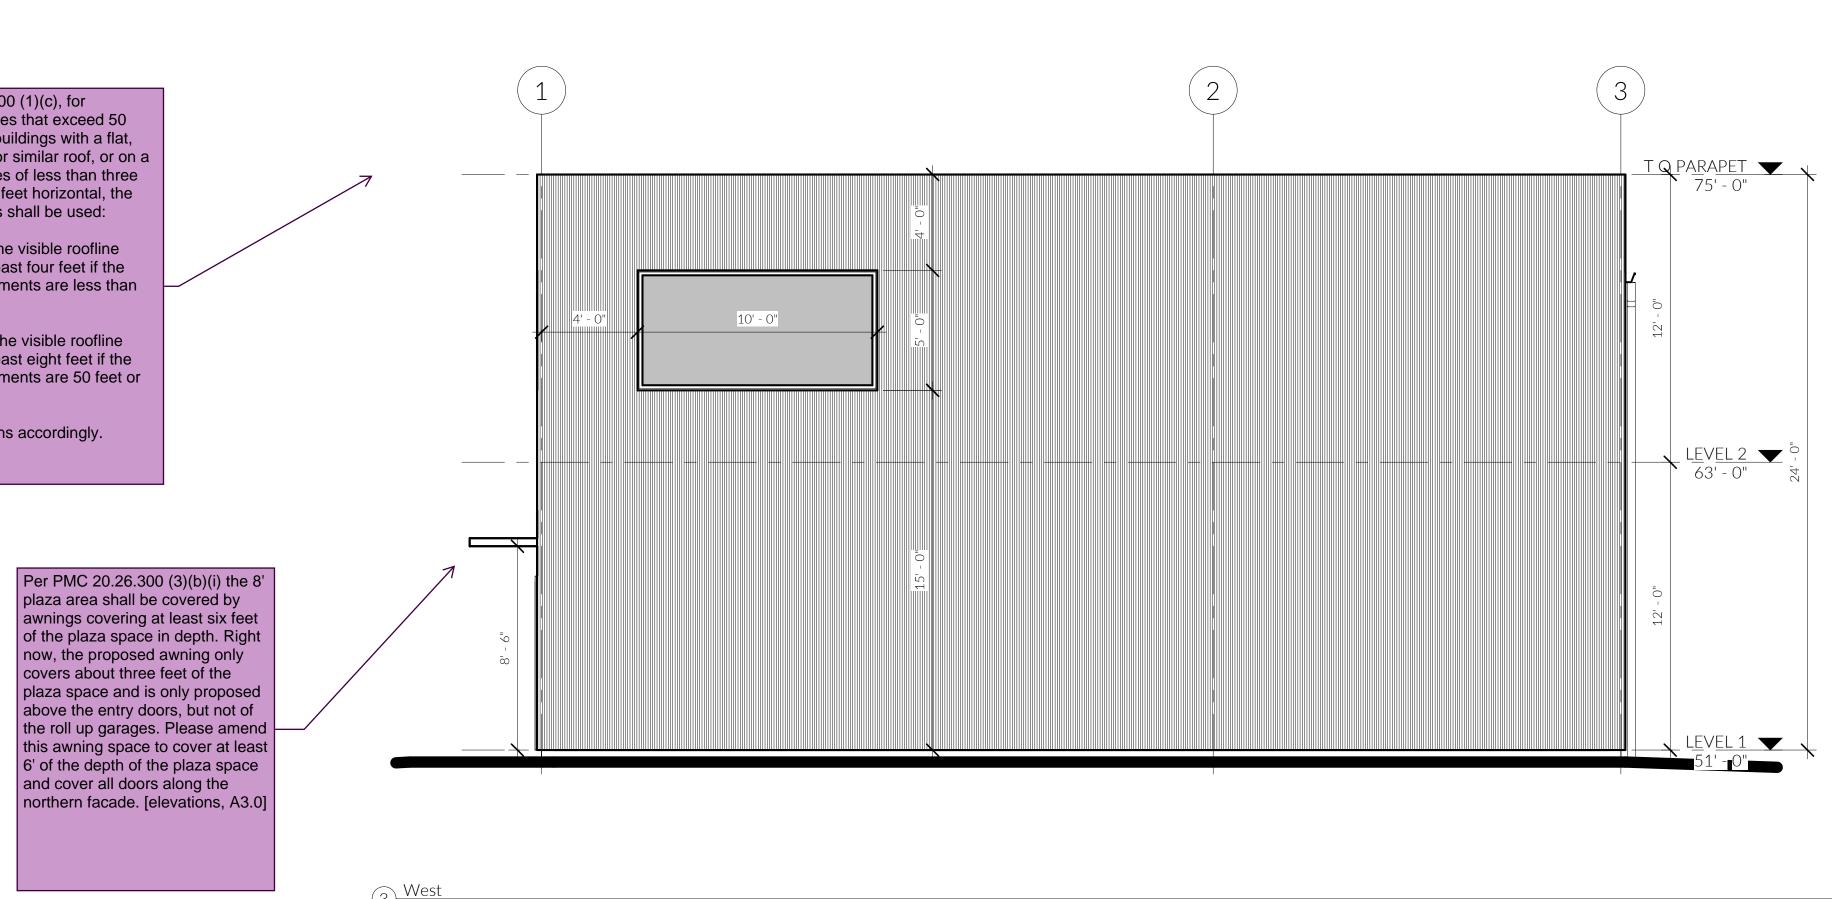

3 West 1/4" = 1'-0"



MUNICIPAL APPROVAL STAMPS


2203 12/2/22

REVISIONS NO. DESCRIPTION DATE

DRAWN BY:

K. WITT

ELEVATIONS

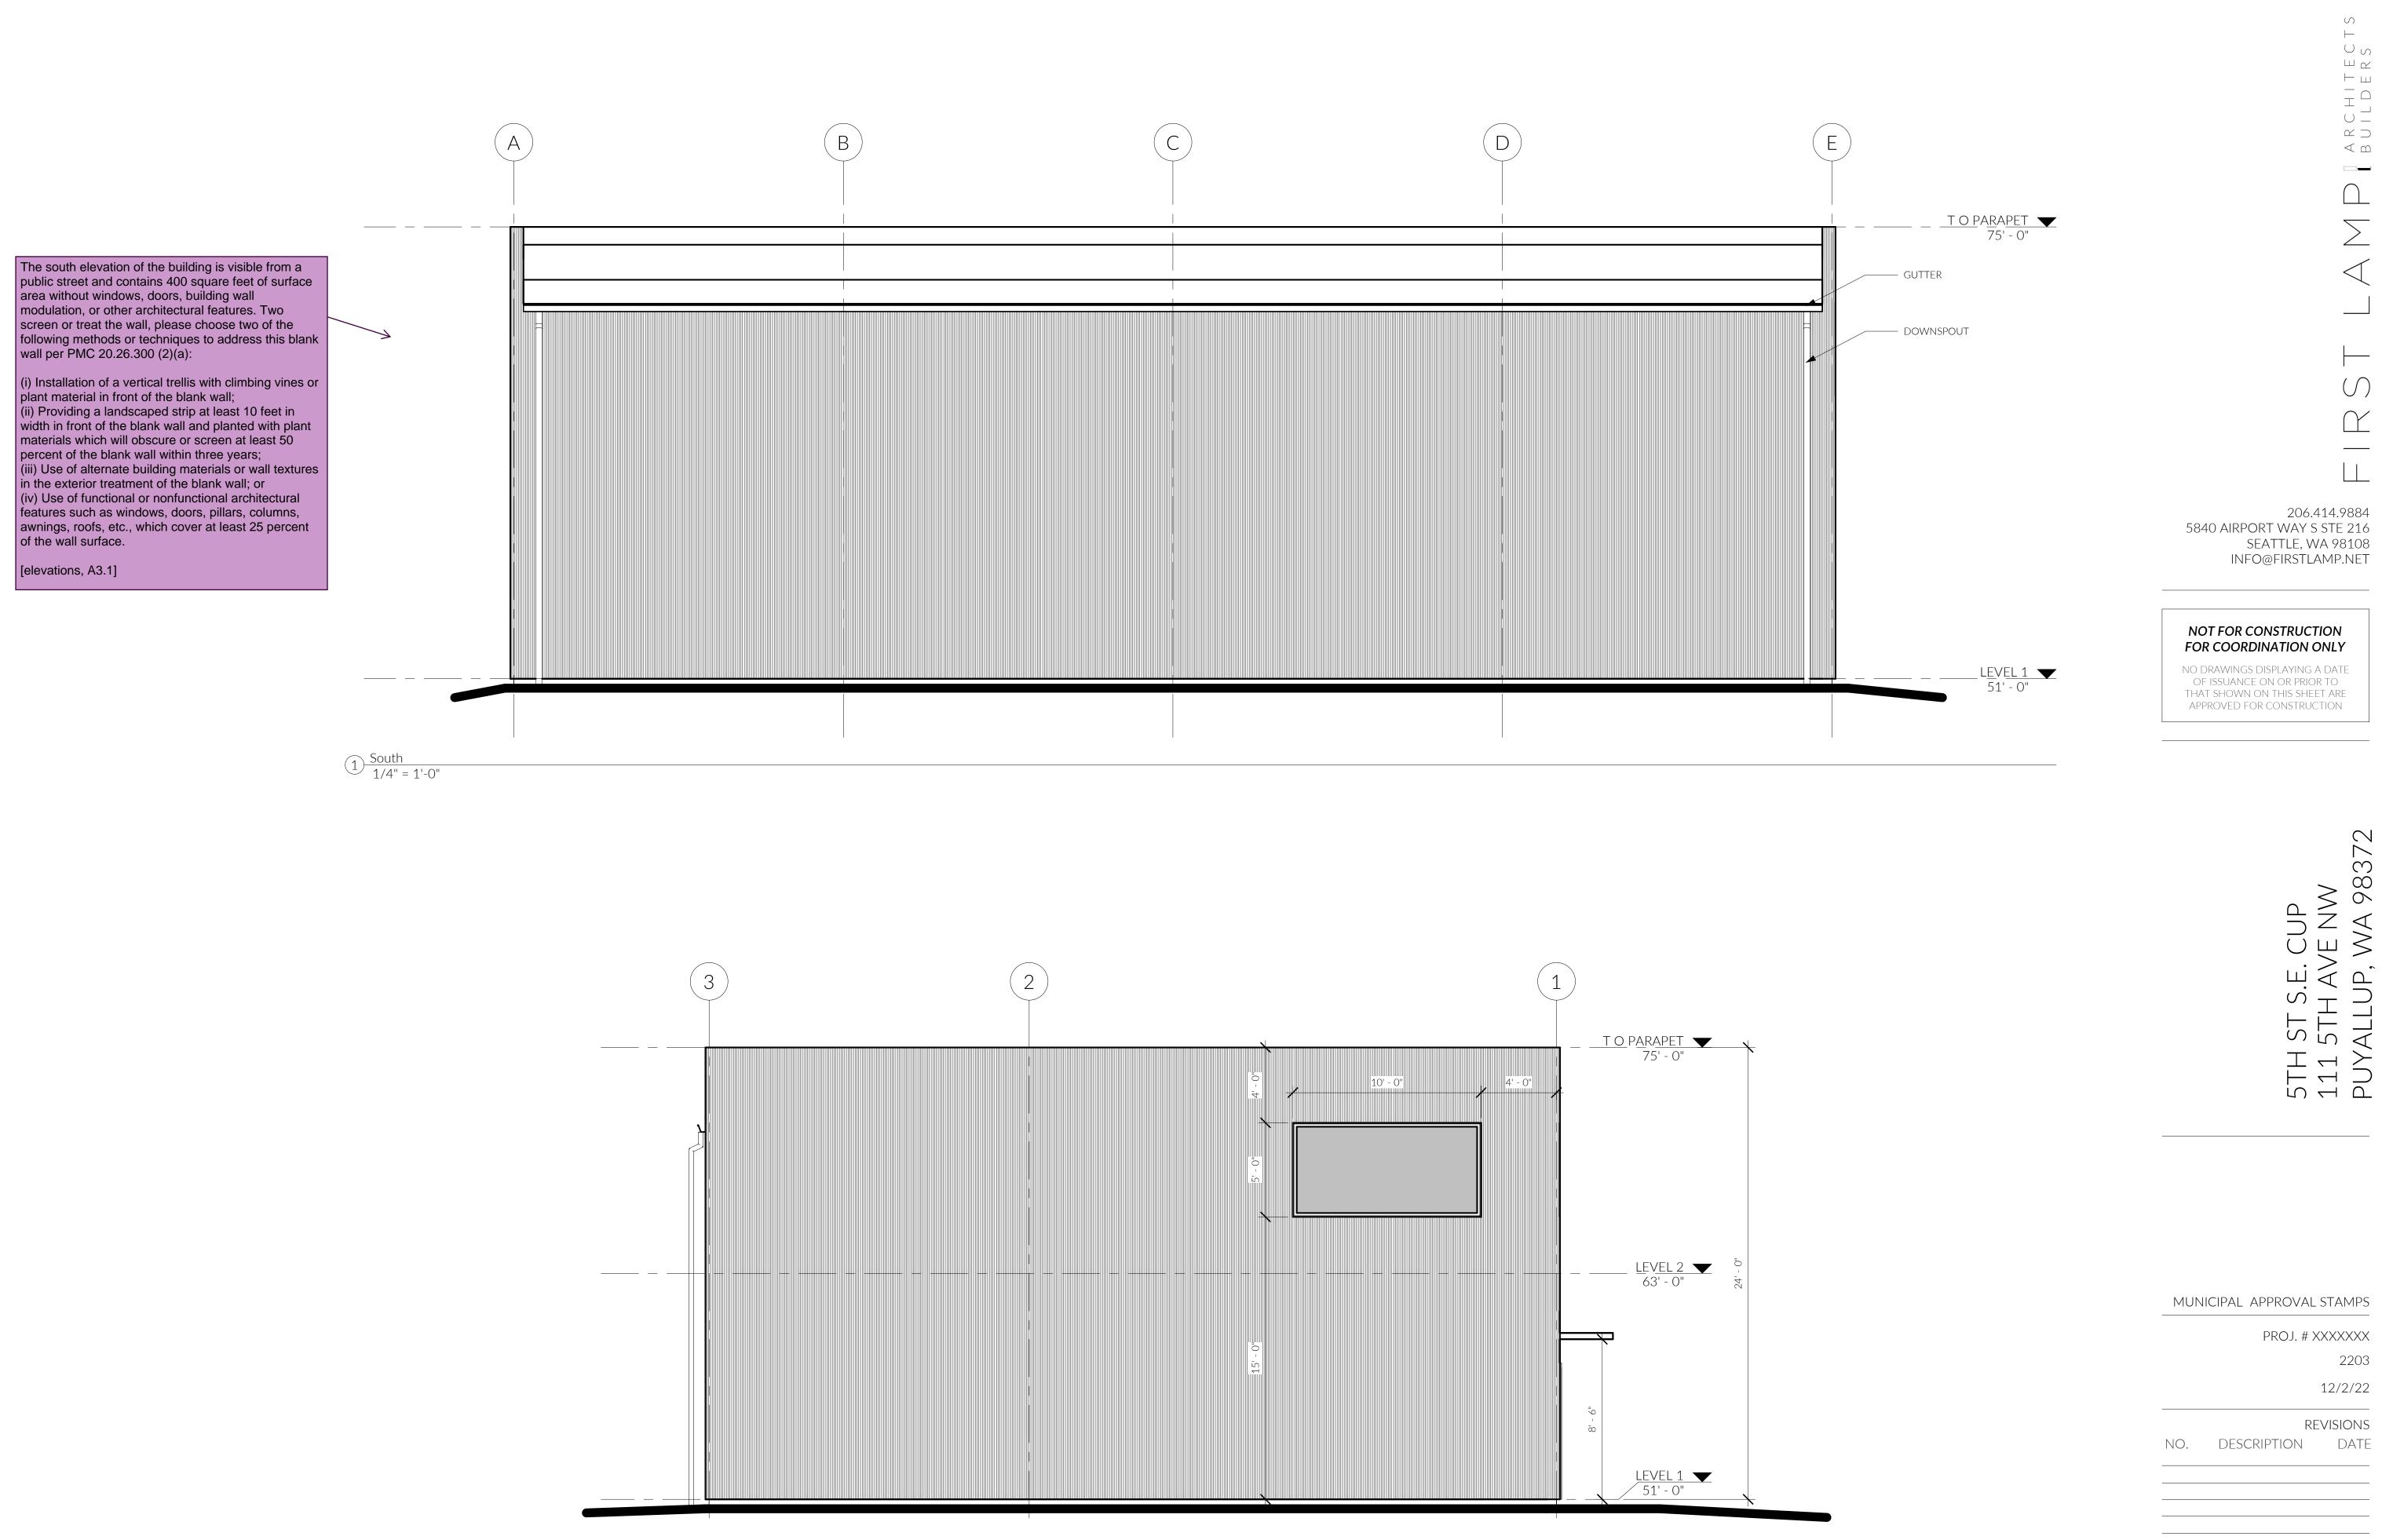

2 East 1/4" = 1'-0"

EACH DWELLING UNIT TO BE EQUIPPED WITH TRICKLE VENTS TO MEET THE SEATTLE MECHANICAL CODE REQUIREMENTS WITH A MIN. VENTING SPACE OF 4 SQ. INCHES OF NET FREE AREA IN EACH OCCUPIABLE SPACE. WINDOWS WITH OPENINGS LESS THAN 36" ABOVE FINISH FLOOR TO BE EQUIPPED WITH OPENING CONTROL DEVICES COMPLYING WITH SBC 1013.8.1 (EXCEPTION 4).

NOTE:

PROJ. # XXXXXXX
2203
12/2/22

K. WITT

ELEVATIONS

DRAWN BY: